



FRONT ELEVATION: SCALE: 1/8"=1'-0"

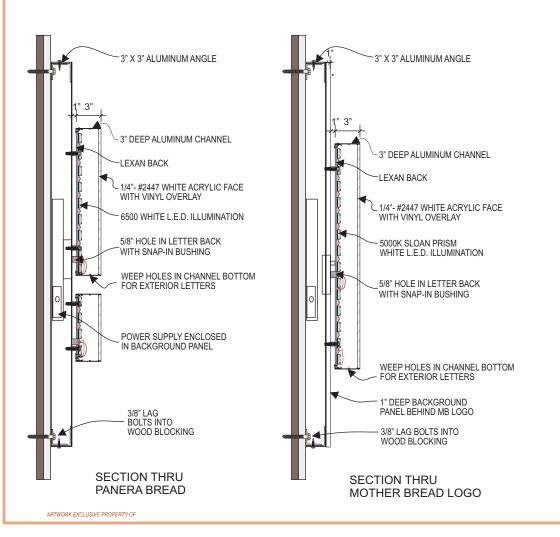

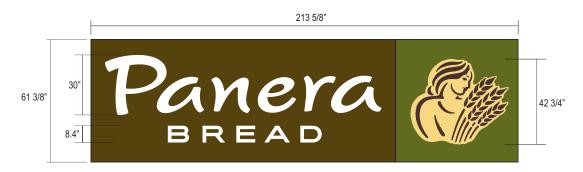

SCALE: 1/4" = 1'-0" 91.90 S/F

INTERNALLY ILLUMINATED FRONT LIT/HALO LIT CHANNEL LETTERS: "PANERA BREAD" LETTERS

- 2447 WHITE FACES WITH 3" DEEP CHANNELS PAINTED BLACK
- CLEAR LEXAN BACKS
- 6500 WHITE LED LIGHTING (PANERA BREAD) 5000K SLOAN PRISM (MOTHER BREAD)
- TRIMLESS DESIGN
- MB LOGO WITH PANTONE 7403 CP INTERNALLY LIT/HALO LIT TRANSLUCENT BACKGROUND & PANTONE 476 CP DETAILS
- 3" DEEP CHANNEL PAINTED TO MATCH PANTONE 476 CP
- 3" DEEP BACKGROUND PANEL PAINTED TO MATCH PANTONE 476 CP WITH 1" THICK SUPER IMPOSED PANEL BEHIND MB LOGO PAINTED PANTONE 5757 CP
- ALL GRAPHICS TO BE PINNED OFF PANEL 1"
- SELF CONTAINED POWER SUPPLIES



	REVISIONS											
NO.	BY	DESCRIPTION	DATE									
1	JM	added roof top AC unit	01/10/20									
2												
3												
4												
5												
6												
7												
8												
9												
10												
11												
12												

CLIENT



75-77 Fort Eddy Road Concord, NH 03301

#3409

LOCATION

JIM MANDEVILLE PROJECT MANAGER


JM 10/17/19
ARTIST DATE

SCALE NOTED

51274.2



SIDE ELEVATION: SCALE: 1/8"=1'-0"

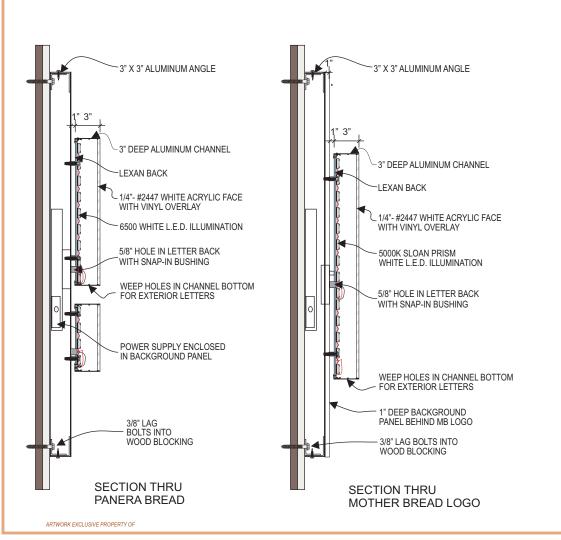





SCALE: 3/8"=1'-0"

INTERNALLY ILLUMINATED FRONT LIT/HALO LIT CHANNEL LETTERS: "PANERA BREAD" LETTERS

- 2447 WHITE FACES WITH 3" DEEP CHANNELS PAINTED BLACK
- CLEAR LEXAN BACKS
- 6500 WHITE LED LIGHTING (PANERA BREAD) 5000K SLOAN PRISM (MOTHER BREAD)
- TRIMLESS DESIGN
- MB LOGO WITH PANTONE 7403 CP INTERNALLY LIT/HALO LIT TRANSLUCENT BACKGROUND & PANTONE 476 CP DETAILS
- 3" DEEP CHANNEL PAINTED TO MATCH PANTONE 476 CP
- 3" DEEP BACKGROUND PANEL PAINTED TO MATCH PANTONE 476 CP WITH 1" THICK SUPER IMPOSED PANEL BEHIND MB LOGO PAINTED PANTONE 5757 CP
- ALL GRAPHICS TO BE PINNED OFF PANEL 1"
- SELF CONTAINED POWER SUPPLIES

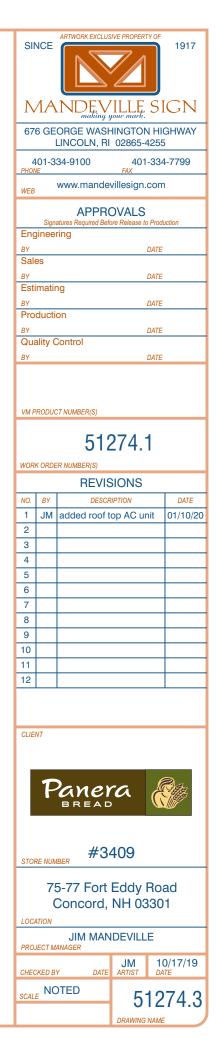

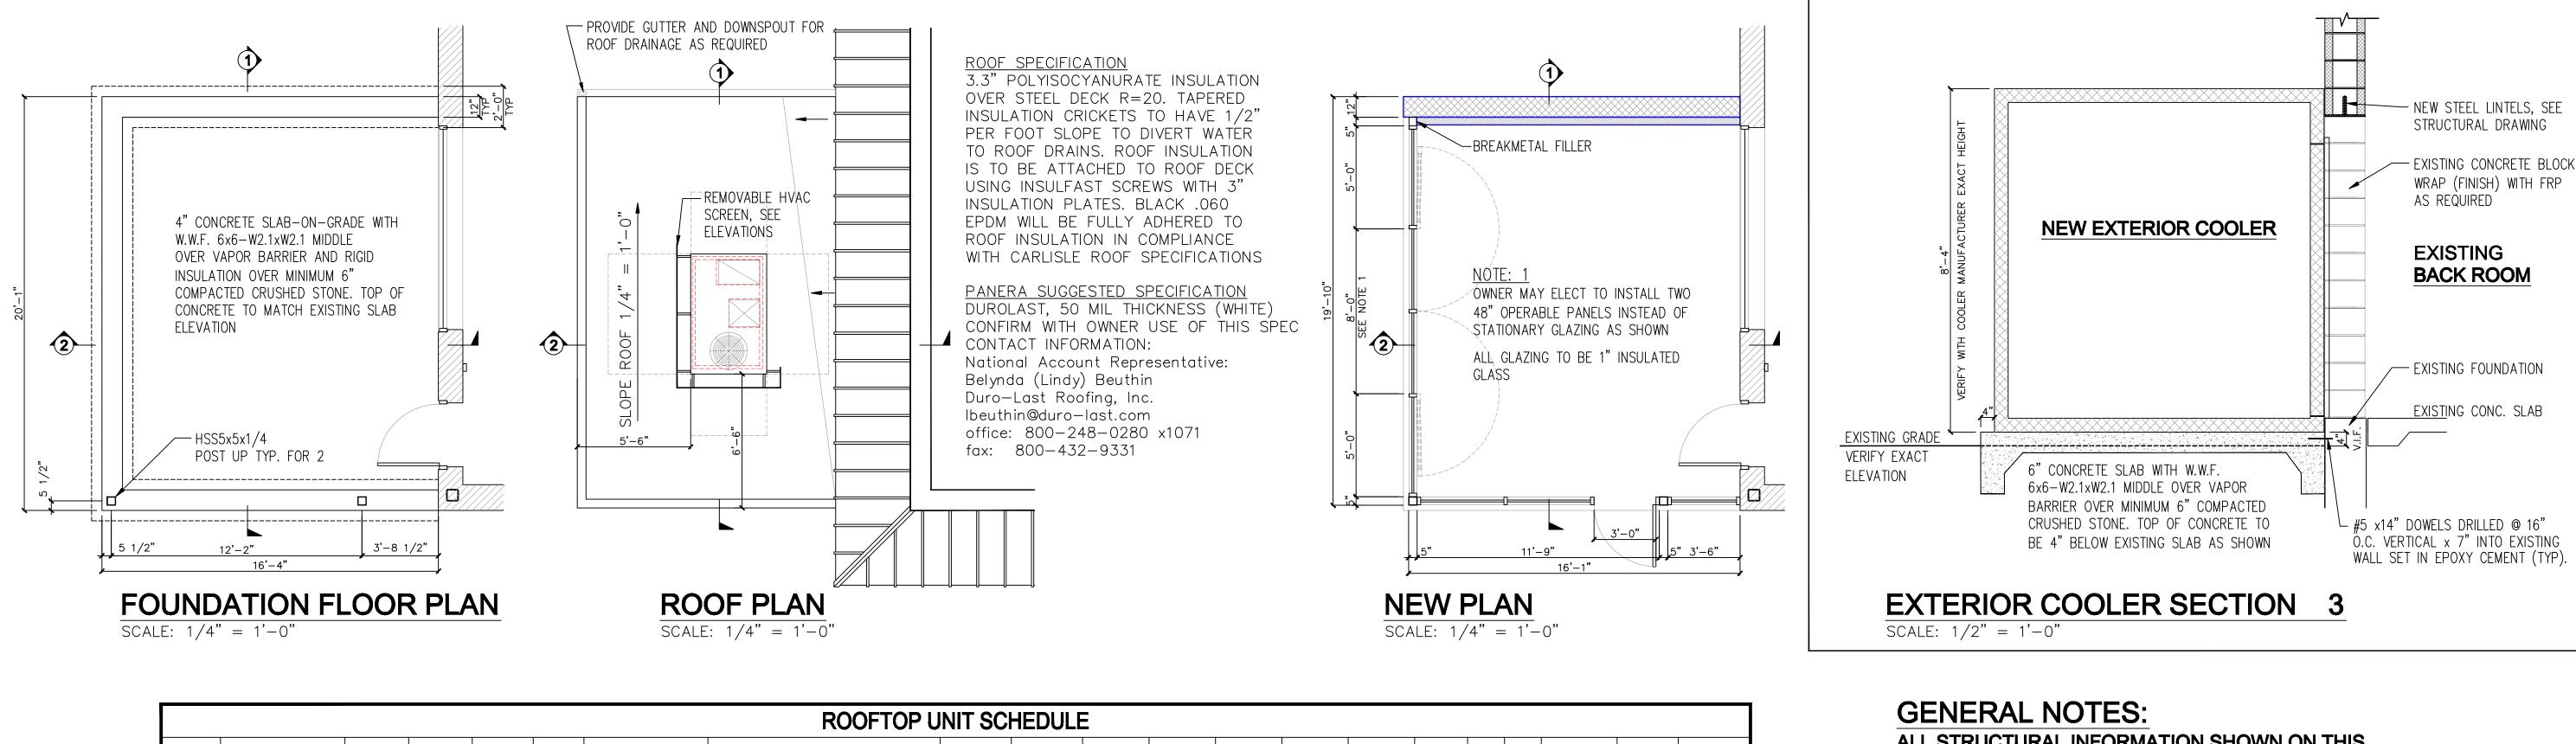

ROOFTOP UNIT SCHEDULE																							
PLAN MARK	MANUFACTURER MODEL NUMBER	SUPPLY AIR (CFM)	OUTSIDE AIR (CFM) MIN.	EXTERNAL S.P. IN (WC)	MOTOR	COOLING CAPACITY		HEATING CAPACITY			DRY BULB	WET BULB	AMBIENT	FILTER	HEATING	COOLING	T-STAT					OPERATING	
						MBH/TON	EER/SEER	NG INPUT(MBH)	NG OUTPUT (MBH)	ELEC. KW		RING AIR REES F	AIR (DEG F)	TYPE	STAGE(S)	STAGE(S)	TYPE	VOLTS	PH	HZ	MCA/MOCP	WEIGHT LBS.	NOTES
RTU-1	TRANE YSH036	1200	270	0.35"	1.5 HP	36/3	12.0/14.0	100	70	-	80	67	91*	MERV 8	ONE	ONE	ONE PIECE PROGRAM.	208	3	60	20/30	600	1-7
				•	•	•		•	•	•		•		•	•			•					

2. FURNISH UNIT WITH ENTHALPY ECONOMIZER & BAROMETRIC RELIEF DAMPER.


1. FURNISH ROOF 8" CURB FOR INSTALLATION.

- 3. RUN CONDENSATE LINE TO NEAREST GRADE (NON-NUISANCE APPROVED LOCATION).
- 4. PROVIDE W/ NON FUSIBLE DISCONNECT SWITCH.
- 5. PROVIDE W/ CORROSION PROTECTION COAT. 6. PROVIDE W/ CONCENTRIC DIFFUSER.
- 7. PROVIDE WITH CO2 SENSOR T-STAT.

ALL STRUCTURAL INFORMATION SHOWN ON THIS PLAN IS FOR GUIDANCE ONLY. SEE STRUCTURAL PLANS FOR ACTUAL STRUCTURAL WORK

CONTRACTOR TO FIELD VERIFY GAS AND ELECTRICAL **AVAILABILITY AND LOCATIONS FOR NEW ROOF TOP UNIT AND CONNECT AS REQUIRED**

PROVIDE 8" CURB FOR HVAC UNIT AS NOTED IN THE **ROOFTOP UNIT SCHEDULE.**

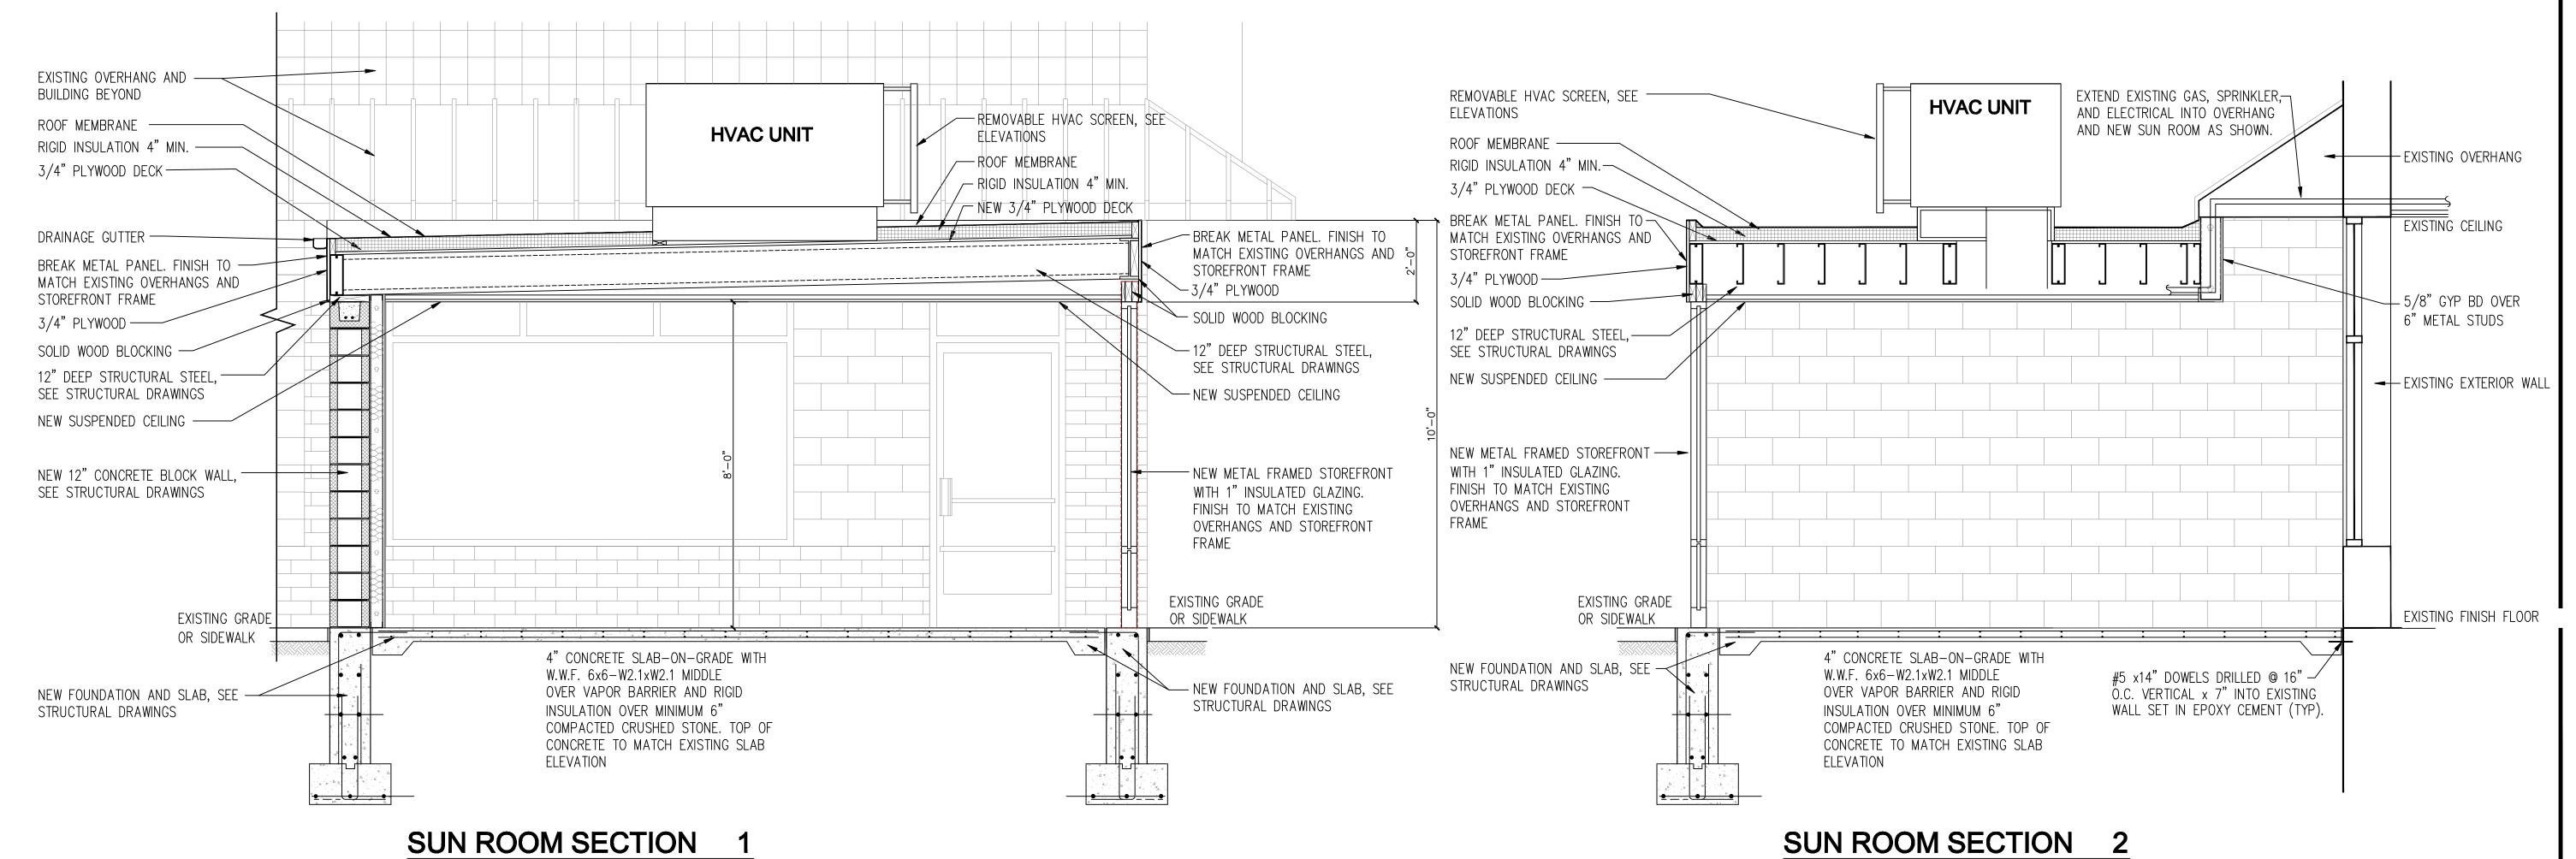

SCALE: 1/2" = 1'-0"


SCALE: 1/2" = 1'-0"

BREAD®

<u>q</u> O

ARCHITECT: JAMES GILMOUR ARCHITECTVRE
200 WINTER STREET HOLLISTON, MA 01746 (T)508.380.3105

NNERA BREAD
REMODEL

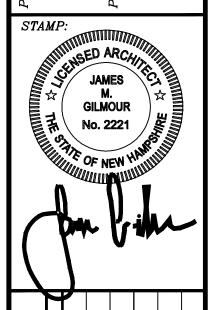

SHEET TITLE:

EXTERIOR WORK DETAILS

SHEET NO. **11**0*F* **12** SHEET NO.

PANERA BREAD

CONCORD, NH



