

SITE CONSTRUCTION PLANS

- TAX MAP 7412Z LOTS 25 & 26 -

FLATLEY APARTMENTS

(32 SOUTH MAIN STREET) CONCORD, NEW HAMPSHIRE DATE: FEBRUARY 16, 2022

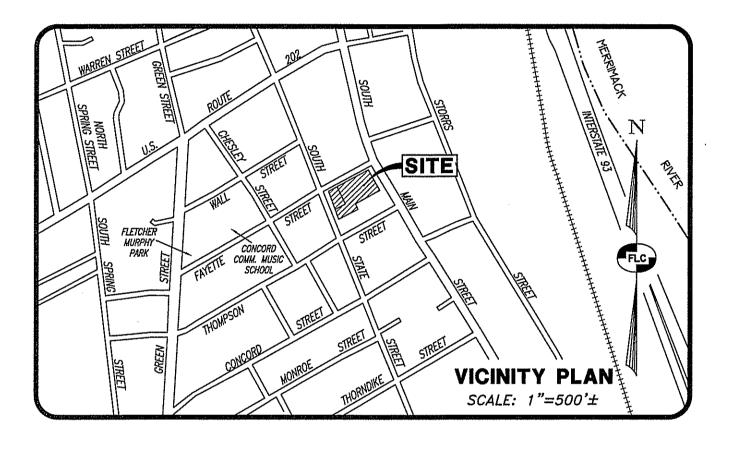

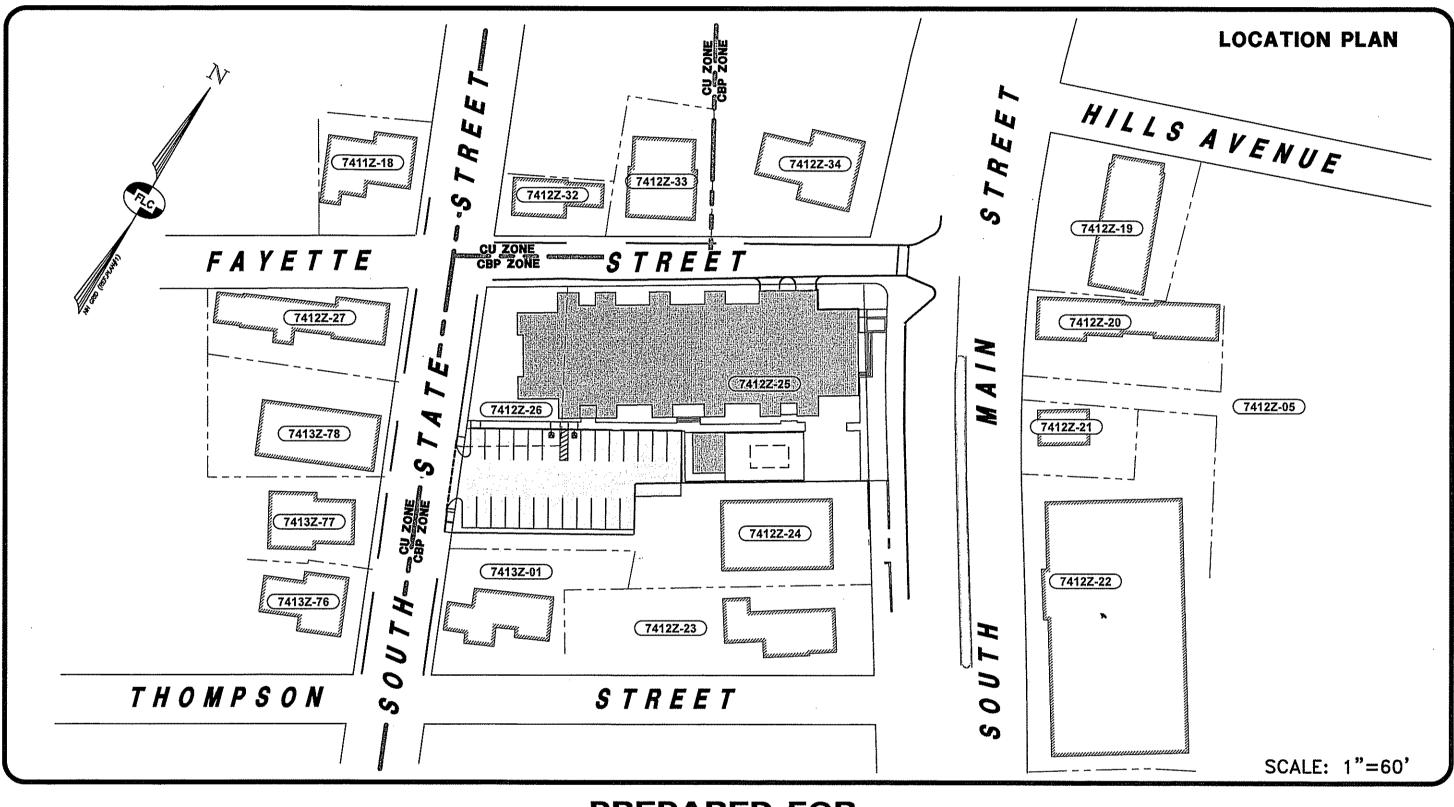

SHEET INDEX PAGE SHEET TITLE COVER SHEET CV-1SP-1 SITE PLAN EXISTING CONDITIONS PLAN CONSOLIDATION PLAN DEMOLITION PLAN GRADING & DRAINAGE PLAN UTILITIES PLAN LIGHTING PLAN LANDSCAPING PLAN CONSTRUCTION DETAILS CONSTRUCTION DETAILS DRAINAGE DETAILS EROSION CONTROL NOTES & DETAILS

CITY OF CONCORD CONTACTS:

- **ENGINEERING:** 41 GREEN STREET 3 rd FLOOR CONCORD, NH 03301 ATTN: DAVID CEDARHOLM (CITY ENGINEER) (603) 225-8520
- FIRE DEPARTMENT: CONCORD FIRE DEPARTMENT 24 HORESHOE POND LANE CONCORD, NH 03301 ATTN: SEAN BROWN (FIRE CHIEF) (603) 225-8650
- 125 HALL STREET CONCORD, NH 03301 ATTN: DAN DRISCOLL (SUPERINTENDENT) (603) 225-8691

UTILITY CONTACTS:

- GENERAL SERVICES (PUBLIC WORKS)
 311 NORTH STATE STREET CONCORD, NH 03301 ATTN: CHIP CHESLEY (DIRECTOR OF GENERAL SERVICES) (603) 228-2737
- GAS: LIBERTY UTILITES 116 NORTH MAIN STREET CONCORD, NH 03301 (800) 833-4200
- UNITIL (CAPITOL ELECTRIC) 5 McGUIRE STREET CONCORD, NH 03301 (888) 301-7700

PREPARED FOR:


JCHRELATLEY


45 DAN ROAD, SUITE 320 **CANTON, MA 02021** PH (781) 380-7731

LAND OF: CITY OF CONCORD

41 GREEN STREET CONCORD, NH 03301-4255 PH (603) 225-8610



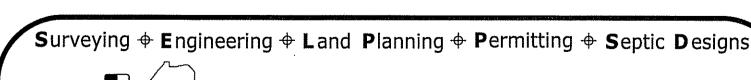

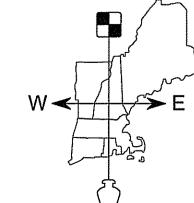

FIELDSTONE LAND CONSULTANTS, PLEC


206 Elm Street, Milford, NH 03055 Phone: (603)-672-5456 Fax: (603)-413-5456 www.FieldstoneLandConsultants.com

CITY PLANNING BOARD

CITY OF CONCORD, NEW HAMPSHIRE In accordance with vote of the board dated:

Approval of the plat is limited to lots as shown.

REV. DATE DESCRIPTION C/O DR C	
FILE: 2965CV00.dwg PROJ. NO. 2965.00 SHEET: CV-1 PAGE NO. 1 OF 13	

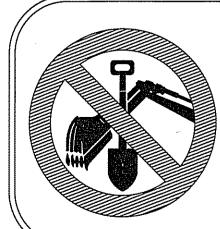


1. THE LOCATION OF THE UTILITIES SHOWN ARE APPROXIMATE. IT IS THE RESPONSIBILITY OF THE CONTRACTOR TO LOCATE AND PRESERVE ALL UTILITY SERVICES.


THE CONTRACTOR IS RESPONSIBLE FOR CONTACTING AND COORDINATING WITH ALL JURISDICTIONAL AGENCIES AND UTILITY COMPANIES PRIOR TO AND DURING CONSTRUCTION.


THE CONTRACTOR SHALL VERIFY ALL DIMENSIONS AND PROPOSED WORK PRIOR TO CONSTRUCTION.


> CONTACT DIG SAFE 72 HOURS PRIOR TO CONSTRUCTION DIGSAFE.COM OR DIAL 81


> > CALL BEFORE YOU DIG

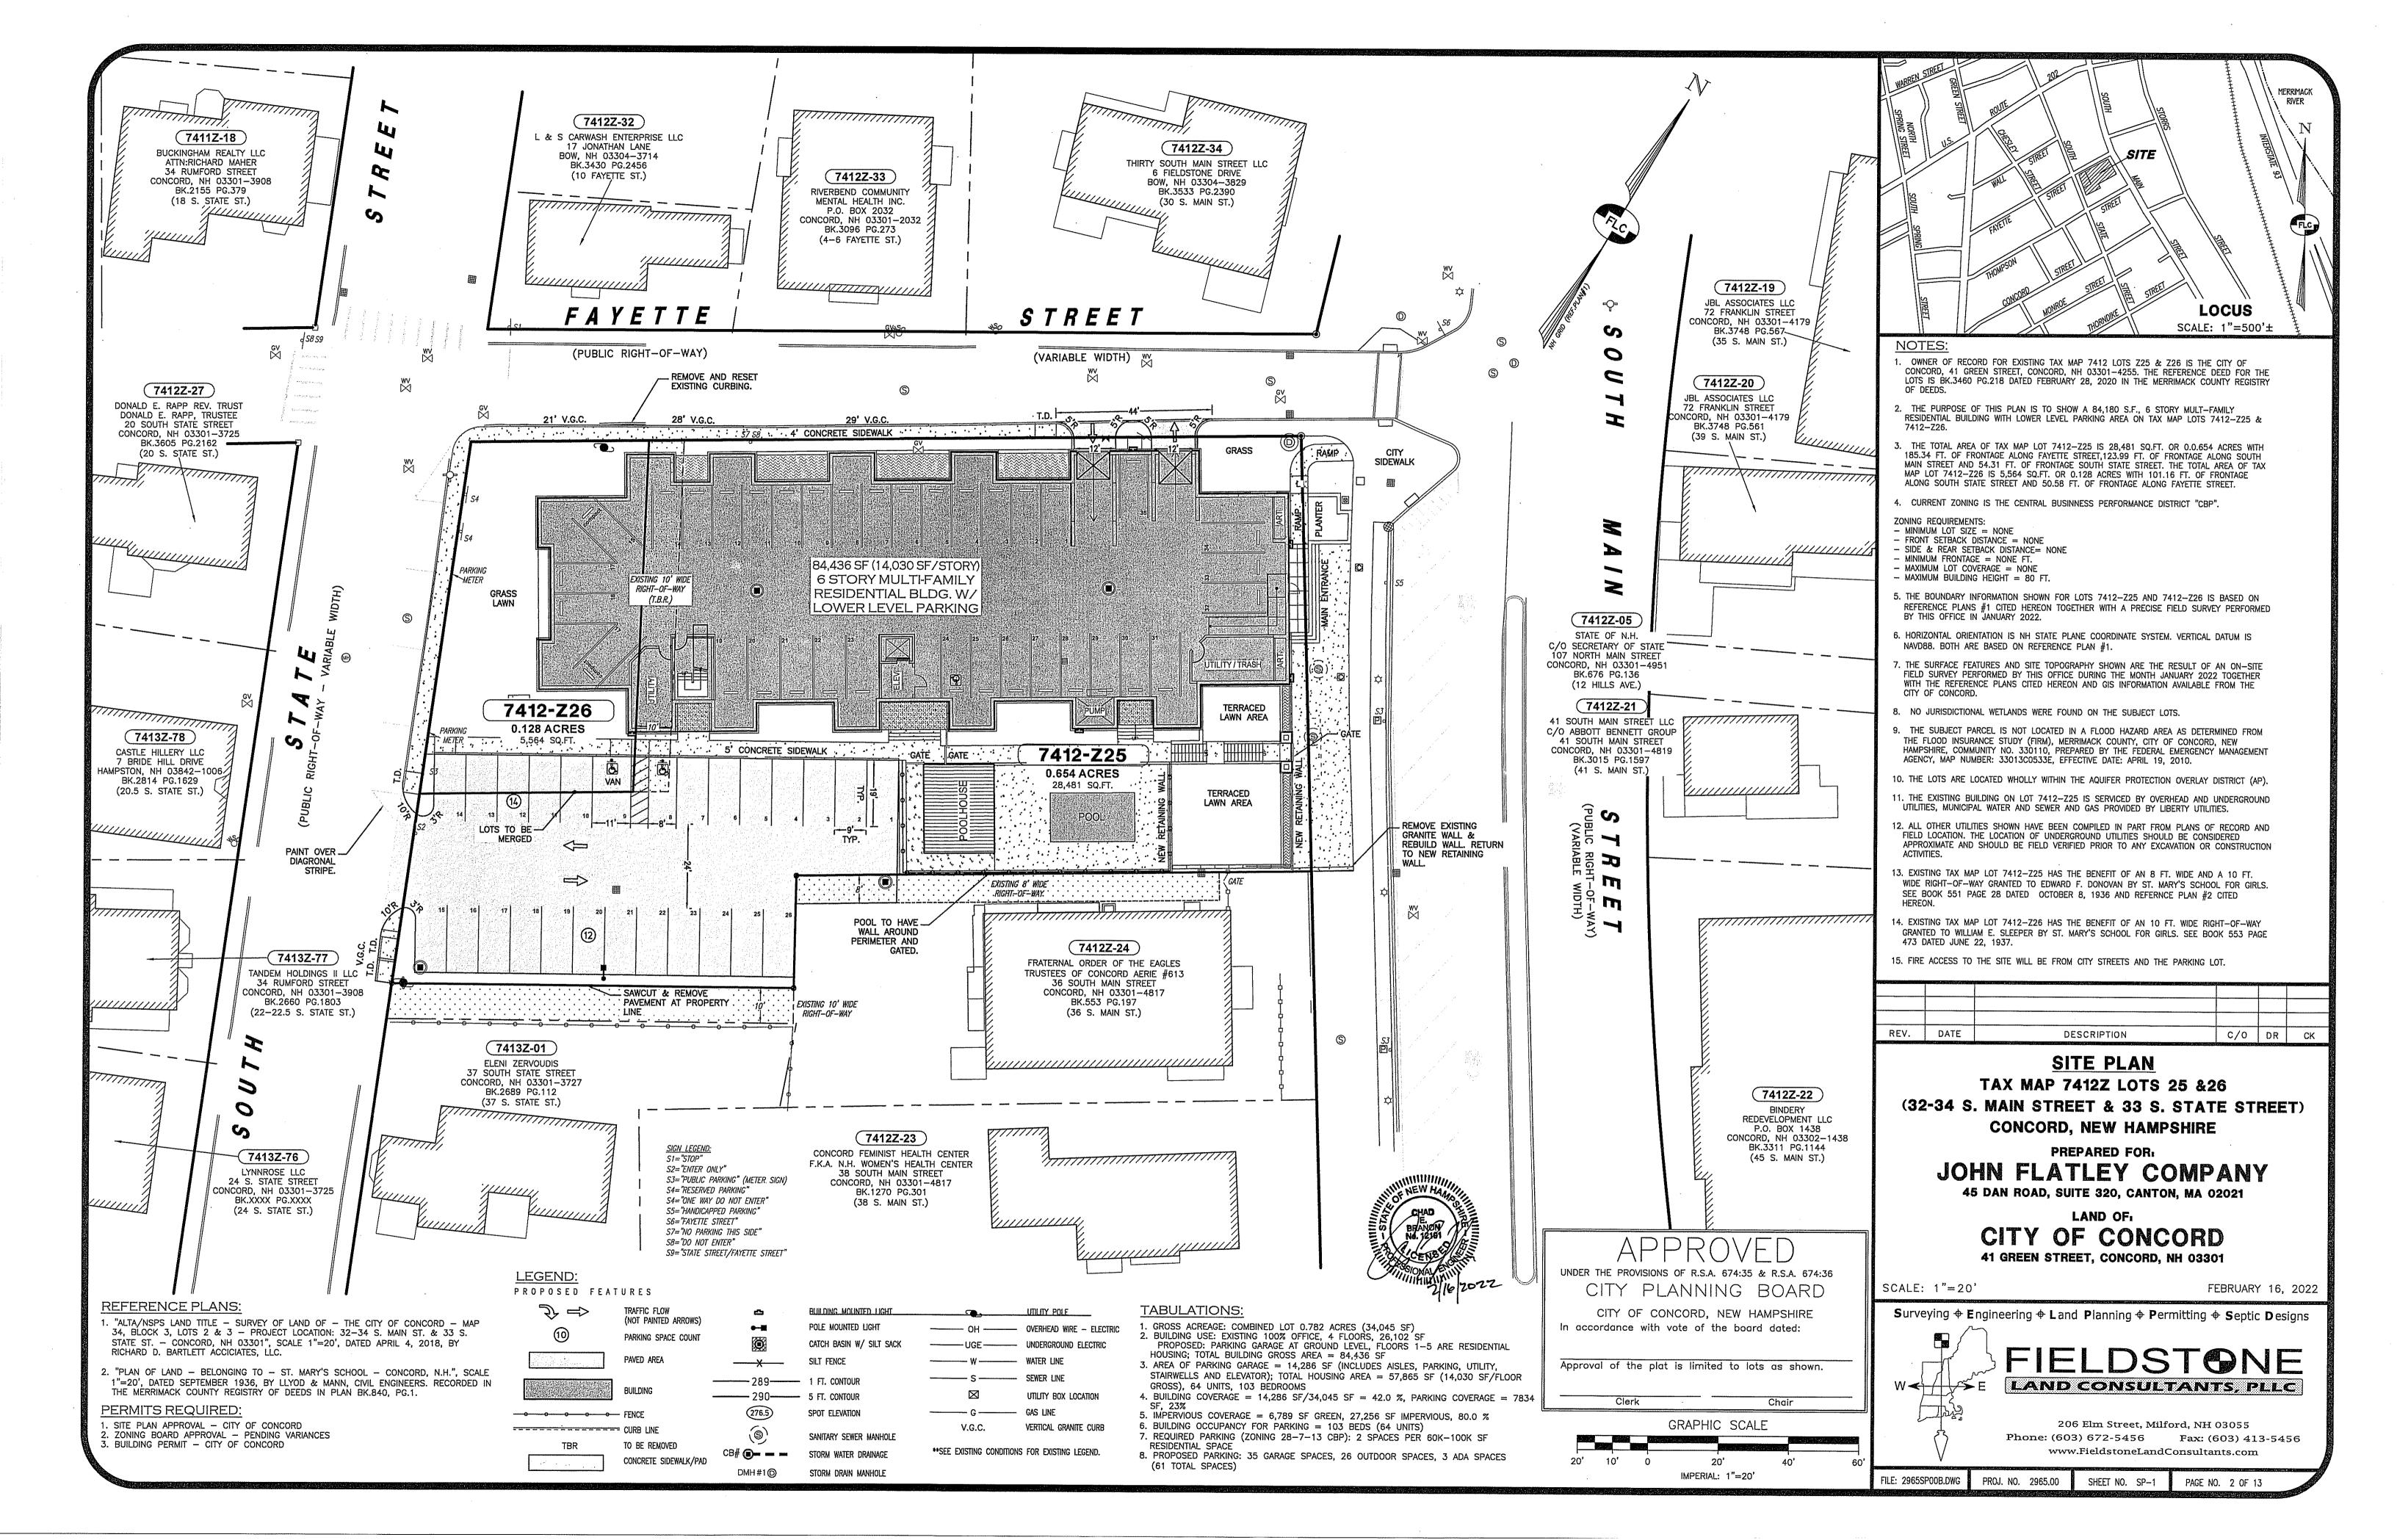


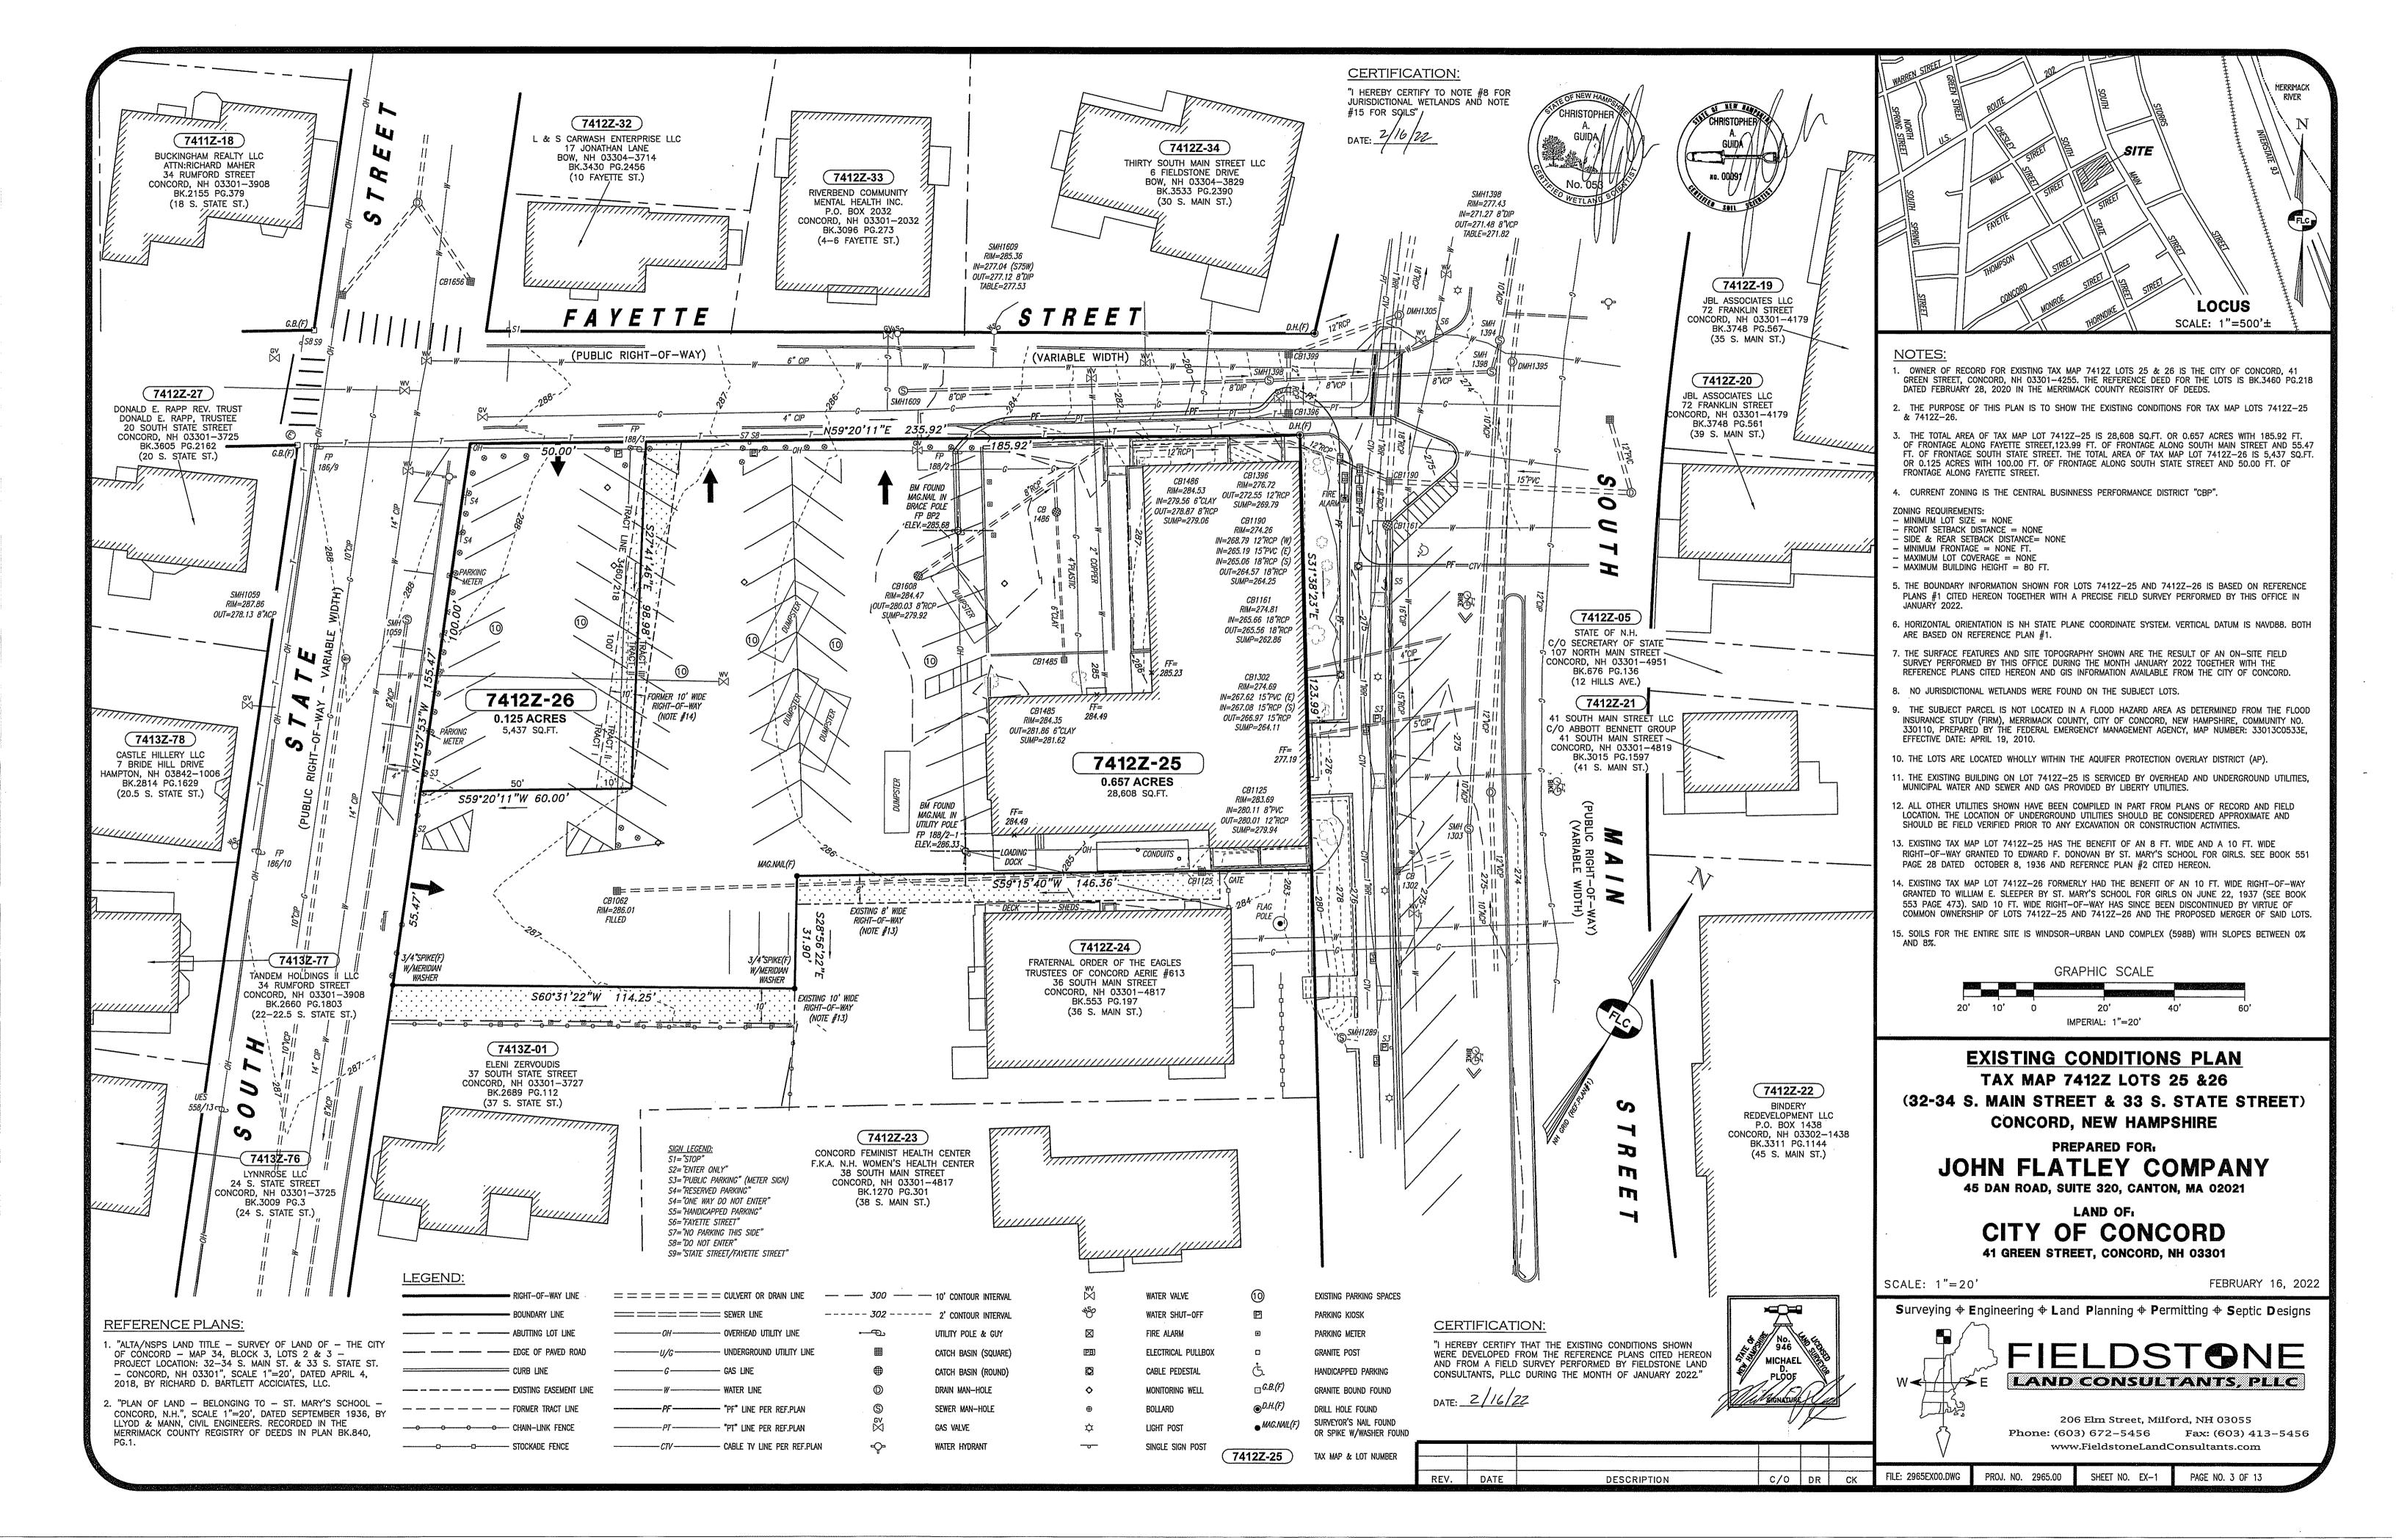


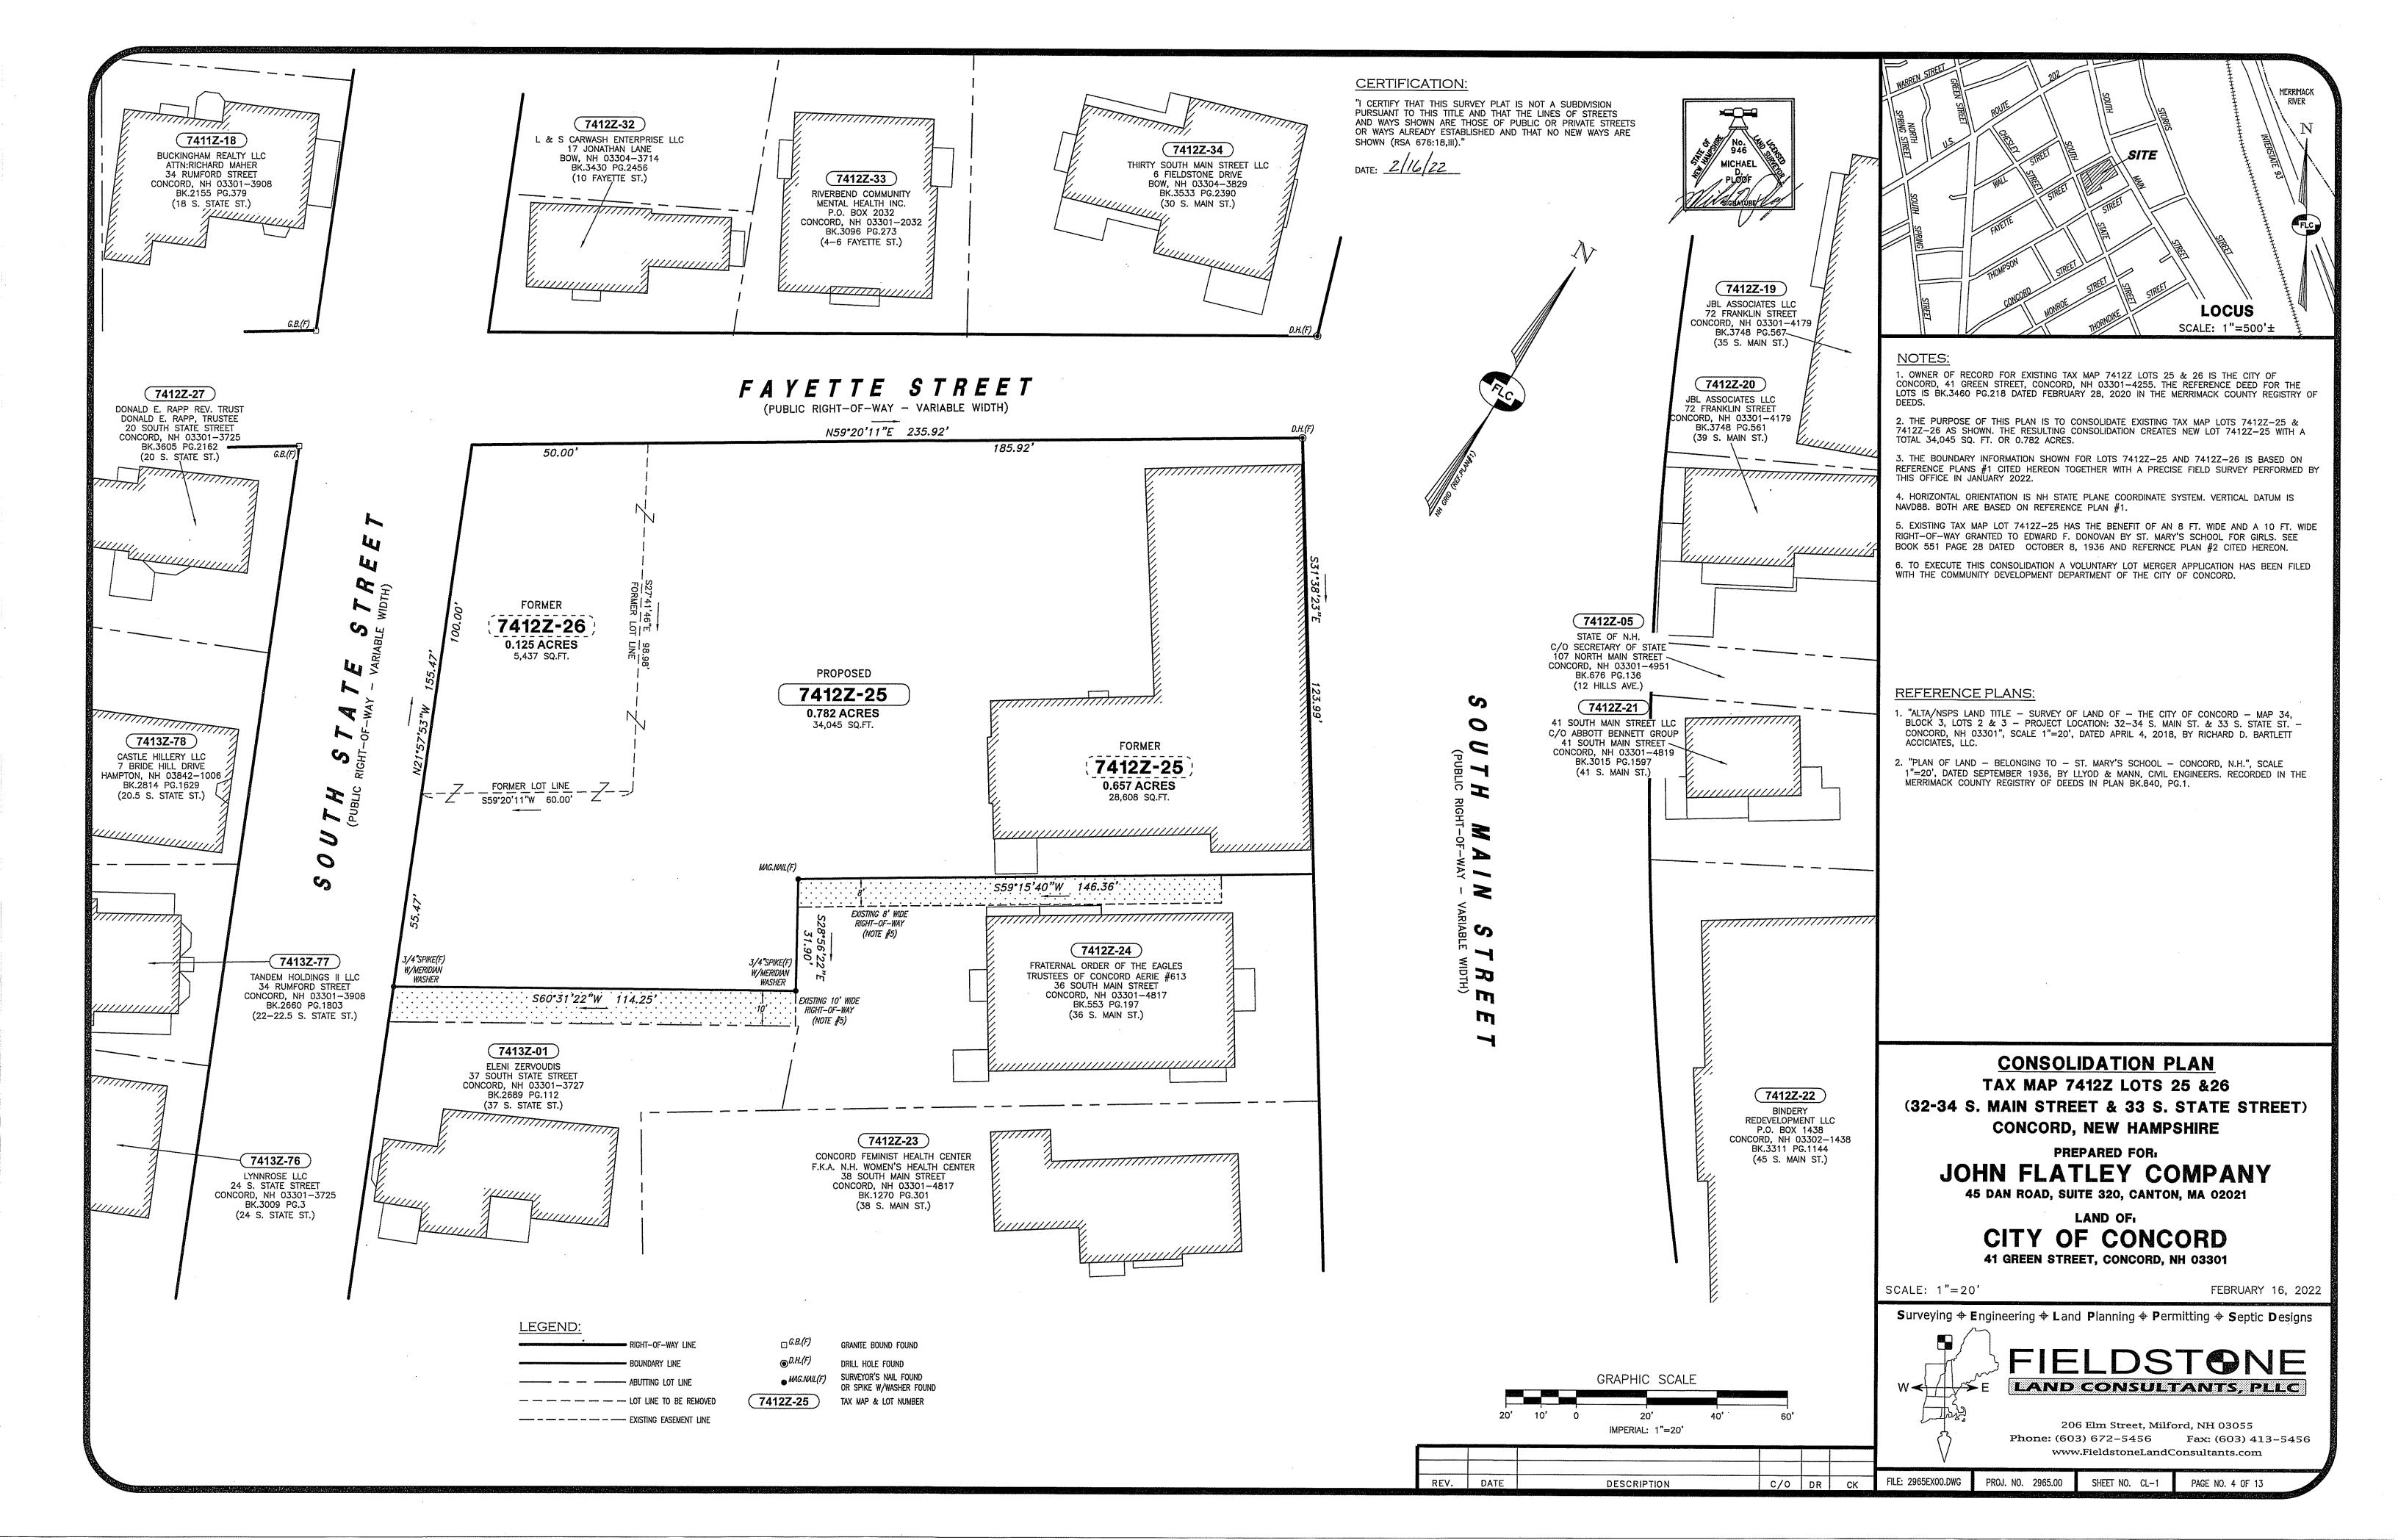


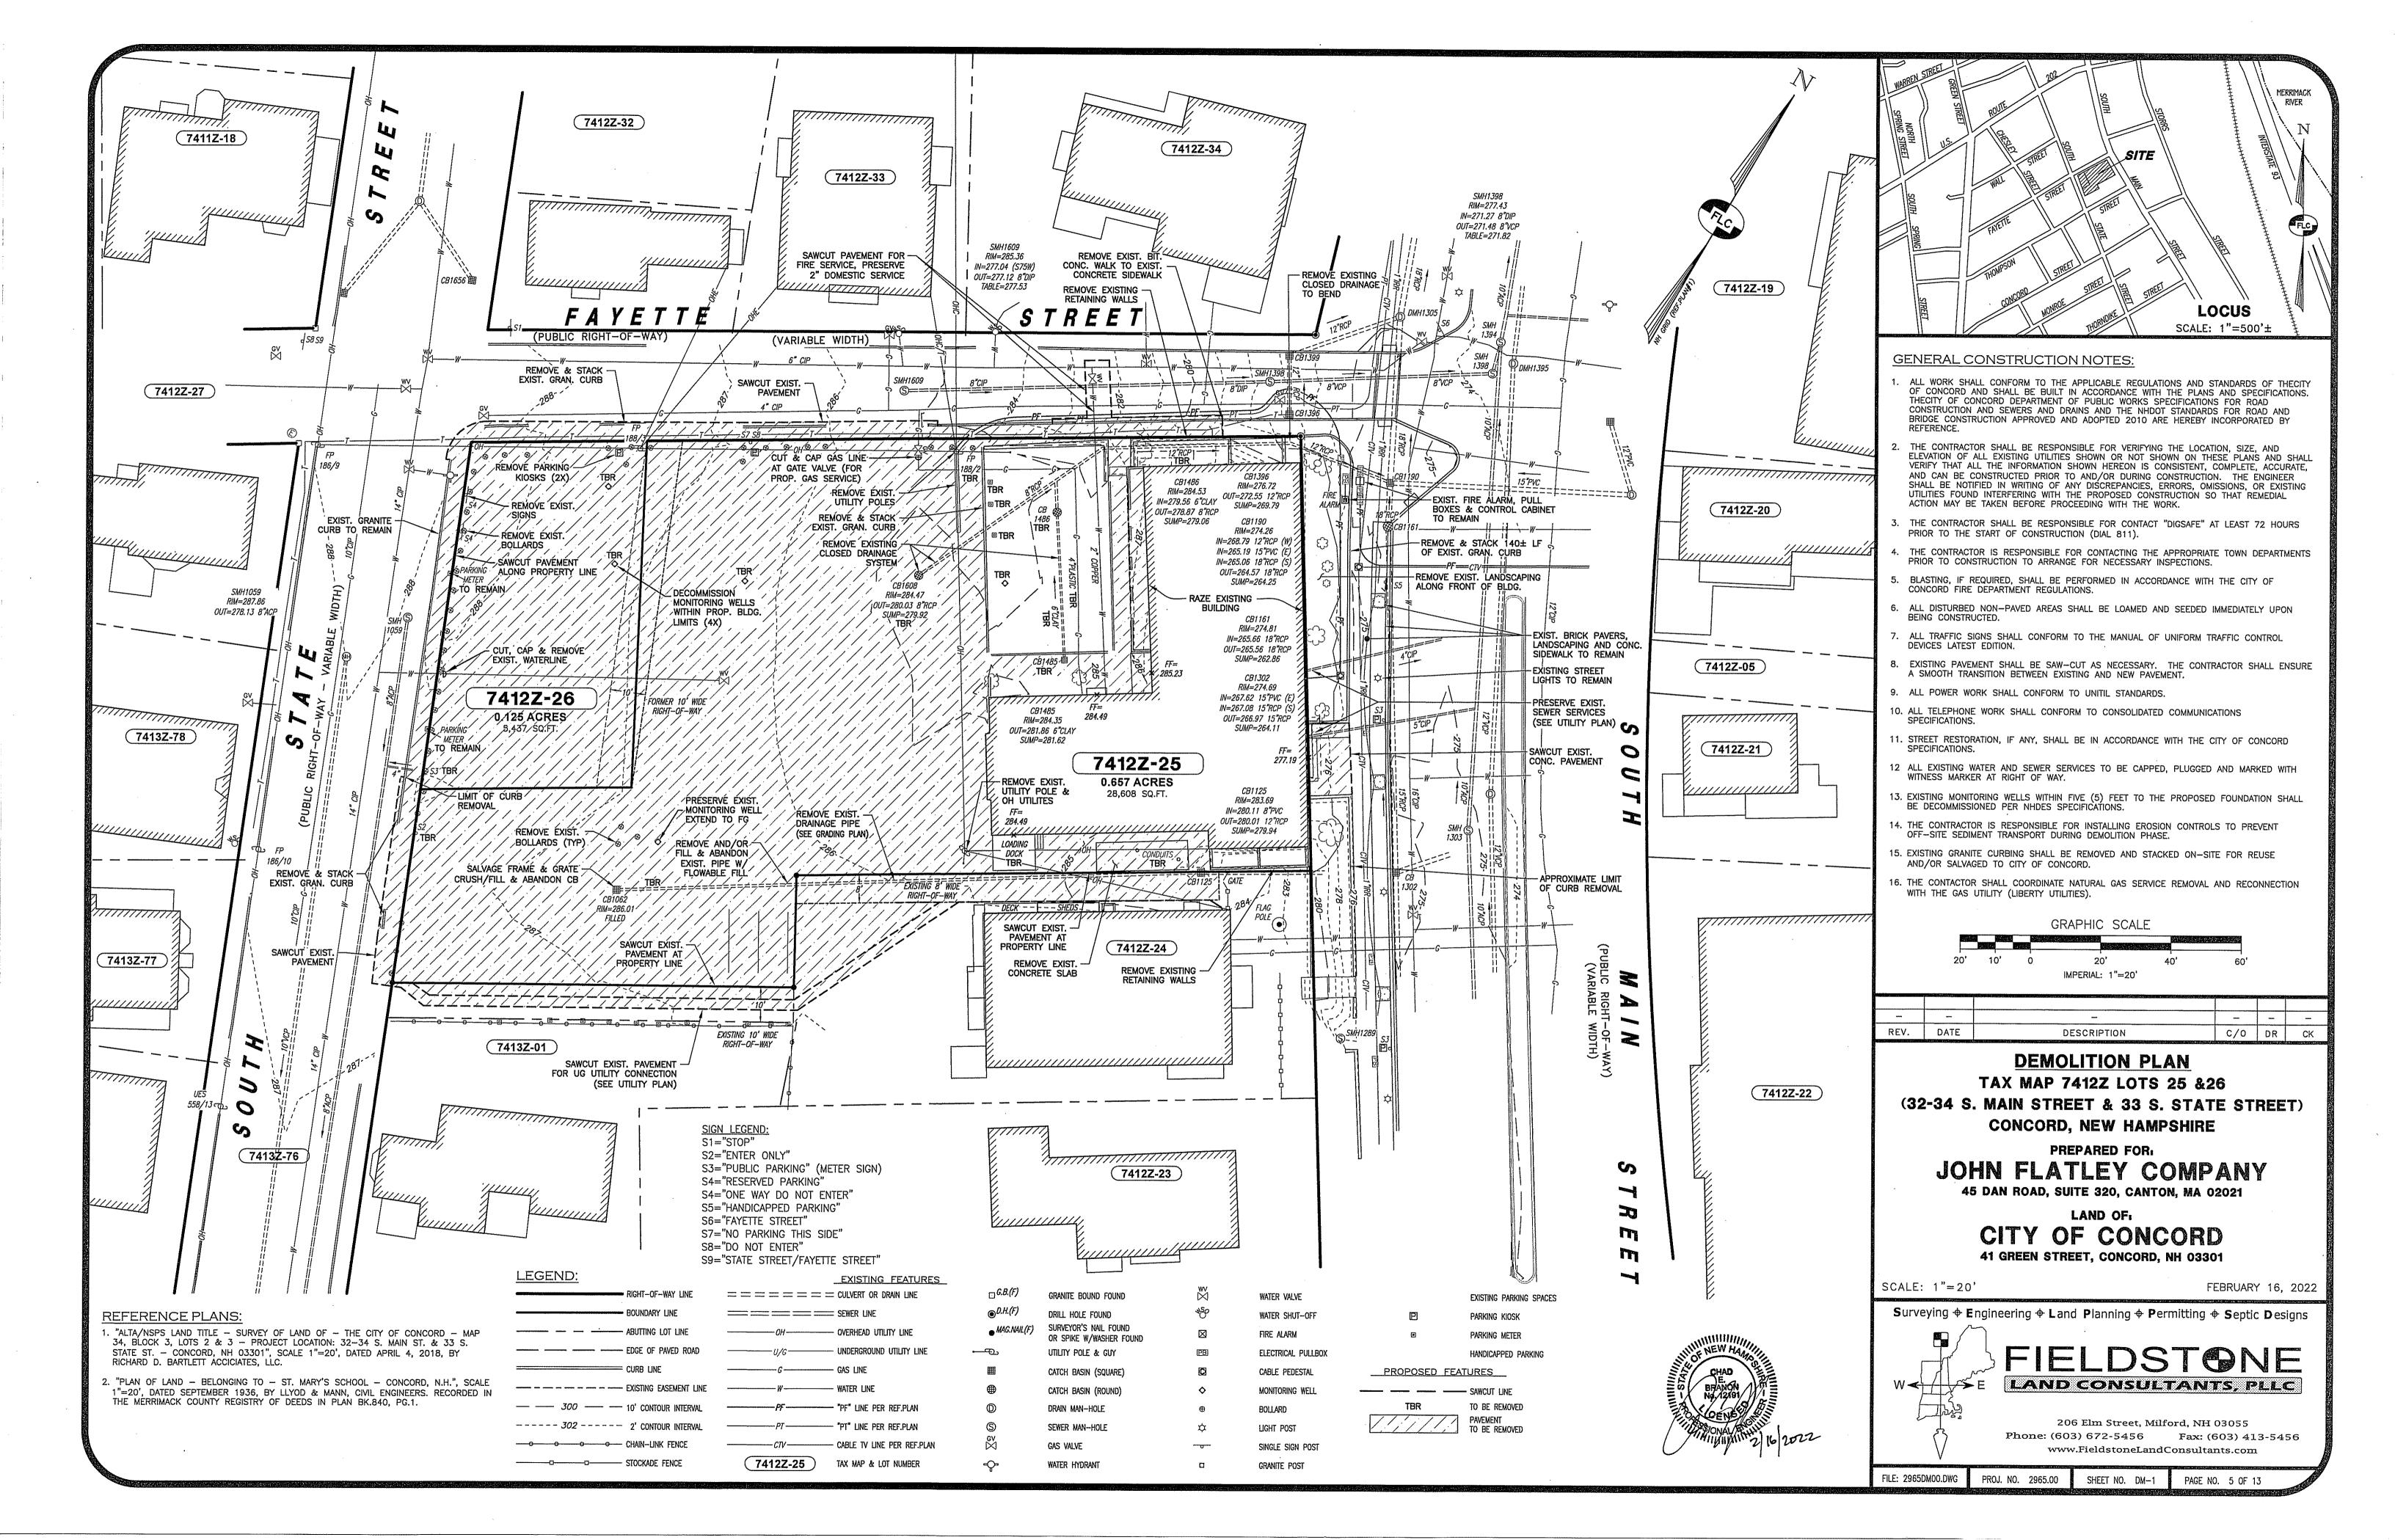

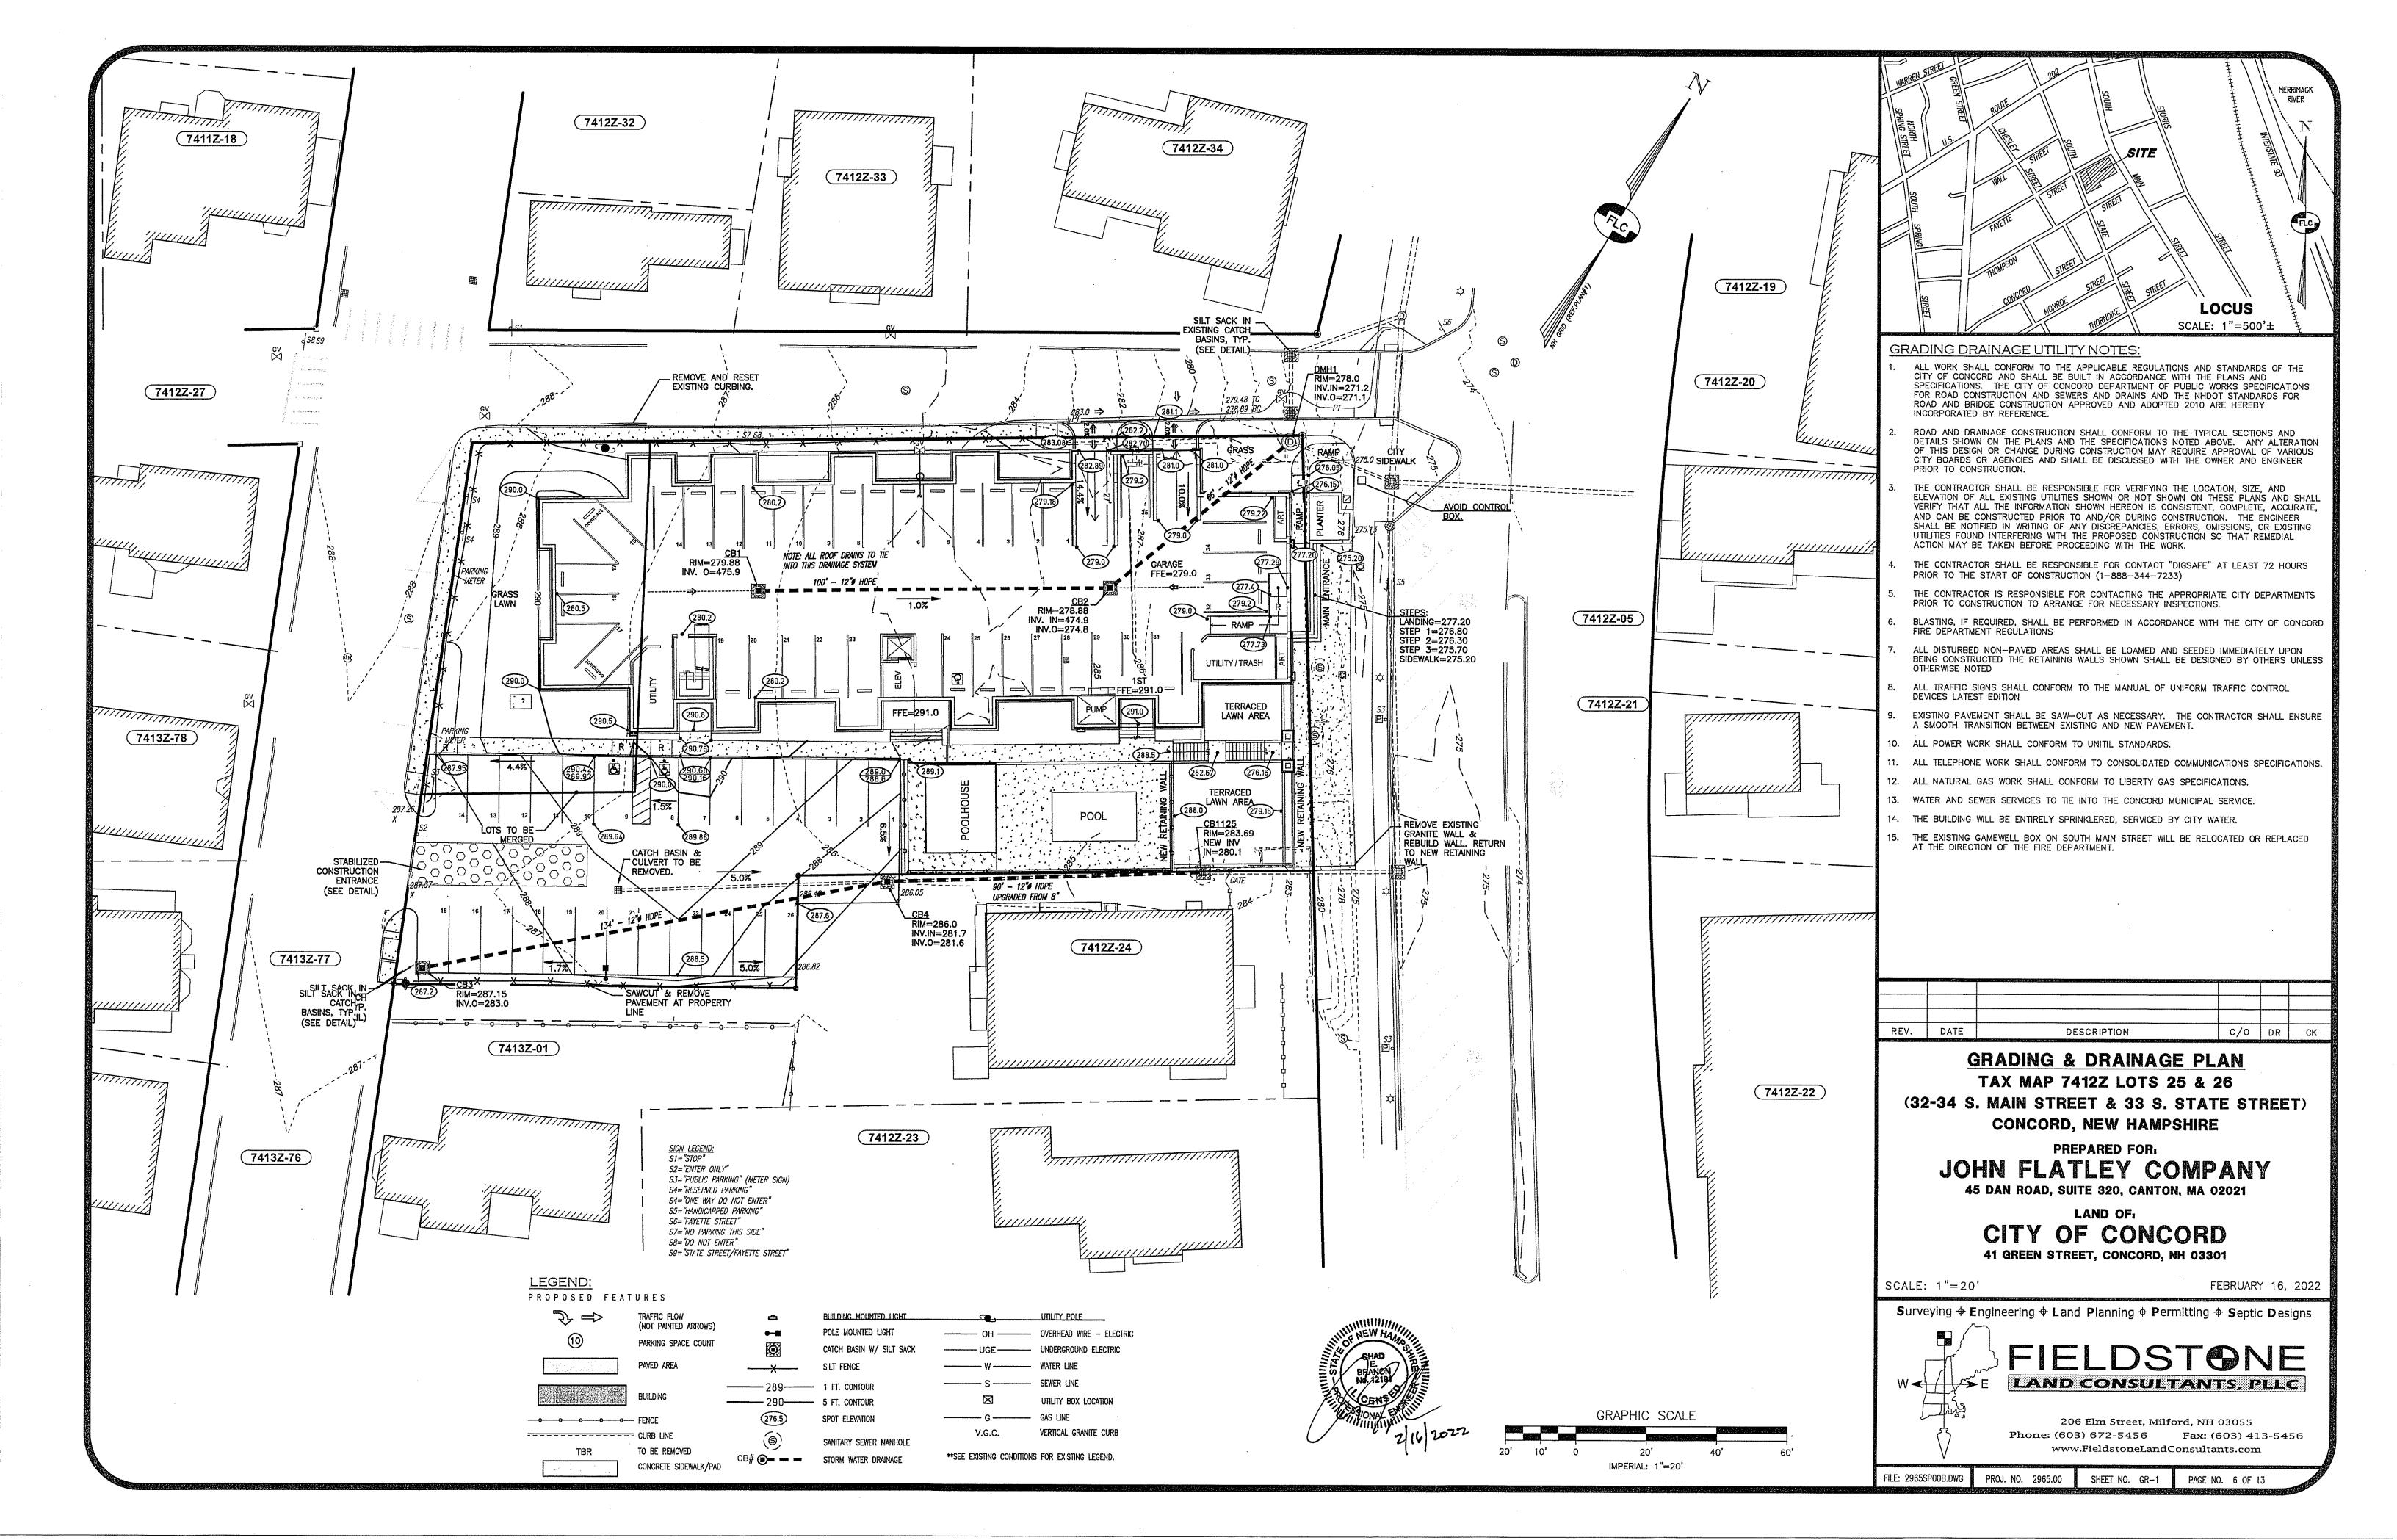

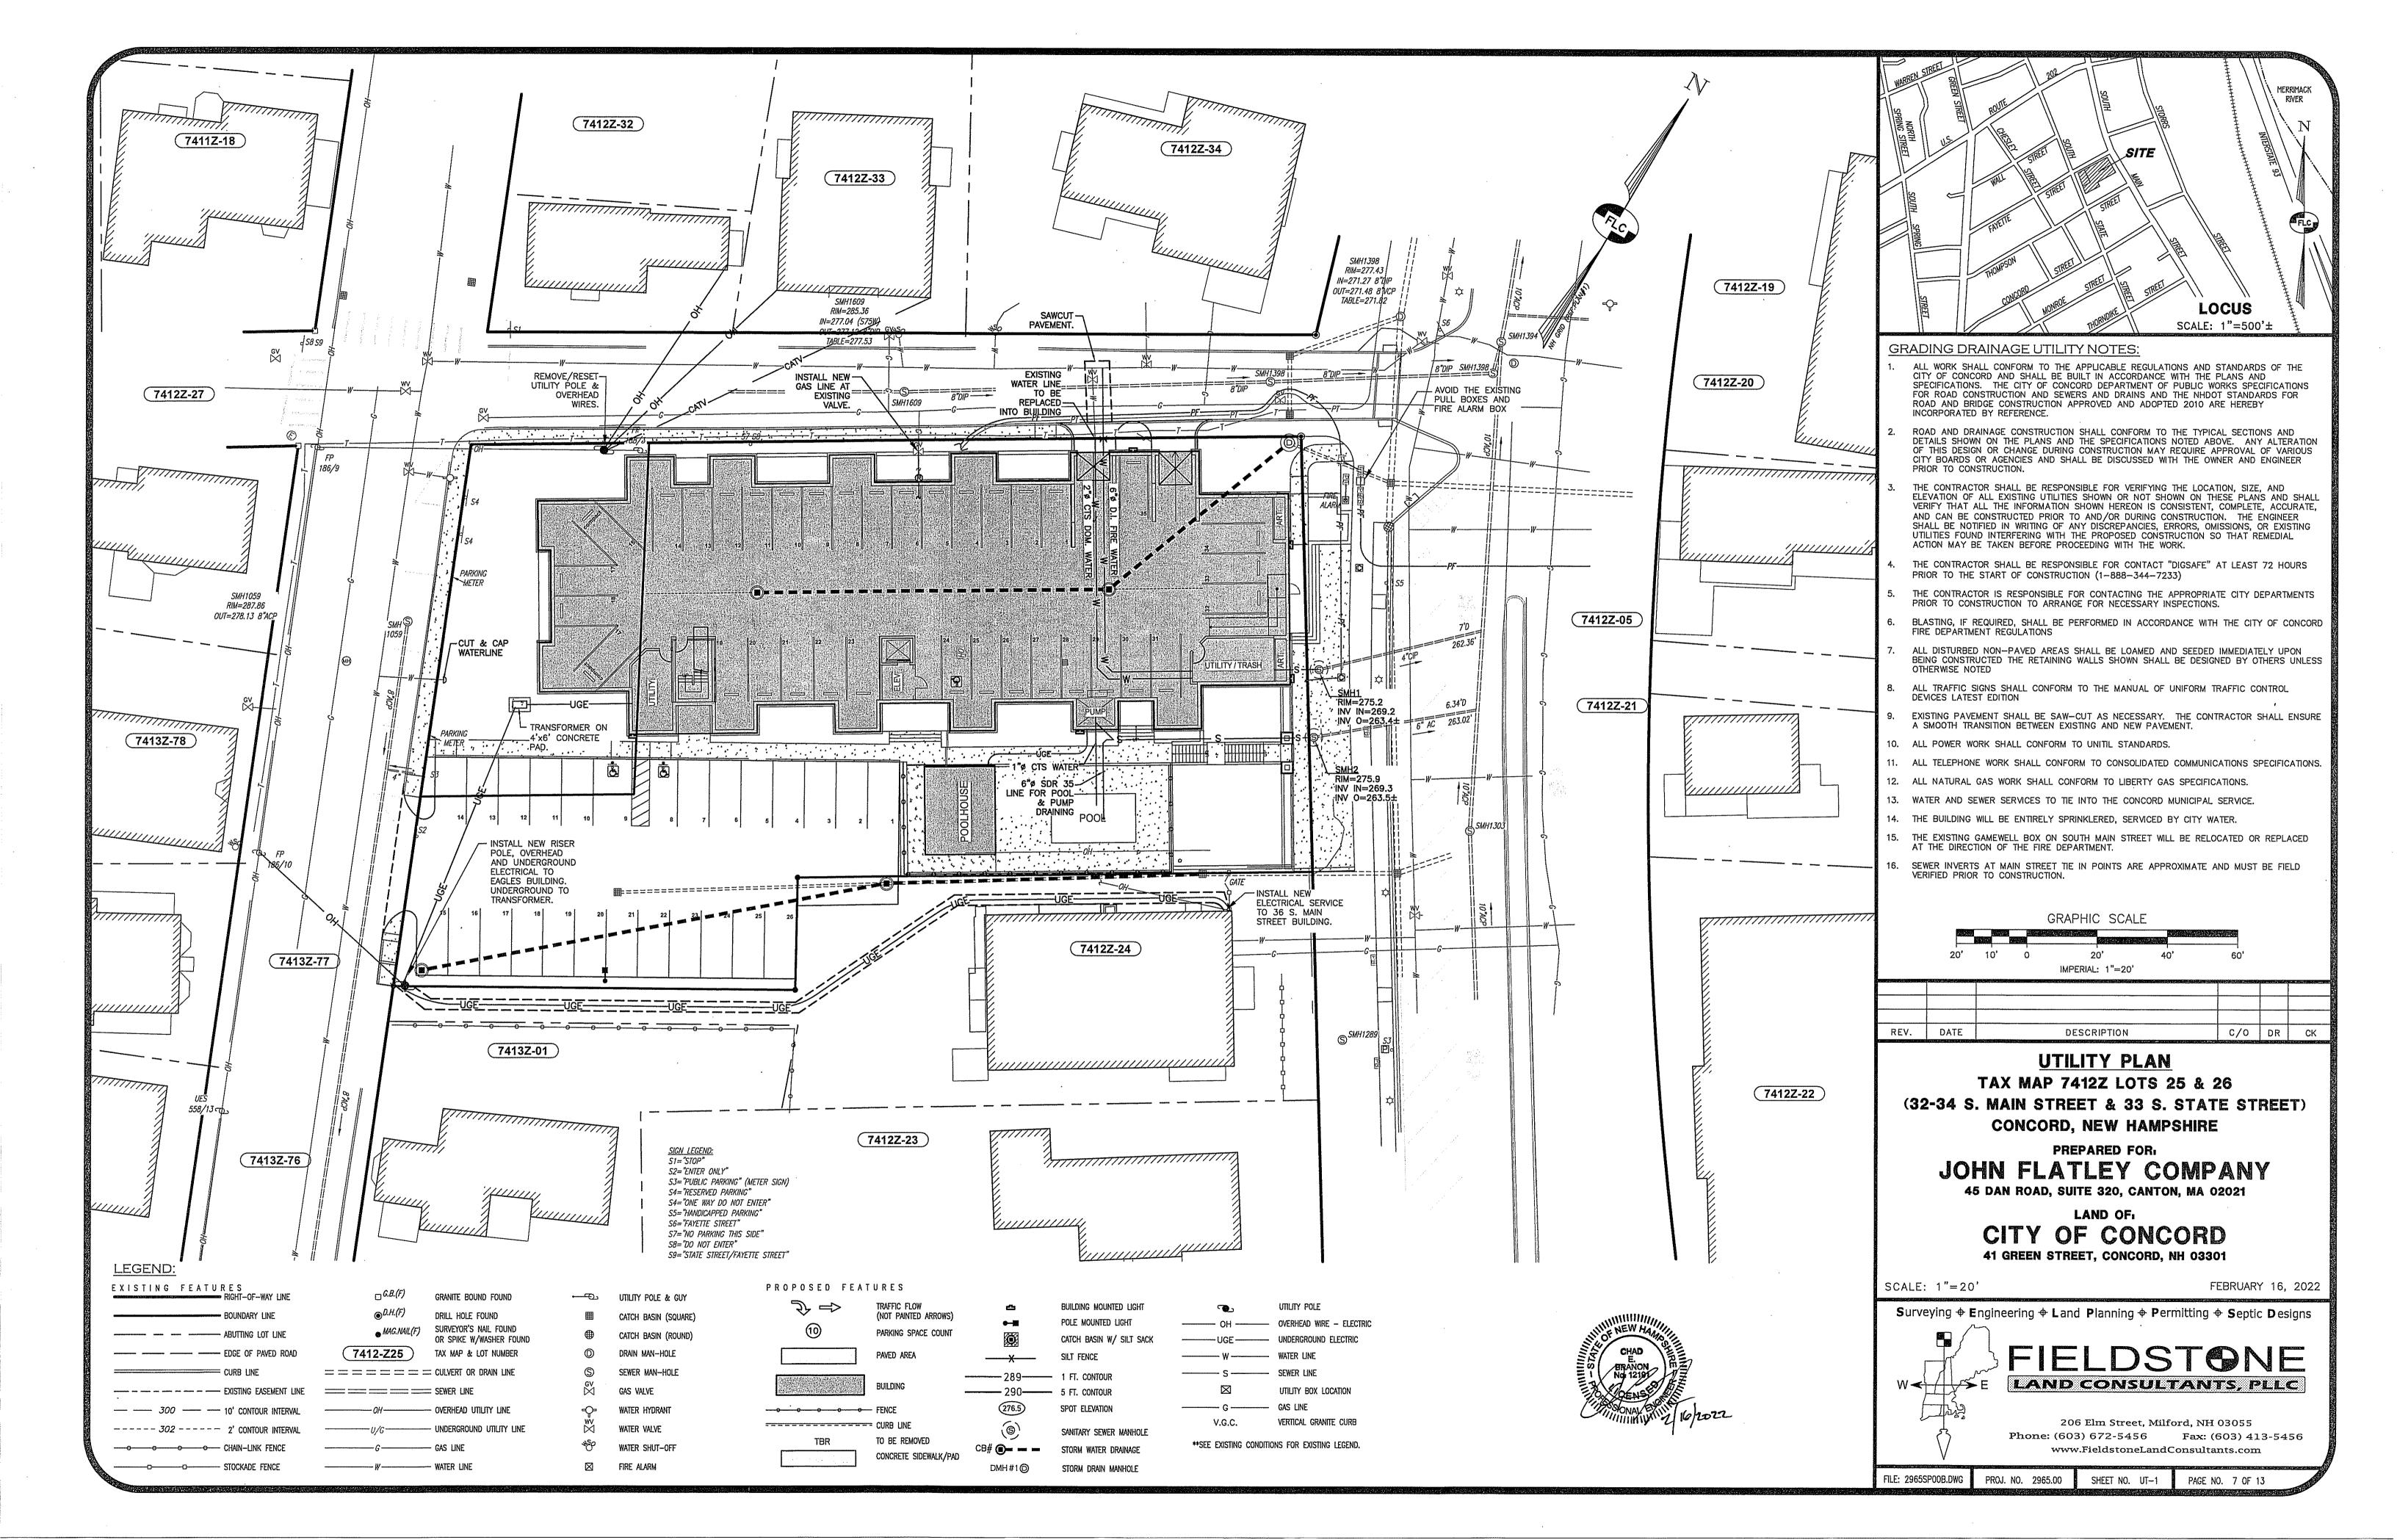

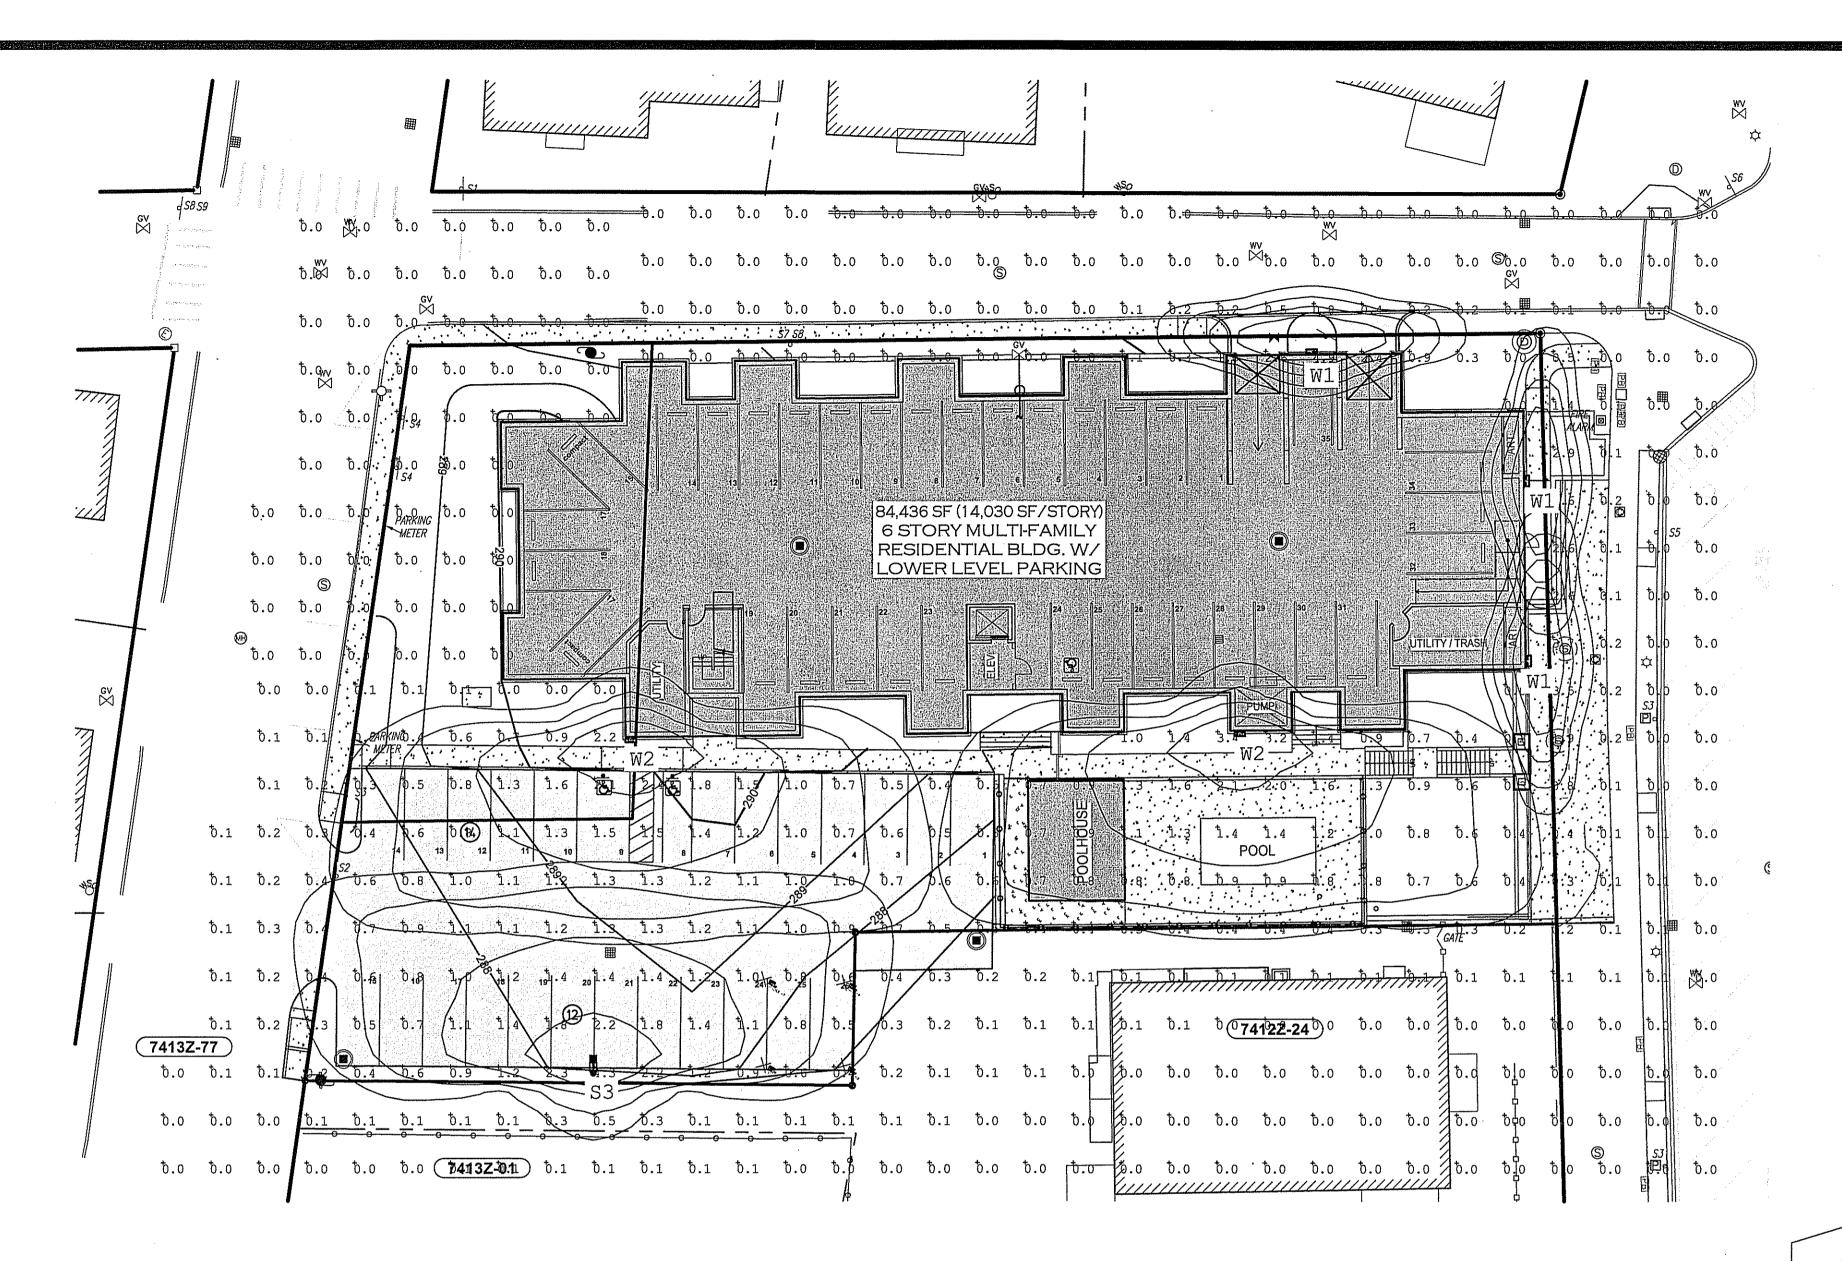

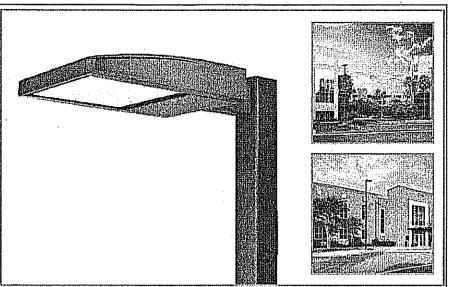

McGraw-Edison GLEON Galleon *OR EQUAL*

Area / Site Luminaire

Typical Applications
Outdoor • Parking Lots • Walkways • Roadways • Building Ares

Nominal Power Lumens (1.2A)

Nominal Power (Watts) 67

Input Current @ 120V (A) 0.58

Input Current @ 208V (A) 0.33

Input Current @ 240V (A) 0.29

Input Current @ 277V (A) 0.25

Input Current @ 347V (A) 0.20

Input Current @ 460V (A) 0.15


4000K Lumena 7.958

SL2 BUG Rating 82-U-G3


S3 - LIGHT FIXTURE: FULL CUTOFF

McGraw-Edison GWC Galleon Wall

Wall Mount Luminaire

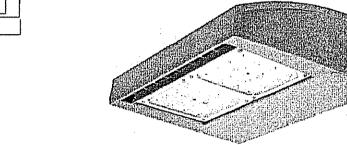

W2 - WALL MOUNTED FIXTURE FULL CUTOFF

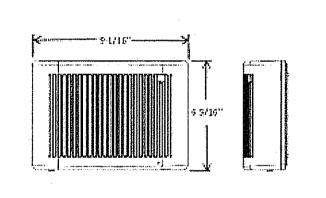

- #8 BARE COPPER GROUND

- CONDUIT PER ELECTRIC

CONTRACTOR SPECS


- CONCRETE FOUNDATION 3,000 PSI, 28 DAYS


- 8' X 5/8"~ GROUND ROD


[SIZE AND REINFORCEMENT TO BE

VERIFIED BY MANUFACTURER]


FINISH GRADE

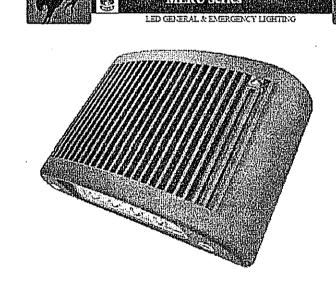

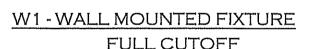

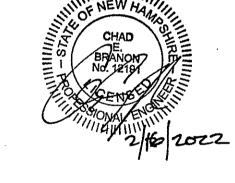

FEBRUARY 16, 2022

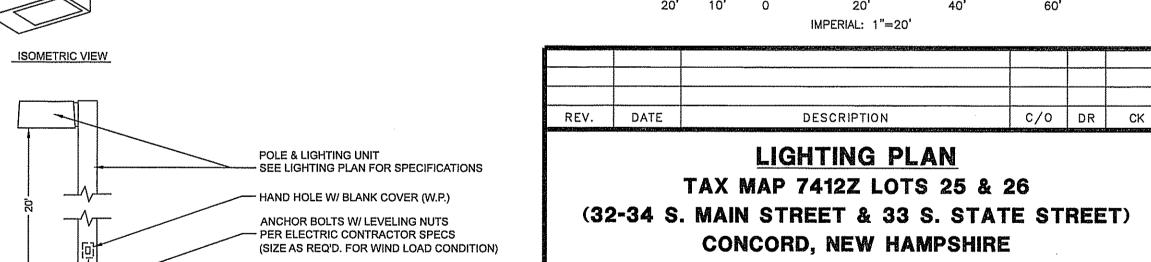

SCALE: 1"=20'

FILE: 2965SP00B.DWG

PREPARED FOR: JOHN FLATLEY COMPANY 45 DAN ROAD, SUITE 320, CANTON, MA 02021

GRAPHIC SCALE

CITY OF CONCORD

41 GREEN STREET, CONCORD, NH 03301

SHEET NO. LT-1 PAGE NO. 8 OF 13

Surveying + Engineering + Land Planning + Permitting + Septic Designs




LIGHTING NOTES:

- 1. LIGHTING SHALL BE INSTALLED AND ARRANGED SO AS NOT TO REFLECT OR CAUSE GLARE UPON ABUTTING LAND OR HIGHWAYS AND ROADS.
- 2. THE LIGHTS WILL PROVIDE ADDITIONAL LIGHT ALONG THE MAIN STREET AND FAYETTE STREET SIDEWALKS. THE LIGHT IS AT 0.0 FOOT—CANDLES PRIOR TO ANY ABUTTING PROPERTY LINES.
- 3. MOUNTING HEIGHT OF THE PROPOSED POLE MOUNT LIGHTING FIXTURE SHALL BE 20 FEET ABOVE FINISH GRADE.
- ABOVE FINISH GRADE.


 4. MOUNTING HEIGHT OF ALL WALL MOUNT LIGHTING FIXTURES SHALL BE 12 FEET AND 20 FEET ABOVE FINISH GRADE, IN LOCATIONS SHOWN.
- 5. ALL LIGHTS ARE TO BE SETUP ON PHOTOCELLS TO AUTOMATICALLY TURN OFF DURING DAYLIGHT HOURS.
- 6. ALL FIXTURES, POLES AND HARDWARE ARE TO BE BRONZE IN COLOR TO MATCH.
- 7. ALL LED LIGHT COLORS ARE TO MATCH THE EXISTING MAIN STREET LIGHT POLES.
- 8. ARCHITECTURAL LIGHTING TO BE PROVIDED IN FINAL ARCHITECTURAL PLANS. THIS WILL INCLUDE LIGHTING ALONG MAIN STREET.

StatArea_1
PARKING LOT
Illuminance (Fc)
Average = 1.09
Maximum = 4.3
Minimum = 0.4
Avg/Min Ratio = 2.73
Max/Min Ratio = 10.75

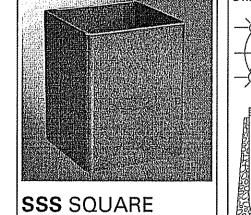

STRAIGHT STEEL

Drilled or tenon (specify)

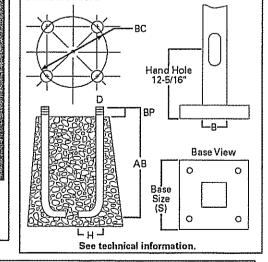

FEATURES

• ASTM Grade steel base plate with ASTM A366 base cover

• Hand hole assembly 3" x 5" on 5" and 6" pole; and 2" x 4" on 4" pole

• 10'-39' mounting heights

10' TO 39' SSS SQUARE STRAIGHT STEEL POLE - EATON

Symbol	Qty	Label	Arrangement	Description
●- [<u>a</u>]	1	S3	Single	GLEON-SA1B-740-U-SL3 / SSS4A20SFN1 (POLE MOUNTED 20' AFG)
đ	3	W1.	Single	MERU-LED-AC-DB / WALL MTD 12' AFG
Ð	2	W2	Single	GWC-SA1B-740-U-SL3 / WALL MTD 20' AFG

POLE CONFIGURATION
SINGLE W/20 FT. POLE
DOUBLE W/20 FT. POLE


NOTE:


1. LIGHT POLE FOUNDATION SHALL EXTEND 3.0 FEET ABOVE FINISH GRADE TO PREVENT VEHICLES FROM DAMAGING THE LIGHT POLE.

SCALE: N.T.S.

LIGHT POLE FOUNDATION


1
LT-1

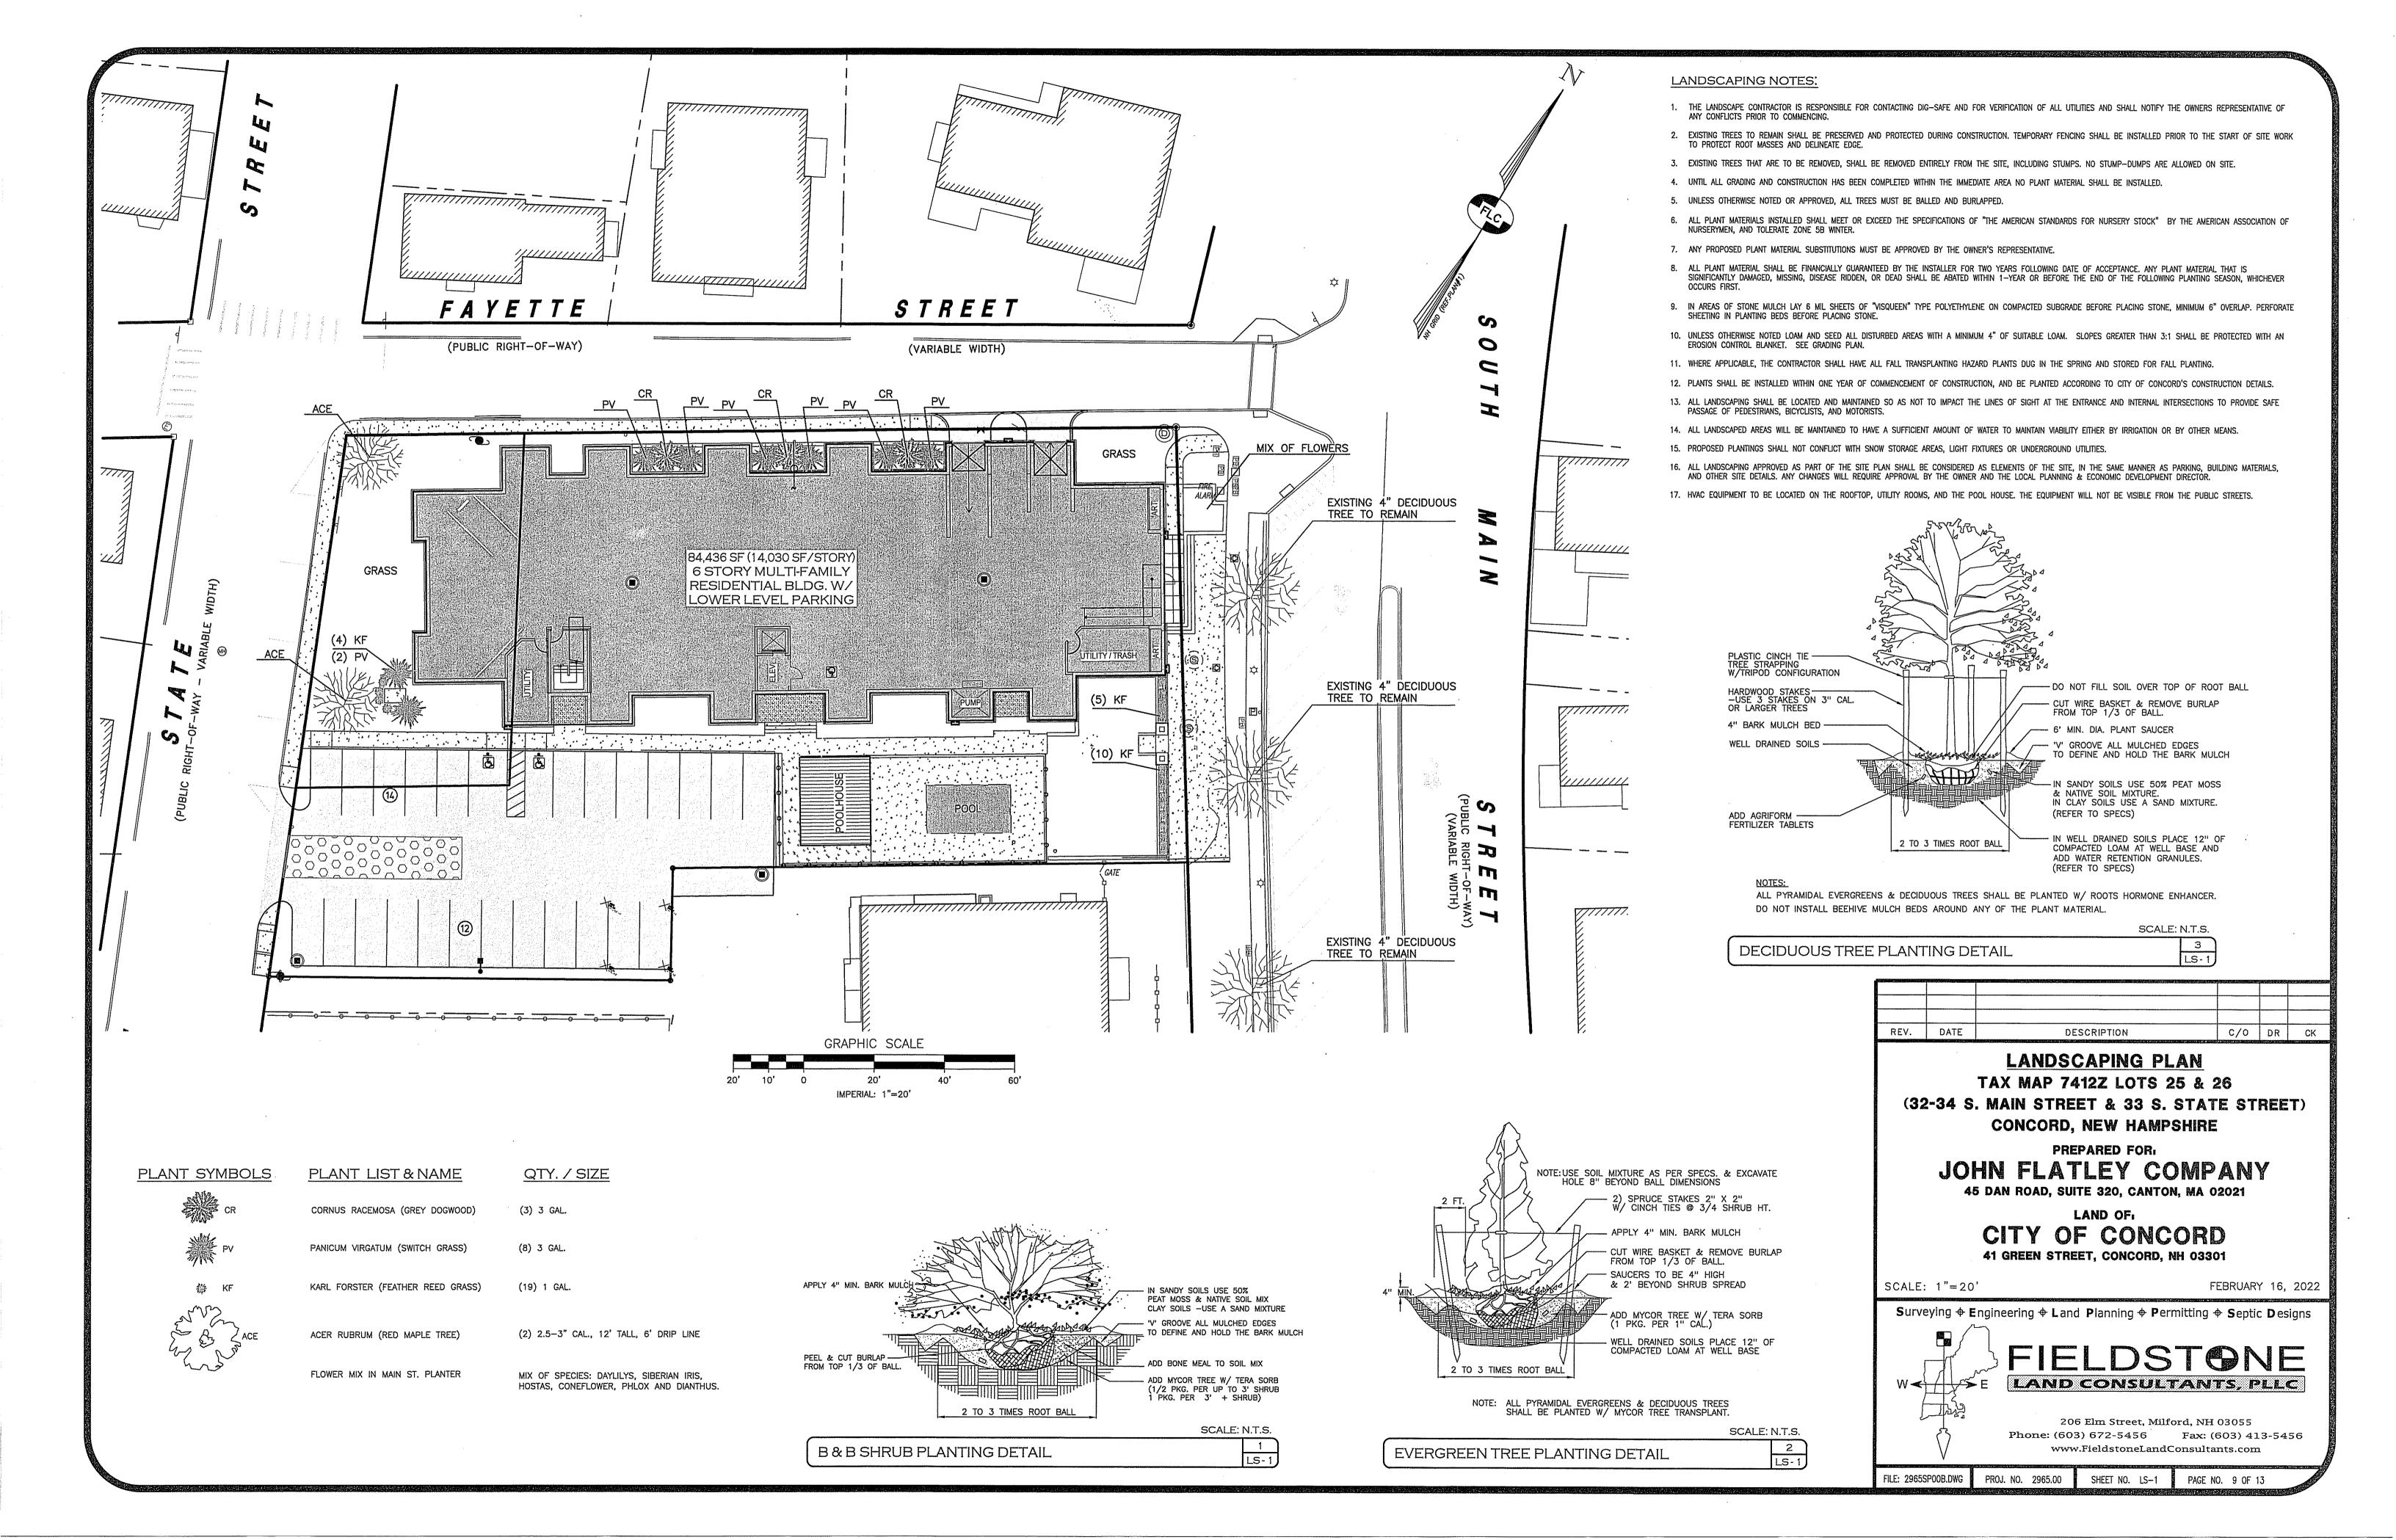

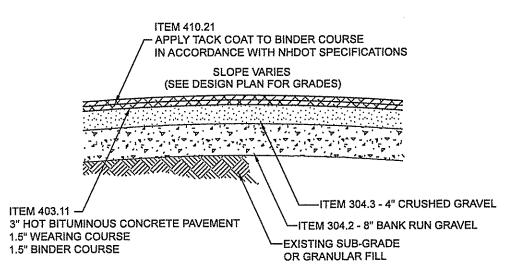


** SEE CURB DETAILS WHEN APPLICABLE**


STANDARD DUTY PARKING LOT PAVEMENT SECTION

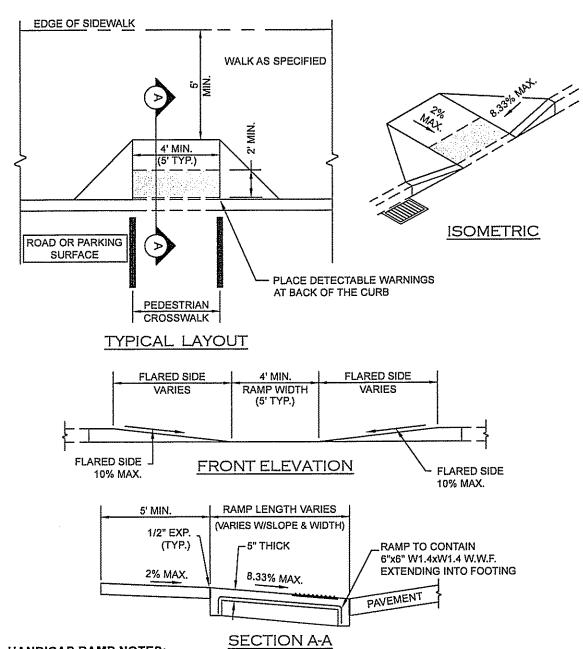


HANDICAP RAMP NOTES:

- 1. A SIDEWALK CURB RAMP IS DEFINED AS THE ENTIRE CONCRETE SURFACE WHICH INCLUDES THE RAMP AND
- 2. THE MAXIMUN RUNNING SLOPE OF ANY SIDEWALK CURB RAMP IS 8.33% (1:12). THE MAXIMUM CROSS SLOPE IS 2%. THE SLOPE OF THE LANDING SHALL NOT EXCEED 2% IN ANY DIRECTION. THE FLARED SIDE OF THE RAMP SHALL LIE ON A SLOPE OF 10% (1:10) MAXIMUM MEASURED ALONG THE CURB.
- 3. TRANSITIONS SHALL BE FLUSH AND FREE OF ABRUPT CHANGES. ROADWAY SHOULDER SLOPES ADJOINING SIDEWALK CURB RAMPS SHALL BE A MAXIMUM OF 5% (FULL WIDTH) FOR A DISTANCE OF 2 FEET FROM THE ROADWAY CURBLINE.
- 4. INTERCEPT DRAINAGE ALONG THE CURB IN ADVANCE OF SIDEWALK CURB RAMPS OR LANDINGS. CATCH BASINS, MANHOLES, ETC. SHALL NOT BE LOCATED IN, OR AT THE BASE OF, SIDEWALK CURB RAMPS OR LANDINGS.
- 5. THE BOTTOM OF THE SIDEWALK CURB RAMP OR LANDING, EXCLUSIVE OF THE FLARED SIDES, SHALL BE WHOLLY CONTAINED WITHIN THE CROSSWALK MARKINGS. IT IS DESIRABLE THAT THE LOCATION OF THE RAMP BE AS CLOSE AS POSSIBLE TO THE CENTER OF THE CROSSWALK.
- 6. THE SIDEWALK CURB RAMP OR THE LANDING AREA (PARALLEL SIDEWALK CURB RAMP) SHALL CONTRAST VISUALLY WITH THE ADJOINING SIDEWALK SURFACE, EITHER ASPHALT/LIGHT-COLORED CONCRETE OR LIGHT-COLORED CONCRETE/DARK-STAINED CONCRETE. THE CONCRETE SURFACE SHALL BE SLIP RESISTANT
- 7. DETECTABLE WARNING PANELS SHALL BE THE FULL WIDTH OF THE LANDING, BLENDED TRANSITION, OR CURB RAMP THEY ARE A PART OF AND SHALL BE A MINIMUM OF 2 FEET IN DEPTH. THE ROWS OF TRUNCATED DOMES SHALL BE ALIGNED PERPENDICULAR TO THE GRADE BREAK BETWEEN THE RAMP, BLENDED TRANSITION OR
- 8. A LEVEL LANDING 5'-0" DEEP, WITH A 2% MAXIMUM SLOPE IN EACH DIRECTION SHALL BE PROVIDED AT THE UPPER END OF EACH CURB RAMP TO ALLOW SAFE EGRESS FROM THE RAMP SURFACES. THE WIDTH OF THE LEVEL LANDING SHALL BE AT LEAST AS WIDE AS THE WIDTH OF THE RAMP. A LEVEL LANDING 4' DEEP SHALL BE PROVIDED AT ALL PEDESTRIAN PUSH BUTTONS AT SIGNALIZED CROSSINGS.
- 9. RAMP OPENING SHALL BE THE SAME WIDTH AS THE SIDEWALK, UP TO 6'-0" WIDE.
- 10. FOR NEW CONSTRUCTION ALL DETECTABLE WARNINGS ARE TO BE CAST IRON AND SET IN CONCRETE.

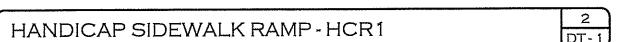

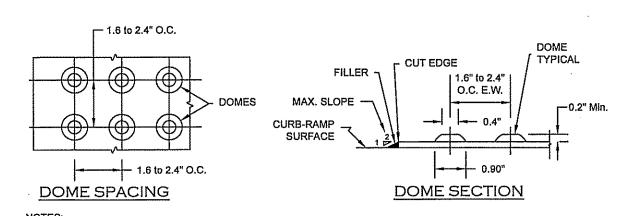



- 1. DETECTABLE WARNINGS SHALL BE PROVIDED WHERE EVER A CURB RAMP CROSSES A VEHICULAR WAY.
- 2. DETECTABLE WARNINGS SHALL BE PROVIDED 24 INCHES IN THE DIRECTION OF TRAVEL AND EXTEND THE FULL WIDTH OF THE CURB RAMP OR FLUSH SURFACE. THE DETECTABLE WARNING SHALL BE LOCATED ADJACENT TO THE
- 3. DETECTABLE WARNINGS MATERIALS SHALL BE TEXTURED TO PROVIDE SLIP RESISTANCE AND SHALL CONTRAST VISUALLY WITH ADJACENT WALKING SURFACES - EITHER LIGHT ON DARK OR DARK ON LIGHT. THE PREFERED COLOR FOR A LIGHT BACKGROUND IS RED BRICK AND FOR A DARK BACKGROUND SHALL BE SAFETY YELLOW.
- 4. DETECTABLE WARNINGS SHALL BE PLACED 6" TO 8" BEHIND THE FACE OF THE CURB JOINT.
- 5. DETECTABLE WARNING SURFACES SHALL BE SURFACE MOUNTED, THIN MOLDED SHEETGOODS WHICH INCLUDES TILES OR MATS (RIGID OR FLEXABLE, WITH TRUNCATED DOMES), BONDED AND/OR ANCHORED TO THE SURFACE OF THE RAMP, THE SURFACE SHALL CONFORM WITH THE REQUIREMENTS OF THE AMERICANS WITH DISABILITIES GUIDELINES 4.29,10.3, AND THE TOWN OF MERRIMACK STANDARDS.

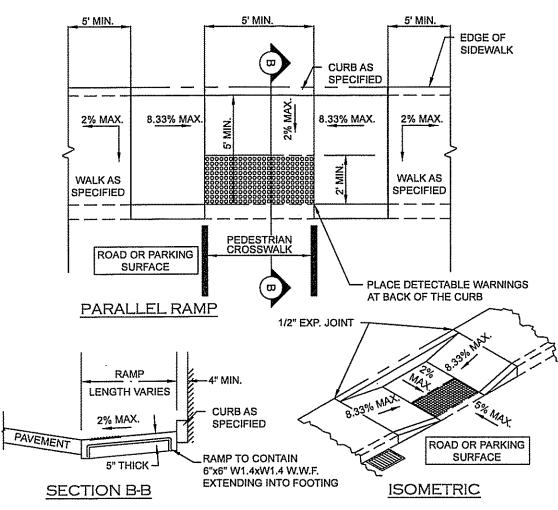

HANDICAP RAMP NOTES:


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- 3. TRANSITIONS SHALL BE FLUSH AND FREE OF ABRUPT CHANGES. ROADWAY SHOULDER SLOPES ADJOINING SIDEWALK CURB RAMPS SHALL BE A MAXIMUM OF 5% (FULL WIDTH) FOR A DISTANCE OF 2 FEET FROM THE ROADWAY CURBLINE.
- 4. INTERCEPT DRAINAGE ALONG THE CURB IN ADVANCE OF SIDEWALK CURB RAMPS OR LANDINGS. CATCH BASINS, MANHOLES, ETC. SHALL NOT BE LOCATED IN, OR AT THE BASE OF, SIDEWALK CURB RAMPS OR LANDINGS.
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- 7. DETECTABLE WARNING PANELS SHALL BE THE FULL WIDTH OF THE LANDING, BLENDED TRANSITION, OR CURB RAMP THEY ARE A PART OF AND SHALL BE A MINIMUM OF 2 FEET IN DEPTH. THE ROWS OF TRUNCATED DOMES SHALL BE ALIGNED PERPENDICULAR TO THE GRADE BREAK BETWEEN THE RAMP, BLENDED TRANSITION OR
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- 9. RAMP OPENING SHALL BE THE SAME WIDTH AS THE SIDEWALK, UP TO 6'-0" WIDE.
- 10. FOR NEW CONSTRUCTION ALL DETECTABLE WARNINGS ARE TO BE CAST IRON AND SET IN CONCRETE.

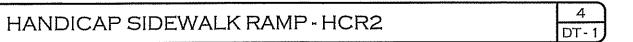

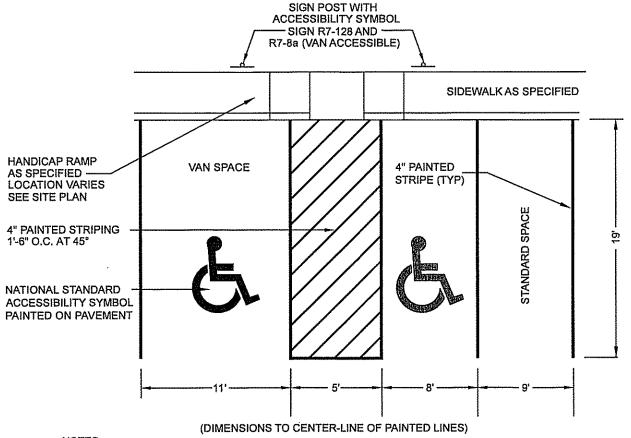


- 1. MAXIMUM SLOPE IN ANY DIRECTION IS 2.0% FOR HANDICAP SPACES.
- 2. SEE SITE PLAN FOR LOCATION OF HANDICAP SPACES AND TYPE OF HANDICAP RAMP TO BE USED.
- 3. HANDICAP SYMBOL SHALL BE CENTERED ON WIDTH OF PARKING STALL AND LOCATED 6'6" FROM ACCESS DRIVE, INTO PARKING SPACE.
- 4. THE HANDICAP SYMBOL SHALL HAVE A 5' x 5' CONTRASTING BACKGROUND, NORMALLY BLUE. A BACKGROUND IS NOT REQUIRED IF WHITE OR YELLOW SYMBOL IS ON BLACK ASPHALT.

PARKING STALL LAYOUT

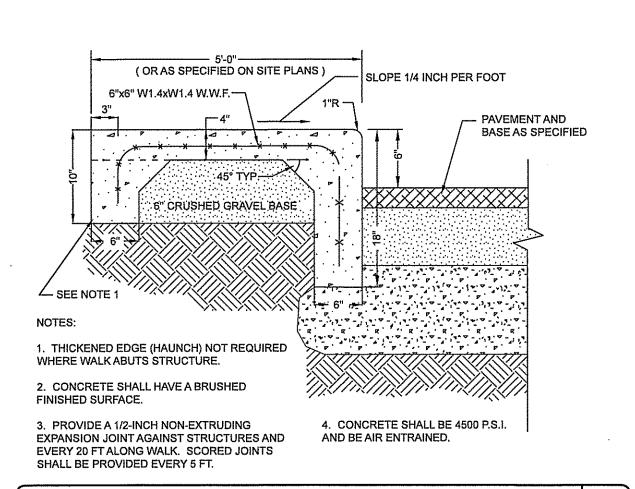


SIDEWALK - CONCRETE (INTEGRAL CONCRETE CURB)

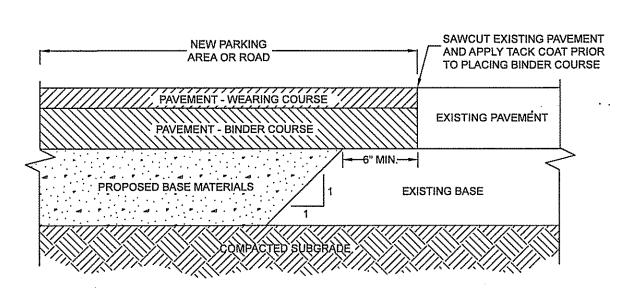

NOTE:
1. SEE ROADWAY OR PARKING LOT SECTION FOR MATERIALS AND ASSOCIATED DEPTHS. 2. INFRARED JOINT AFTER PLACING PAVEMENT.

PAVEMENT MATCH

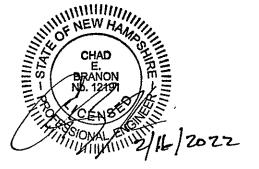


72 HOURS PRIOR TO CONSTRUCTION DIGSAFE.COM OR DIAL 8 1 1 CALL 811 - KNOW WHAT'S BELOW

C/O DR REV. DATE DESCRIPTION

CONSTRUCTION DETAILS TAX MAP 7412Z LOTS 25 & 26 (32-34 S. MAIN STREET & 33 S. STATE STREET) CONCORD, NEW HAMPSHIRE

PREPARED FOR JOHN FLATLEY COMPANY 45 DAN ROAD, SUITE 320, CANTON, MA 02021


SCALE: NONE FEBRUARY 16, 2022 Surveying ϕ Engineering ϕ Land Planning ϕ Permitting ϕ Septic Designs

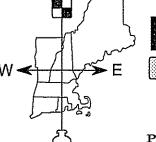

LAND CONSULTANTS, PLLC

206 Elm Street, Milford, NH 03055 Phone: (603) 672-5456 Fax: (603) 413-5456 www.FieldstoneLandConsultants.com

SHEET: DT-1 SHEET NO. 10 OF 13

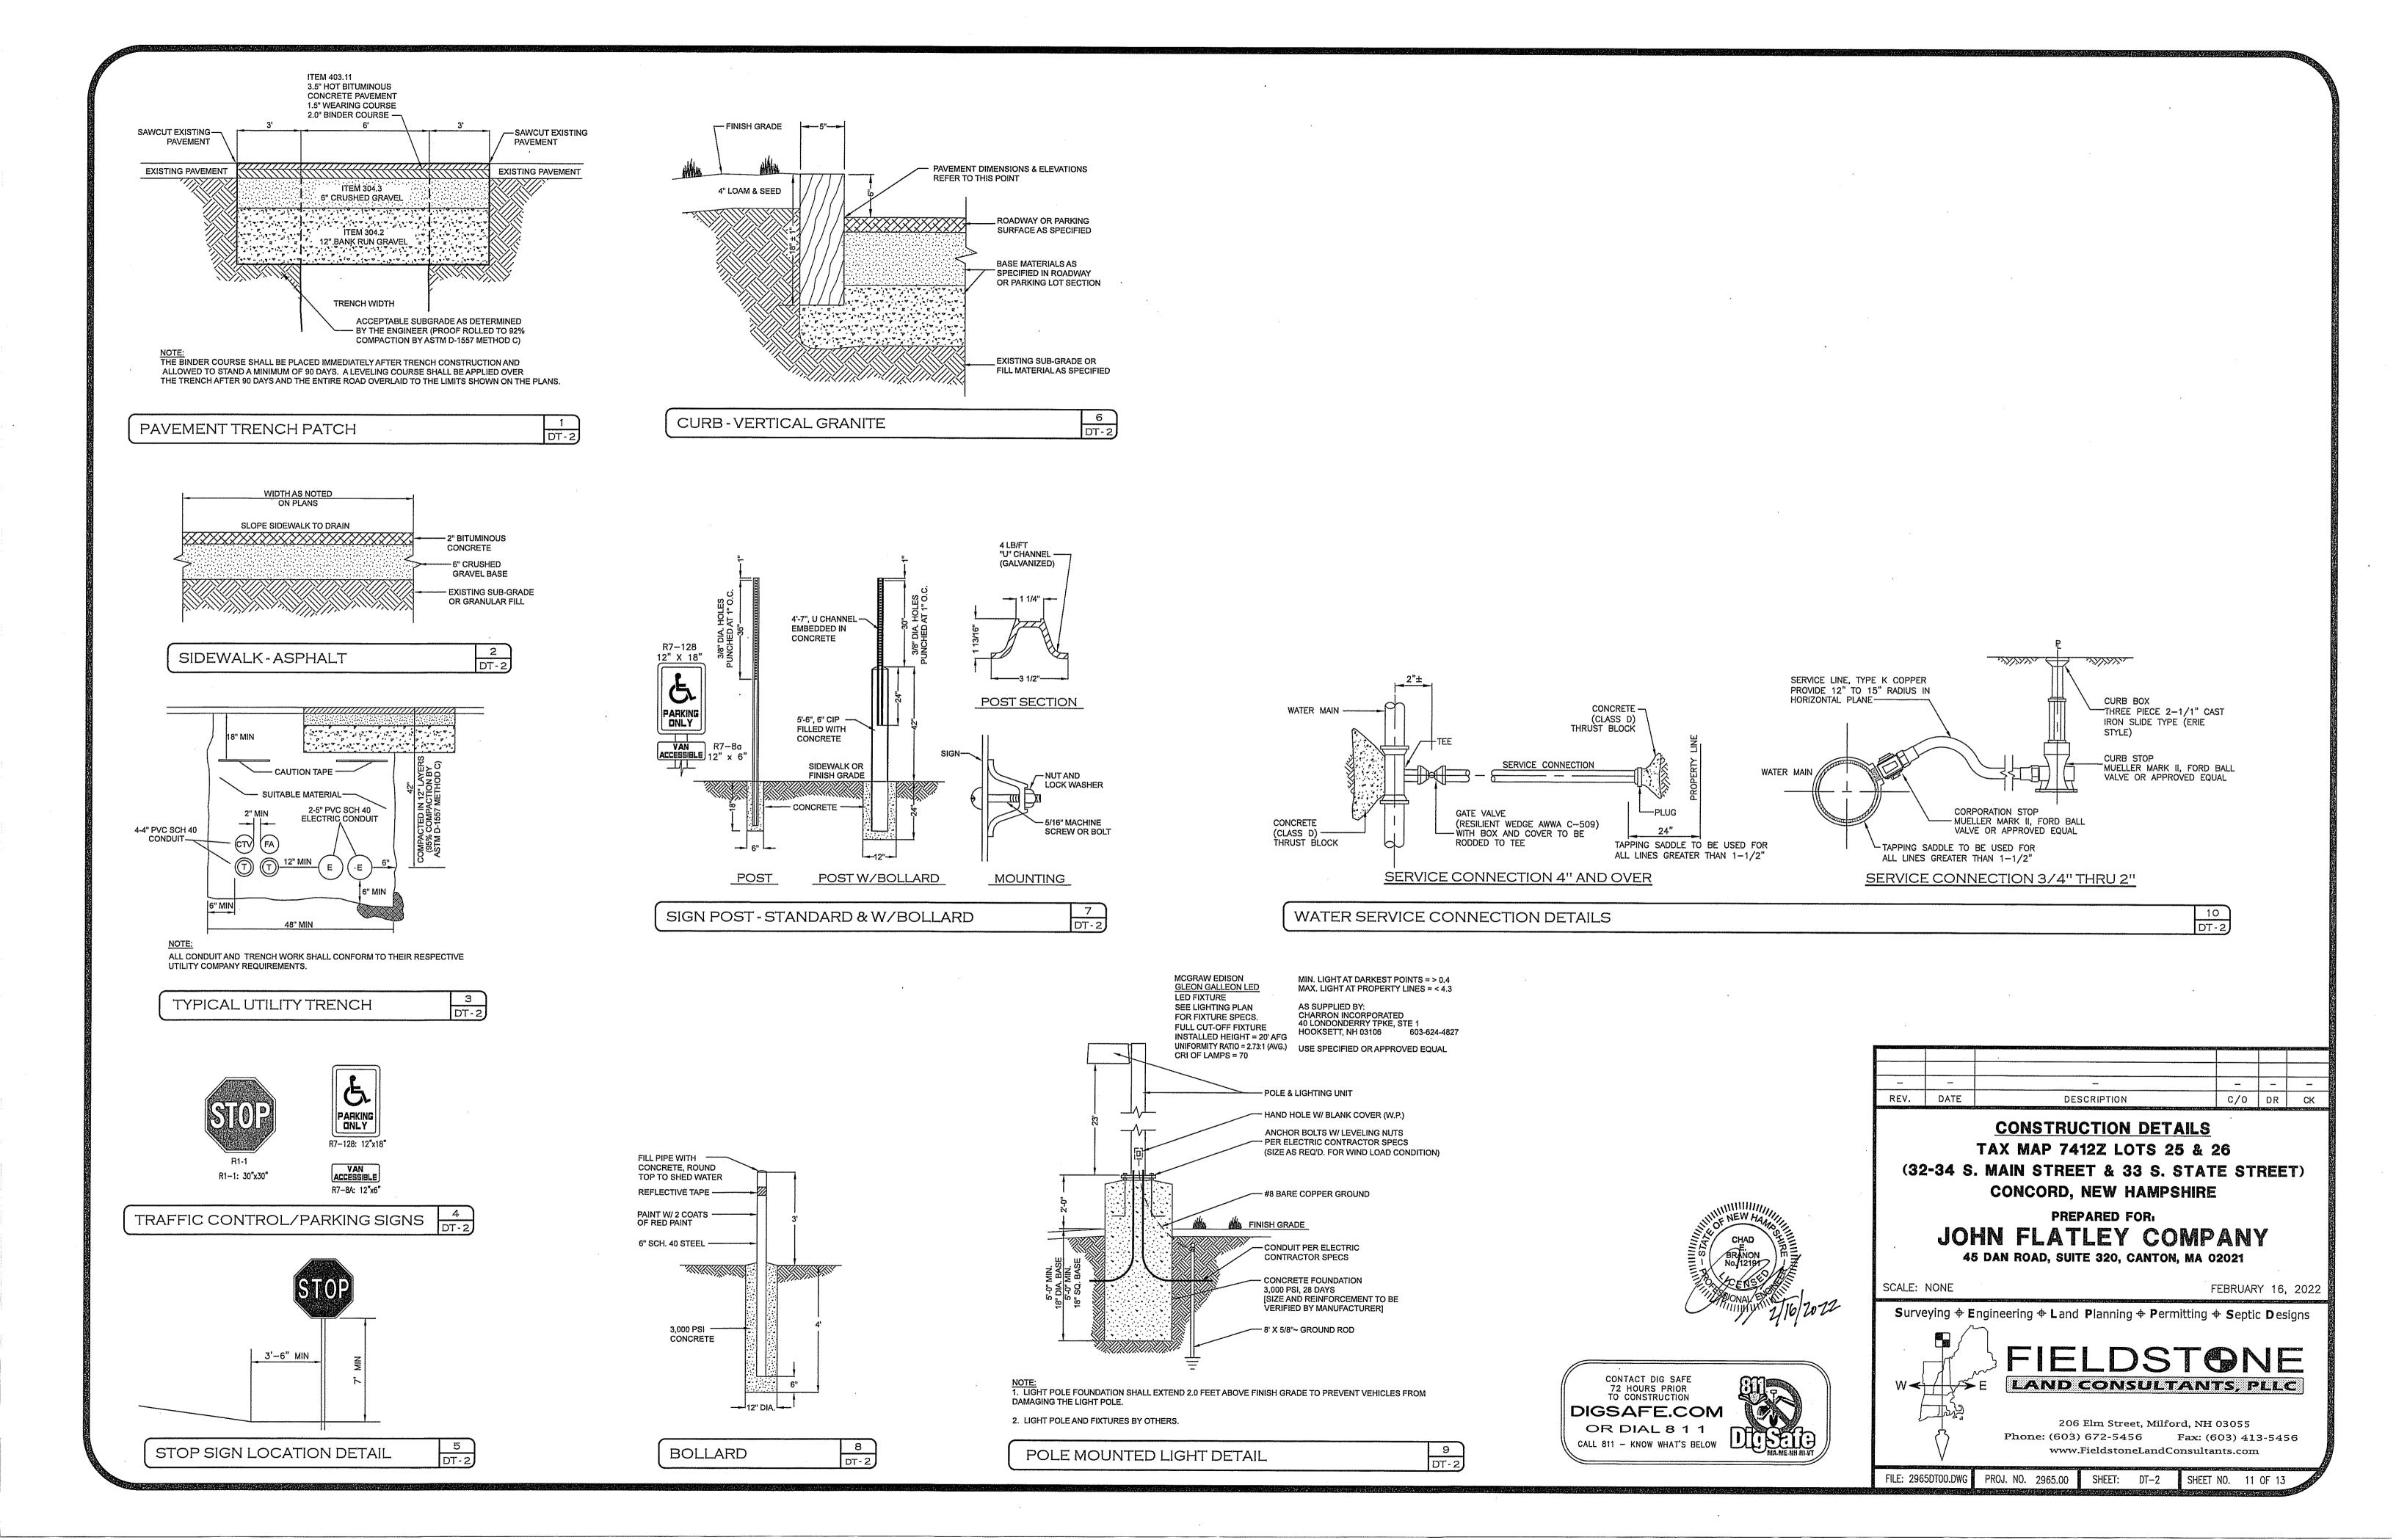


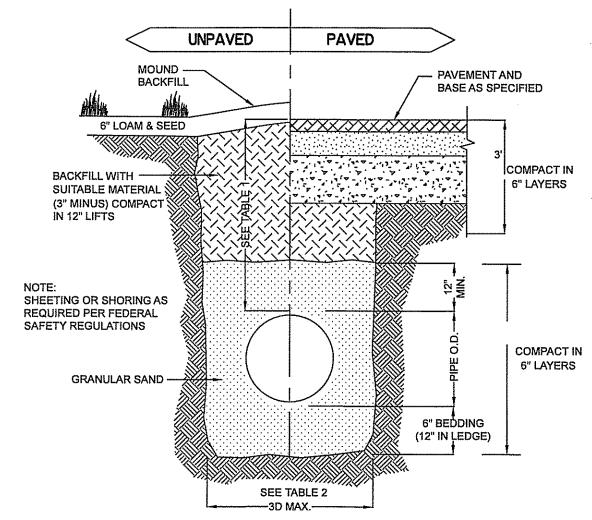



TABLE 1 (RECO	MMENDED	COVER)
LOCATION	PIPE MATERIAL	MINIMUM COVER
PAVED ROADS UNPAVED ROADS DRIVEWAYS UNPAVED AREAS	ALL ALL ALL ALL	3 FT. 2 FT. 1 FT. 2 FT.


INSIDE DIAMETER	TOTAL WIDTH
12" TO 24"	l.D. + 24"
OVER 24"	2 x l.D.


DRAINAGE TRENCH (TYPICAL)

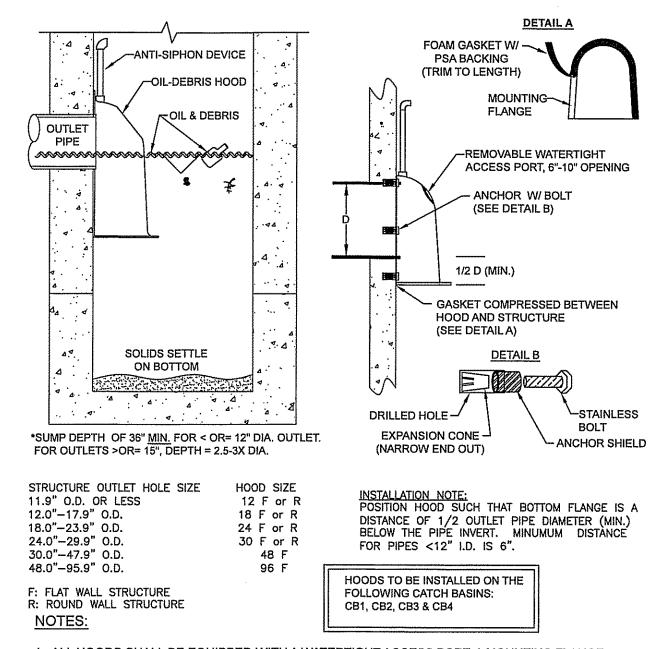


- 1. ALL HOODS SHALL BE EQUIPPED WITH A WATERTIGHT ACCESS PORT, A MOUNTING FLANGE, AND AN ANTI-SIPHON VENT AS DRAWN. (SEE CONFIGURATION DETAIL)
- 2. THE SIZE AND POSITION OF THE HOOD SHALL BE DETERMINED BY OUTLET PIPE SIZE AS PER MANUFACTURER'S RECOMMENDATION.
- 3. THE BOTTOM OF THE HOOD SHALL EXTEND DOWNWARD A DISTANCE EQUAL TO 1/2 THE OUTLET PIPE DIAMETER WITH A MINIMUM DISTANCE OF 6" FOR PIPES <12" I.D.
- 4. THE ANTI-SIPHON VENT SHALL EXTEND ABOVE HOOD BY MINIMUM OF 3" AND A MAXIMUM OF 12" ACCORDING TO STRUCTURE CONFIGURATION.
- 5. THE SURFACE OF THE STRUCTURE WHERE THE HOOD IS MOUNTED SHALL BE FINISHED SMOOTH AND FREE OF LOOSE MATERIAL AND THE PIPE SHALL BE TRIMMED FLUSH TO WALL.
- 6. THE HOOD SHALL BE SECURELY ATTACHED TO STRUCTURE WALL WITH 3/8' STAINLESS STEEL BOLTS AND OIL-RESISTANT GASKET AS SUPPLIED BY MANUFACTURER. (SEE INSTALLATION DETAIL)
- 7. ALL HOODS AND TRAPS FOR CATCH BASINS AND WATER QUALITY STRUCTURES SHALL BE AS MANUFACTURED BY BEST MANAGEMENT PRODUCTS, INC., LYME, CT OR EQUAL.

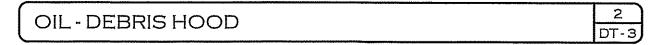


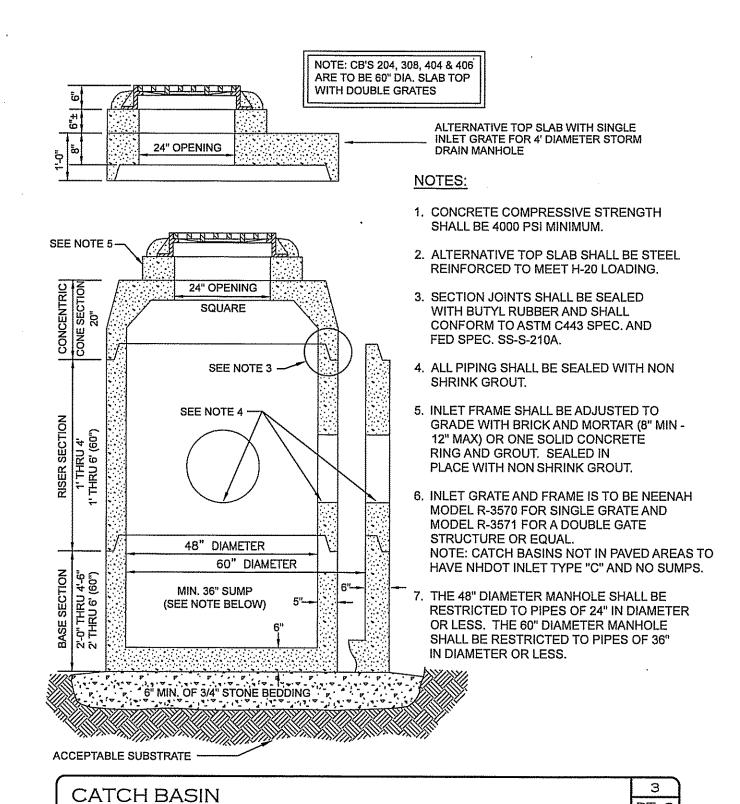

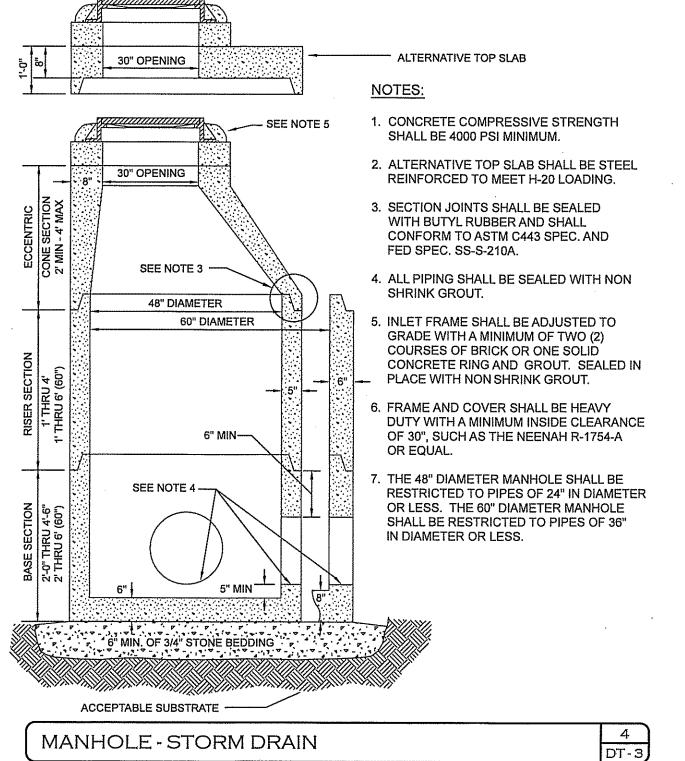

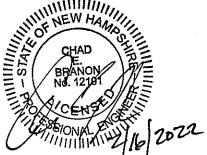



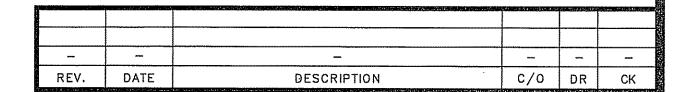


DRAINAGE DETAILS TAX MAP 7412Z LOTS 25 & 26 (32-34 S. MAIN STREET & 33 S. STATE STREET) CONCORD, NEW HAMPSHIRE

PREPARED FOR

JOHN FLATLEY COMPANY

45 DAN ROAD, SUITE 320, CANTON, MA 02021

Surveying + Engineering + Land Planning + Permitting + Septic Designs

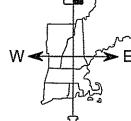

SCALE: NONE

FIELDSTONE LAND CONSULTANTS, PLLC

FEBRUARY 16, 2022

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PROJ. NO. 2965.00 SHEET: DT-3 SHEET NO. 12 OF 13



- 1. PRIOR TO STARTING ANY WORK ON THE SITE THE CONTRACTOR SHALL NOTIFY APPROPRIATE AGENCIES.
- 2. ALL SOIL EROSION AND SEDIMENT CONTROL MEASURES SHALL BE IN ACCORDANCE WITH STANDARDS AND SPECIFICATIONS THEREOF IN NEW HAMPSHIRE DEPARTMENT OF ENVIRONMENTAL SERVICE STORM WATER MANUALS, VOLUME 1-3, LATEST EDITION.
- 3. EROSION AND SEDIMENTATION CONTROL MEASURES SHALL BE INSTALLED PER PLANS AND DETAILS. PERIMETER CONTROLS SHALL BE IN PLACE PRIOR TO COMMENCEMENT OF EARTH DISTURBING ACTIVITIES.
- 4. INSTALL INLET PROTECTION AROUND ALL STORM DRAIN STRUCTURES. INLET PROTECTION BMP'S SHALL REMAIN UNTIL THE SITE IS STABILIZED. CONSTRUCTION OF DRAINAGE BASINS AND SWALES SHALL OCCUR PRIOR TO AND EARTH MOVING OPERATION THAT WILL INFLUENCE STORM WATER RUNOFF.
- 5. THE WORK AREA SHALL BE GRADED, SHAPED AND OTHERWISE DRAINED IN SUCH A MANNER AS TO MINIMIZE SOIL EROSION, SILTATION OF DRAINAGE CHANNELS, DAMAGE TO EXISTING VEGETATION, AND DAMAGE TO PROPERTY OUTSIDE THE LIMITS OF THE WORK AREA.
- 6. EXISTING VEGETATION IS TO REMAIN UNDISTURBED WHEN POSSIBLE.
- 7. EROSION AND SEDIMENTATION CONTROL MEASURES SHALL BE KEPT CLEAN DURING CONSTRUCTION. INSPECTIONS OF EROSION CONTROL MEASURES AND INSTALLATION OF STORMWATER MANAGEMENT SYSTEMS DURING CONSTRUCTION SHALL BE PERFORMED BY A THIRD PARTY STORMWATER CONSULTANT APPROVED BY THE TOWN AT THE APPLICANT'S EXPENSE. EROSION AND SEDIMENTATION CONTROL MEASURES AND ANY CATCH BASINS LOCATED IMMEDIATELY DOWNSTREAM FROM THE CONSTRUCTION SITE SHALL BE INSPECTED AT LEAST ONCE A WEEK AND AFTER EVERY 0.5—INCH OR GREATER RAINFALL. SEDIMENTS ALONG EROSION CONTROLS SHALL BE REMOVED WHEN THEY REACH A MAXIMUM DEPTH OF SIX (6) INCHES. SEDIMENTS SHALL BE DISPOSED OF, WITHIN 24 HOURS OF OBSERVATION, IN AN UPLAND AREA THAT WILL NOT CONTRIBUTE TO SEDIMENT OFF—SITE AND BE PERMANENTLY STABILIZED.
- 8. THE SMALLEST PRACTICAL AREA SHALL BE DISTURBED DURING CONSTRUCTION. AT NO TIME SHALL THE TOTAL UNSTABILIZED DISTURBED AREA, INCLUDING LOT DISTURBANCES, BE GREATER THAN TWO (2) ACRES.
- 9. THE LAND AREA EXPOSED SHALL BE KEPT TO THE SHORTEST PRACTICAL PERIOD OF TIME. ALL NON-ACTIVE DISTURBED AREAS SHALL BE STABILIZED WITHIN 30 DAYS OF THE DISTURBANCE. ALL DISTURBED AREAS SHALL BE STABILIZED WITHIN 72 HOURS OF FINAL GRADING.
- 10. DITCHES, SWALES AND DRAINAGE BASINS SHALL BE CONSTRUCTED DURING THE INITIAL PHASE OF CONSTRUCTION AND STABILIZED PRIOR TO DIRECTING RUNOFF TO THEM.
- 11. AN AREA SHALL BE CONSIDERED STABILIZED IF ONE OF THE FOLLOWING HAS OCCURRED:
 A. BASE COURSE GRAVELS HAVE BEEN INSTALLED IN AREAS TO BE PAVED;
 - B. A MINIMUM OF 85% VEGETATED GROWTH HAS BEEN ESTABLISHED;
 C. A MINIMUM OF 3-INCHES OF NON-FROSIVE MATERIAL SUCH AS STONE OR RIPRAP HAS
 - C. A MINIMUM OF 3-INCHES OF NON-EROSIVE MATERIAL, SUCH AS STONE OR RIPRAP, HAS BEEN INSTALLED; OR
 D. EROSION CONTROL BLANKETS HAVE BEEN PROPERLY INSTALLED.
- 12. EROSION CONTROL BLANKETS OR HECP'S SHALL BE INSTALLED ON ALL SLOPES THAT ARE PRONE TO EROSION AND ON SLOPES STEEPER THAN 3:1 (HORIZONTAL / VERTICAL). UNLESS OTHERWISE SPECIFIED THE CONTRACTOR SHALL USE NORTH AMERICAN GREEN SC150 OR HYDRAMAX (HECP), OR APPROVED
- 13. ALL AREAS RECEIVING EROSION CONTROL STONE OR RIPRAP SHALL HAVE A GEOTEXTILE MATERIAL INSTALLED BELOW THE STONE (SEE APPROPRIATE DETAILS).
- 14. ALL DISTURBED AREAS TO TURF FINISHED SHALL BE COVERED WITH A MINIMUM THICKNESS OF 4 INCHES OF COMPACTED LOAM. LOAM SHALL BE COVERED WITH THE APPROPRIATE SEED MIXTURE AS INDICATED

PERMANENT SEED (LAWN AREAS) LBS / 1.000 SQ. FT. PERMANENT SLOPE SEED MIX LBS / 1.000 SQ. FT.

*1.85 LBS PER 1.000 SF**

CREEPING RED FESCUE PERENNIAL RYEGRASS KENTUCKY BLUEGRASS REDTOP	0.92 LBS 1.15 LBS 0.58 LBS 0.12 LBS	CREEPING RED FESCUE PERENNIAL RYEGRASS REDTOP ALSIKE CLOVER BIRDSFOOT TREFOIL	0.80 LBS 0.69 LBS 0.12 LBS 0.12 LBS
**APPLICATION RATE	TOTALS	**APPLICATION PAT	E TOTALS

- 15. TEMPORARY STABILIZATION OF DISTURBED AREAS:
 STRIPPED SOIL SHALL BE STOCKPILED UNCOMPACTED, AND STABILIZED AGAINST EROSION AS OUTLINED BELOW:
 SEED BED PREPARATION: 10-10-10 FERTILIZATION TO BE SPREAD AT THE RATE OF 7 LBS. PER 100 SF AND AGRICULTURAL LIMESTONE AT A RATE OF 90 LBS PER 1000 SF AND INCORPORATED INTO THE SOIL.
- THE SOIL, FERTILIZER AND LIMESTONE SHALL BE TILLED TO PREPARE FOR SEEDING.

 A. SEED MIXTURE: USE ANY OF THE FOLLOWING:

2.8 LBS PER 1,000 SF**


SPECIES	RATE PER 1,000 SF	DEPTH	SEEDING DATES
WINTER RYE	2.5 LBS 2.5 LBS	1 INCH 1 INCH	8/15 TO 9/15 4/15 TO 10/15 8/15 TO 9/15
ANNUAL RYEGRAS		0.25 INCH	8/15 TO 9/15


B. MULCHING: MULCH SHOULD BE USED ON HIGHLY ERODIBLE AREAS, AND WHERE CONSERVATION OF

IVI	DISTORE WILL PACIFIAT	E FLANT ESTABLISHMENT	AS FULLUMS:
	TYPE	RATE PER 1.000 SF	USE AND COMMENTS
	STRAW	70 TO 90 LBS	MAY BE USED WITH PLANTINGS, MUST BE ANCHORED TO BE USED ALONE
	WOOD CHIPS OR BARK MULCH	460 TO 920 LBS	USED WITH TREE AND SHRUB PLANTINGS
	FIBROUS MATTING	AS RECOMMENDED BY MANUFACTURER	MUST BE BIODEGRADABLE. USE IN SLOPE AREAS AND AREAS DIFFICULT TO VEGETATE
	CRUSHED STONE 1/4" TO 1-1/2" DIA.	SPREAD TO GREATER THAN 1/2" THICKNESS	USE IN SPECIFIC AREAS AS SHOWN ON PLAN OR AS NEEDED

- 16. APPLY LIMESTONE AND FERTILIZER ACCORDING TO SOIL TEST RECOMMENDATIONS. IF SOIL TESTING IS NOT FEASIBLE (CRITICAL TIME FRAMES OR VARIABLE SITES) THEN APPLY FERTILIZER AT A RATE OF 11 POUNDS PER 1,000 SF AND LIMESTONE AT A RATE OF 90 POUNDS PER 1,000 SF. FERTILIZER SHALL BE LOW PHOSPHATE (LESS THAN 2% PHOSPHORUS).
- 17. CAUTION SHOULD BE TAKE WHEN THE PROPERTY IS LOCATED WITHIN 250 FEET OF A WATER BODY. IN THIS CASE ALL FERTILIZERS SHALL BE RESTRICTED TO A LOW PHOSPHATE, SLOW RELEASE NITROGEN FERTILIZER. SLOW RELEASE FERTILIZERS MUST BE AT LEAST 50% SLOW RELEASE NITROGEN COMPONENT. NO FERTILIZER EXCEPT LIMESTONE SHALL BE APPLIED WITHIN 25 FEET OF THE SURFACE WATER. THESE ARE REGULATED LIMITATIONS.
- 18. PERMANENT OR TEMPORARY COVER MUST BE IN PLACE BEFORE THE GROWING SEASON ENDS (SEE WINTER CONSTRUCTION NOTES). NO DISTURBED AREAS SHALL BE LEFT EXPOSED DURING THE WINTER MONTHS.
- 19. A VIGOROUS DUST CONTROL PROGRAM SHALL BE APPLIED BY THE SITE CONTRACTOR. DUST SHALL BE MANAGED THROUGH THE USE OF WATER ONLY (USE OF CALCIUM CHLORIDE IS PROHIBITED IN WPA).
- 20. IN NO WAY ARE THE MEASURES INDICATED ON THE PLANS OR IN THESE NOTES TO BE CONSIDERED ALL INCLUSIVE. THE CONTRACTOR SHALL USE JUDGMENT TO INSTALL ADDITIONAL EROSION CONTROL MEASURES AS SITE CONDITIONS, WEATHER OR CONSTRUCTION METHODS WARRANT.
- 21. FOLLOWING PERMANENT STABILIZATION, TEMPORARY EROSION CONTROL MEASURES SHALL BE REMOVED AND ACCUMULATED SEDIMENTATION IS TO BE DISPOSED OF IN AN APPROVED LOCATION, OUTSIDE OF JURISDICTIONAL WETLANDS.
- 22. SHOULD DEWATERING ACTIVITIES BE REQUIRED, PUMPED GROUNDWATER SHALL BE DIRECTED TO A DEWATERING SUMP PRIOR TO DISCHARGE TO ANY WETLAND RESOURCE AREA OR STORMWATER MANAGEMENT AREA.
- 23. DURING CONSTRUCTION AND INSTALLATION OF THE STORMWATER MANAGEMENT BMP'S, CARE SHOULD BE TAKEN TO MINIMIZE ANY SEDIMENT INTRUSION INTO THESE SYSTEMS. ANY SIGNIFICANT SEDMIENT ACCUMULATION WITHIN THESE SYSTEMS SHALL BE REMOVED WITHIN 24 HOURS OF OBSERVATION.
- 24. THE CONTRACTOR SHALL MAKE EVERY EFFORT TO MINIMIZE THE AMOUNT OF IMPERVIOUS PAVEMENT AREA TRIBUTARY TO THE DRAINAGE SYSTEM AND STORMWATER MANAGEMENT BMP'S UNTIL THE SITE HAS BEEN STABILIZED. THE CONTRACTOR SHALL CONTINUE TO DIRECT SURFACE RUNOFF TO UNPAVED AREAS AS NOTED ABOVE.
- 25. STORMWATER RUNOFF SHALL BE DIRECTED TO TEMPORARY PRACTICES (SEDIMENT TRAPS AND/OR BASINS) UNTIL PROPOSED STORMWATER MANAGEMENT AREAS ARE STABILIZED.

EROSION CONTROL NOTES

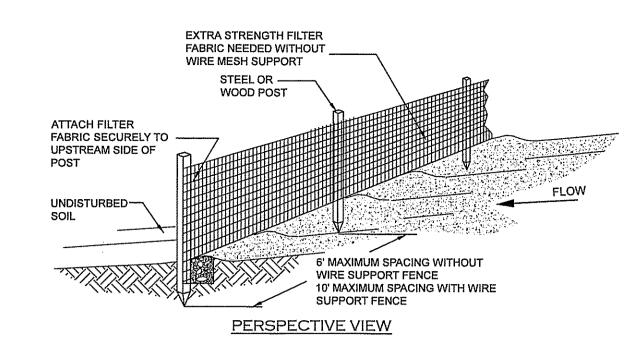

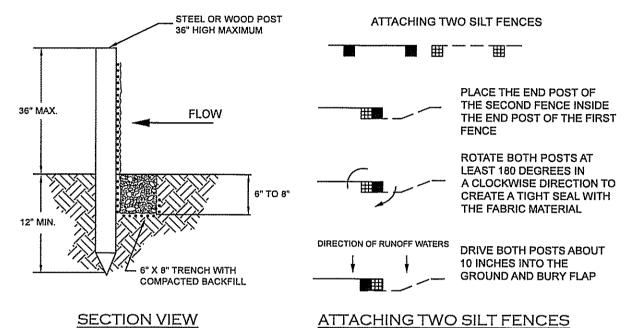


NOTES:

- 1. SILT FENCES SHOULD NOT BE USED ACROSS STREAMS, CHANNELS, SWALES, DITCHES OR OTHER DRAINAGE WAYS
- 2. SILT FENCE SHOULD BE INSTALLED FOLLOWING THE CONTOUR OF THE LAND AS CLOSELY AS POSSIBLE AND THE ENDS OF THE SILT FENCE SHOULD BE FLARED UPSLOPE.
- 3. IF THE SITE CONDITIONS INCLUDE FROZEN GROUND, LEDGE OR THE PRESENCE OF HEAVY ROOTS THE BASE OF THE FABRIC SHOULD BE EMBEDDED WITH A MINIMUM THICKNESS OF 8 INCHES OF 3/4-INCH
- STONE.

 4. SILT FENCES PLACED AT THE TOE OF SLOPES SHOULD BE INSTALLED AT LEAST 6 FEET FROM THE TOE
- TO ALLOW SPACE FOR SHALLOW PONDING AND ACCESS FOR MAINTENANCE.

 5. THE MAXIMUM SLOPE ABOVE THE FENCE SHOULD BE 2:1 AND THE MAXIMUM LENGTH OF SLOPE ABOVE
- THE FENCE SHOULD BE 100 FEET.
- REMOVED SEDIMENT SHALL BE DEPOSITED TO AN AREA THAT WILL NOT CONTRIBUTE TO SEDIMENT OFF-SITE AND CAN BE PERMANENTLY STABILIZED.
- SILT FENCES SHOULD BE REMOVED WHEN THE UPSLOPE AREAS HAVE BEEN PERMANENTLY STABILIZED.


SILT FENCE 2 DT-4

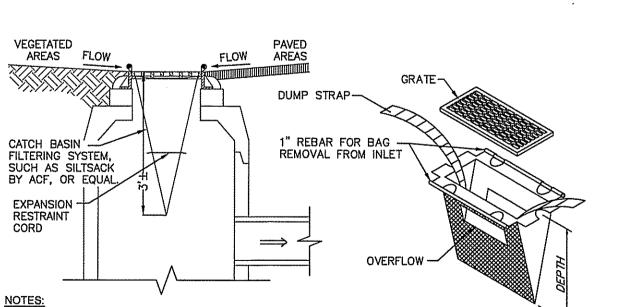

- INSTALL AND MAINTAIN SACKS IN ALL CATCH BASINS.
- 2. TO INSTALL SACK, REMOVE CATCH BASIN GRATE AND PLACE SACK IN OPENING. HOLD OUT APPROXIMATELY SIX INCHES OF THE SACK OUTSIDE THE FRAME FOR THE LIFTING STRAPS. REPLACE THE GRATE TO HOLD THE SACK IN PLACE.
- THE SACK SHOULD BE INSPECTED AFTER EVERY STORM, OR ONCE EVERY TWO WEEKS, WHICH EVER OCCURS FIRST.
- 4. THE RESTRAINT CORD SHOULD BE VISIBLE AT ALL TIMES. IF THE CORD IS COVERED WITH SEDIMENT, THE SACK SHOULD BE EMPTIED. EMPTY THE SACK AWAY FROM THE CATCH BASIN TO PREVENT SEDIMENT FROM RE-ENTERING THE CATCH BASIN. EMPTY THE SACK PER THE MANUFACTURES RECOMMENDATIONS.
- 5. REPLACE THE SACK IN THE CATCH BASIN AFTER THE SACK HAS BEEN EMPTIED. ONCE CONSTRUCTION IS COMPLETE AND ALL DISTURBED AREAS HAVE BEEN STABILIZED BY PAVING OR A HEALTHY VEGETATIVE COVER, REMOVE THE SACK FROM THE CATCH BASINS.

SILT SACK SEDIMENT FILTER

BY
DT-4

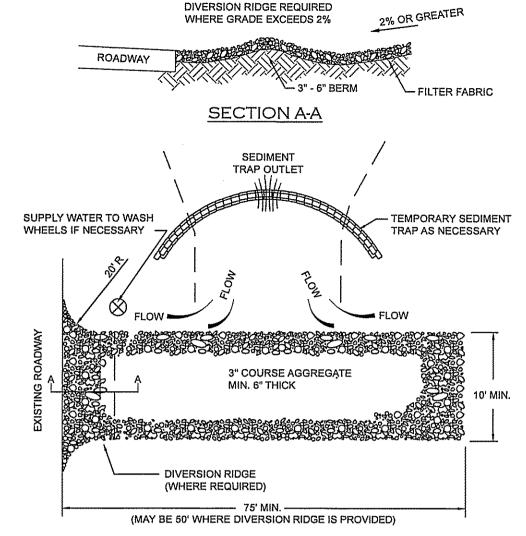

TEC.

 THE ENTRANCE SHALL BE MAINTAINED IN A CONDITION THAT WILL PREVENT TRACKING OR FLOWING OF SEDIMENT ONTO PUBLIC RIGHT-OF-WAYS. THIS MAY REQUIRE TOP DRESSING, REPAIR AND/OR CLEANOUT OF ANY MEASURES USED TO TRAP SEDIMENT.

PLAN VIEW

- 2. THE MINIMUM STONE USED SHOULD BE 3-INCH CRUSHED STONE.
- 3. THE MINIMUM LENGTH OF THE PAD SHOULD BE 75 FEET, EXCEPT THAT THE MINIMUM LENGTH MAY BE REDUCED TO 50 FEET IF A 3-INCH TO 6-INCH HIGH BERM IS INSTALLED AT THE ENTRANCE OF THE PROJECT SITE.
- 4. THE PAD SHOULD EXTEND THE FULL WIDTH OF THE CONSTRUCTION ACCESS ROAD OR 10 FEET, WHICHEVER IS GREATER.
- 5. THE PAD SHOULD SLOPE AWAY FROM THE EXISTING ROADWAY.
- 6. THE PAD SHOULD BE AT LEAST 6-INCHES THICK.
- 7. THE GEOTEXTILE FILTER FABRIC SHOULD BE PLACED BETWEEN THE STONE PAD AND THE EARTH
- 8. THE PAD SHALL BE MAINTAINED OR REPLACED WHEN MUD AND SOIL PARTICLES CLOG THE VOIDS IN THE STONE SUCH THAT MUD AND SOIL PARTICLES ARE TRACKED OFF-SITE.
- 9. NATURAL DRAINAGE THAT CROSSES THE LOCATION OF THE STONE PAD SHOULD BE INTERCEPTED AND PIPED BENEATH THE PAD, AS NECESSARY, WITH SUITABLE OUTLET PROTECTION.
- 10. WHEN NECESSARY, WHEELS SHALL BE CLEANED PRIOR TO ENTRANCE ONTO PUBLIC RIGHT-OF-WAY.
- 11. WHEN WASHING IS REQUIRED, IT SHALL BE DONE ON AN AREA STABILIZED WITH CRUSHED STONE

GRAVEL CONSTRUCTION EXIT



THAT DRAINS INTO AN APPROVED SEDIMENT TRAP OR SEDIMENT BASIN.



REV. DATE DESCRIPTION C/O DR CK

EROSION CONTROL NOTES & DETAILS

TAX MAP 7412Z LOTS 25 & 26
(32-34 S. MAIN STREET & 33 S. STATE STREET)
CONCORD, NEW HAMPSHIRE

JOHN FLATLEY COMPANY

45 DAN ROAD, SUITE 320, CANTON, MA 02021

SCALE: NONE FEBRUARY 16, 2022

Surveying & Engineering & Land Planning & Permitting & Septic Designs

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