BUILDING CODE SYNOPSIS

PROJECT: SERVICE CREDIT UNION LOCATION: 285 LOUDON RD CONCORD, NH

PROPOSED BUILDING GENERAL INFORMATION:

USE GROUP CLASSIFICATION: **BUSINESS (B)**

TYPE OF CONSTRUCTION:

2,344 SF HEIGHT ABOVE GRADE PLANE:

22'-0" (AVERAGE ROOF HEIGHT ABOVE GRADE) STORIES ABOVE GRADE: 1 STORIES NOT REQUIRED. FULL FIRE ALARM SYSTEM REQUIRED

SPRINKLER SYSTEM: ZONING CLASSIFICATION: GWP (GATEWAY PERFORMANCE DISTRICT)

SERVICE CREDIT UNION BRANCH BUILDING CONSISTS OF A WOOD FRAMED ONE STORY, SLAB ON GRADE, NEW CONSTRUCTION BUILDING WITH TWO DRIVE-UP LANES AND A CANOPY. THE INTERIOR WORK WILL INCLUDE NEW CEILINGS. FINISHES, FURNITURE, AND EQUIPMENT. THE BUILDING IS NOT SPRINKLERED BUT IS EQUIPPED WITH A FULLY ADDRESSABLE

THIS ANALYSIS WAS PERFORMED USING THE STANDARDS SET FOURTH IN 2021

INTERNATIONAL BUILDING CODE AND NH AMENDMENTS

APPLICABLE CODES

FIRE ALARM SYSTEM.

CITY OF CONCORD, NH SITE PLAN REGULATIONS ZONING

BUILDING INTERNATIONAL BUILDING CODE 2021 (IBC) WITH NH AMENDMENTS

FIRE PREVENTION NFPA 1, 2021 INTERNATIONAL FIRE CODE.

NH ACCESSIBLE AND USABLE BUILDINGS AND FACILITIES ACCESSIBILITY 2009, ANSI A117.1-2009, 2010 ADA STANDARDS FOR ACCESSIBLE

ELECTRICAL NATIONAL ELECTRIC CODE NFPA 70 2020 WITH AMENDMENTS MECHANICAL 2021 INTERNATIONAL MECHANICAL CODE WITH NH AMENDMENTS

PLUMBING 2021 INTERNATIONAL PLUMBING CODE WITH NH AMENDMENTS

INTERNATIONAL ENERGY CONSERVATION CODE IECC 2021 WITH ENERGY CONSERVATION

CLASSIFICATION OF WORK

SECTION 304 BUSINESS GROUP B - BANK

GENERAL BUILDING HEIGHTS AND AREAS AND TYPE OF CONSTRUCTION

(504.3 & 504.4 & 506.2)

HEIGHT AND AREA ALLOWED: 2 STORIES (40 FEET) AND 9,000 SF / FLOOR

BUILDING ELEMENTS AND MATERIALS (702 & 803 & 903)

PRIMARY STRUCTURAL FRAME, BEARING WALLS, NON-BEARING WALLS, FLOOR CONSTRUCTION AND ROOF CONSTRUCTION WILL HAVE A "0 HOUR" FIRE RESISTANCE RATING.

FIRE RESISTANCE RATING REQUIRED FOR BUILDING ELEMENTS

PRIMARY STRUCTURAL FRAME, BEARING WALLS, NON-BEARING WALLS, FLOOR CONSTRUCTION AND ROOF CONSTRUCTION WILL HAVE A "0 HOUR" FIRE RESISTANCE RATING. FIRE RESISTANCE RATING FOR EXTERIOR WALLS BASED ON FIRE

SEPARATION DISTANCE

>30 FEET BETWEEN BUILDINGS, TYPE VB "0 HOUR" FIRE RESISTANCE RATING.

FIRE PROTECTION SYSTEMS (901)

THE BUILDING IS NOT REQUIRED BE EQUIPPED WITH A FULLY AUTOMATIC SPRINKLER SYSTEM AS IT IS A 1-STORY (B) OCCUPANCY WITH AN AREA LESS THAN 5,000 SF.

MEANS OF EGRESS (1004)

MAXIMUM FLOOR AREA ALLOWANCE PER OCCUPANT. BUSINESS AREAS 150 SF GROSS

(2,344 SF / 150 = 16 OCCUPANTS CALCULATED) NUMBER OF EXITS: TABLE 1006.2.1

THERE WILL BE 1 PUBLIC EXIT PROVIDED, 2 EXITS TOTAL (1 FOR EMPLOYEES ONLY) CAPACITY OF EGRESS COMPONENTS (1005.3.2):

DOORS (16 X .2" = 3.2") 36" MINIMUM PROVIDED.

MAXIMUM TRAVEL DISTANCE: 68'-4" (100' ALLOWED: <30 OCCUPANTS UNSPRINKLERED)

ALL WORK PERFORMED WILL COMPLY WITH ICC A117.1. ACCESSIBLE AND USABLE

STRUCTURAL (CHAPTER 16)

ALL STRUCTURAL WORK PERFORMED WILL COMPLY WITH CHAPTER 16 OF THE 2021

ELECTRICAL (2701 & 2702)

ALL ELECTRICAL WORK WILL COMPLY WITH NFPA 70 AND OTHER APPLICABLE CODES.

MECHANICAL (2801)

IBC AS APPLICABLE.

ALL MECHANICAL WORK WILL COMPLY WITH SECTION 2801 AND THE 2021 IMC AS

PLUMBING (2901 & 2902)

ALL PLUMBING & PLUMBING FIXTURES PERFORMED WILL COMPLY WITH SECTION 810 AS APPLICABLE. SEE TABLE FOR MINIMUM PLUMBING FIXTURES REQUIRED.

ENERGY CONSERVATION (1301)


REFER TO COM CHECK COMPLIANCE REPORTS.

2 + WATER DISPENSER

TABLE 403.1: MINIMUM NUMBER OF PLUMBING FIXTURES. 2021 IPC

CCUPANCY: (B) BUS	INESS, 16 OCCUPAN	ITS					
	WATER CLOSETS		LAVATORIES		SHOWERS	DRINKING FOUNTAIN	OTHER
	MALE	FEMALE	MALE	FEMALE	-	-	-
PROVISION	1 PER 25 FOR THE FIRST 50 AND 1 PER 50 FOR THE REMAINDER EXCEEDING 50		1 PER 40 FOR THE FIRST 80 AND 1 PER 80 FOR THE REMAINDER EXCEEDING 80		0	1 PER 100	1 SERVICE SINK
REQUIRED	1	1	1	1	0	1	1


LOCATION MAP

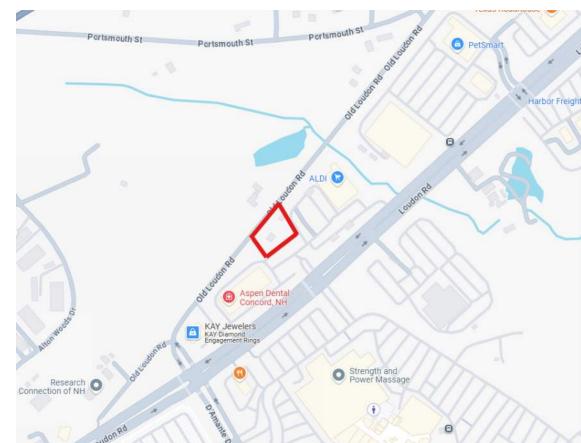

EGRESS NOTES

- EMERGENCY LIGHTING NOT SHOWN. SEE ELECTRICAL PLANS IF APPLICABLE. SMOKE AND HEAT DETECTORS NOT SHOWN. SEE FIRE ALARM PLANS IF APPLICABLE.
- MAX DEAD END CORRIDOR WHEN 2 OR MORE EXITS ARE REQUIRED = 20'-0" NON
- SPRINKLERED, 50'-0" SPRINKLERED PER IBC 1020.4. ONE EXIT ALLOWED PER TABLE 1006.2.1: < 30 OCCUPANTS = 100': > 30-49 OCC. = 75' TRAVEL
- EXIT ACCESS TRAVEL DISTANCE WITH 2 OR MORE EXITS PER TABLE 1017.2: 250' OR 300' WITH AUTOMATIC SPRINKLER SYSTEM.

EGRESS KEY

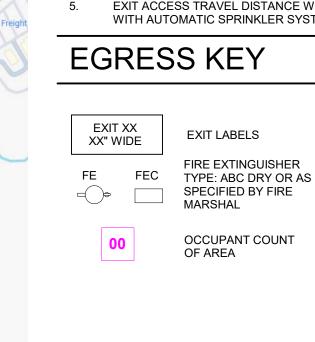



EXIT 1A: ACCESSIBLE

SERVES 16 OCCUPANTS

LINE OF CANOPY ABOVE

36" WIDE

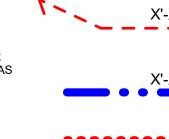

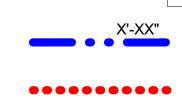

...

MAXIMUM COMMON PATH OF TRAVEL DISTANCE = 65'-0"

EGRESS PATH AND DISTANCE FROM POINT TO POINT DIAGONAL BUILDING

TOTAL TRAVEL DISTANCE MEASUREMENT AND EXIT SEPARATION DISTANCE

WALLS - MAINTAIN RATING.

905 South Main Street • Design & Project Building B, Suite 201 Consultant Mansfield, MA 02048 Project Management 508-339-6600

905 S. Main St. Bldg B Ste 201 Mansfield, MA 02048

781-331-8541

nes-grouparchitects.com

©COPYRIGHT NES GROUP ARCHITECTS, PC.

ALL RIGHTS RESERVED. NO USE OR REPRODUCTION OF THIS
MATERIAL IS PERMITTED WITHOUT THE WRITTEN CONSENT OF
NES GROUP ARCHITECTS, PC.

www.nes-group.com

Date Description

> SCU - CONCORD, NH 285 LOUDON RD CONCORD, NH

PROJECT INFORMATION & CODE ANALYSIS


25003 Project Number Project Status Project Status Date Issue Date Drawn By Author Checker Checked By

A001

As indicated Scale

DO NOT SCALE DRAWING, USE DIMENSIONS SHOWN. VERIFY ALL DIMENSIONS ON SITE.

EXIT 1A: ACCESSIBLE 36" WIDE SERVES EMPLOYEES ONLY

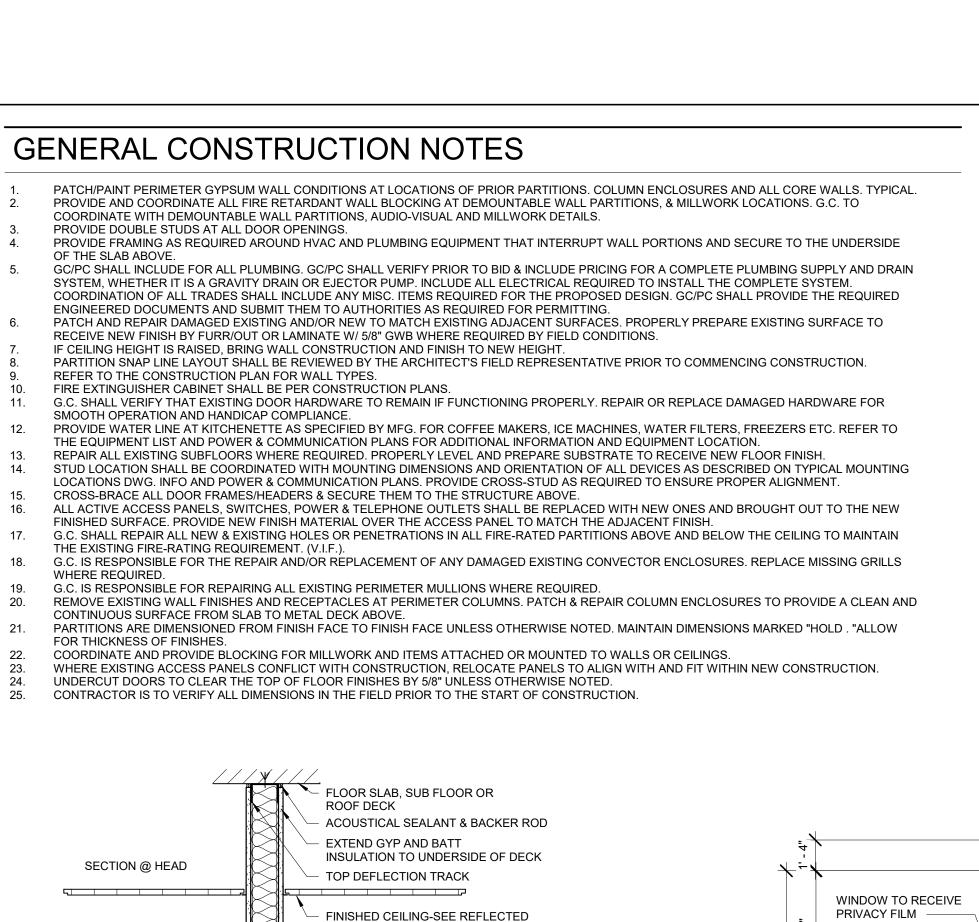

CEILING PLAN OR FINISH SCHEDULE

ALL JOINTS SHALL BE TAPED AND

W/ JOINT COMPOUND

SIDE OF STUDS.

1: 2 7/8" TOTAL WIDTH - 1 5/8" METAL STUD - 5/8" GWB EA. SIDE - INSULATION

1A: 3 3/4" TOTAL WIDTH - 2 1/2" METAL STUD - 5/8" GWB EA. SIDE - INSULATION

1B: 4 7/8" TOTAL WIDTH - 3 5/8" METAL STUD - 5/8" GWB EA. SIDE - INSULATION 1C: 7 1/4" TOTAL WIDTH - 6" METAL STUD - 5/8" GWB EA. SIDE - INSULATION 1D: 9 1/4" TOTAL WIDTH - 8" METAL STUD - 5/8" GWB EA. SIDE - INSULATION

PLAN SECTION

SECTION @ BASE

1" = 1'-0" PARTITION TYPE 1, 1A, 1B, 1C, 1D

SECTION @ HEAD

PLAN SECTION

SECTION @ BASE

PARTITION TYPE 2, 2A, 2B, 2C, 2D 1" = 1'-0" COVERED W/ JOINT COMPOUND. ALL

SOUND ATTENUATION BATT INSULATION

SCREW HEADS SHALL BE COVERED

20 GAUGE G40 STEEL STUDS @ 16"

(1) LAYER OF 5/8" TYPE X" GWB EACH

RUNNER CHANNEL - 20 GAUGE G40 STEEL

ACTUATED FASTENERS @ 24" O.C. MAX

FINISH FLOOR - SEE FINISH SCHEDULE

FLEXIBLE SEALANT, 1/4" MAX.

FLOOR SLAB, SUB FLOOR OR

TOP DEFLECTION TRACK

W/ JOINT COMPOUND

SIDE OF STUDS.

2: 2 7/8" TOTAL WIDTH - 1 5/8" METAL STUD - 5/8" GWB EA. SIDE - NO INSULATION

2A: 3 3/4" TOTAL WIDTH - 2 1/2" METAL STUD - 5/8" GWB EA. SIDE - NO INSULATION

2B: 4 7/8" TOTAL WIDTH - 3 5/8" METAL STUD - 5/8" GWB EA. SIDE - NO INSULATION 2C: 7 1/4" TOTAL WIDTH - 6" METAL STUD - 5/8" GWB EA. SIDE - NO INSULATION

2D: 9 1/4" TOTAL WIDTH - 8" METAL STUD - (2) 1/4" FLEX BOARD EA. SIDE - NO INSULATION

ACOUSTICAL SEALANT & BACKER ROD

EXTEND GYP TO UNDERSIDE OF DECK

FINISHED CEILING-SEE REFLECTED

ALL JOINTS SHALL BE TAPED AND COVERED W/ JOINT COMPOUND. ALL SCREW HEADS SHALL BE COVERED

20 GAUGE G40 STEEL STUDS @ 16" O.C.

CUT 3/8" TO 3/4" LESS THAN ASSEMBLY

(1) LAYER OF 5/8" TYPE X" GWB EACH

RUNNER CHANNEL - 20 GAUGE G40 STEEL TRACK. ATTACH TO SLAB WITH

FLEXIBLE SEALANT, 1/4" MAX.


POWER ACTUATED FASTENERS @ 24"

FINISH FLOOR - SEE FINISH SCHEDULE

3 CONSTRUCTION PLAN
1/4" = 1'-0"

CEILING PLAN OR FINISH SCHEDULE

ROOF DECK

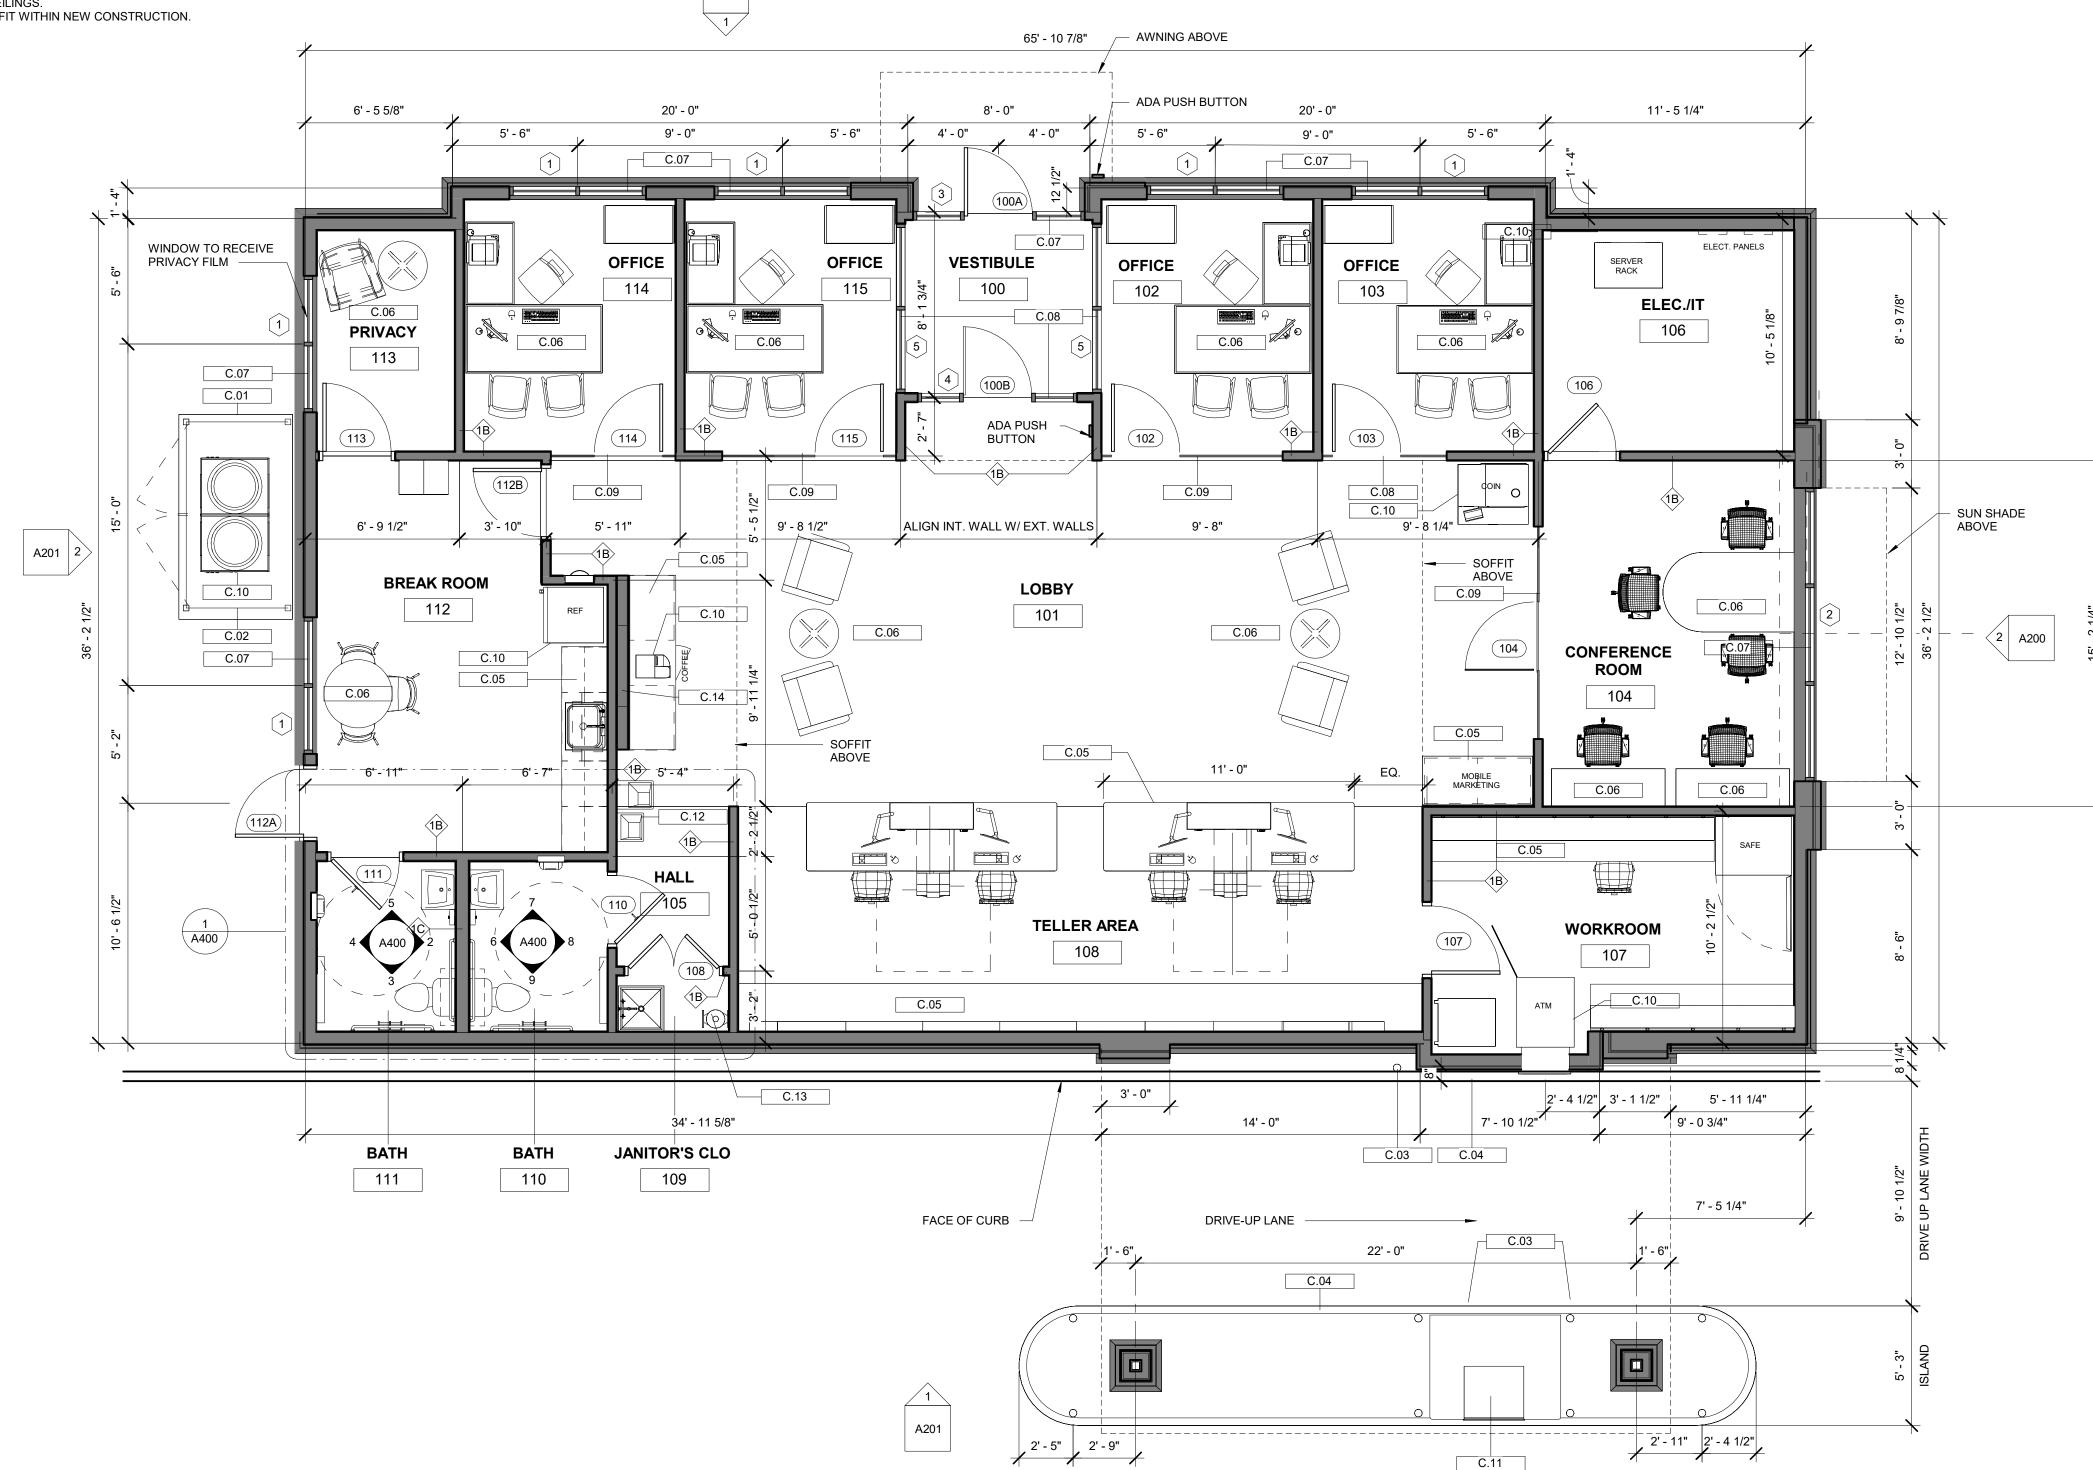

KEYNOTE LEGEND

C.04 6" CURB. REFER TO CIVIL DRAWINGS.

GRAPHICS BY OTHERS.

FURNITURE BY FURNITURE VENDOR. (N.I.C.)

C.11 ATM DRIVE-UP EQUIPMENT. REFER TO EQUIPMENT SCHEDULE.

C.02 8 FT HIGH VINYL FENCE ENCLOSURE W/ DOUBLE DOOR GATE FOR SERVICING.

C.10 BANK EQUIPMENT (N.I.C.) G.C. TO COORDINATE INSTALLATION. REFER TO EQUIPMENT PLAN & SCHEDULE

C.12 BI-LEVEL ADA DRINKING FOUNTAIN W/ INTEGRAL BOTTLE FILLING STATION BY ELKAY. MODEL # EZSTL8WSLK

C.13 WALL MOUNTED SHELVES AND WATER HEATER. REFER TO MEP DWGS FOR WATER HEATER SPECIFICATIONS.

C.03 4" CONC. BOLLARD W/ WHITE VINYL COVER. REFER TO CIVIL DRAWINGS.

DESCRIPTION

TRIFAB VERSAGLAZE 451T THERMALLY BROKEN STOREFRONT SYSTEM BY KAWNEER. PROVIDE 1" INSULATED GLASS (CENTER GLAZED) AND CLEAR ANODIZED ALUMINUM FINISH.

FRAMELESS OFFICE FRONT BY CRL. PROVIDE BUTT GLAZED JOINTS W/ 1/2" TEMPERED GLASS PER MANUF. STD. DETAILS AND CLEAR ANODIZED ALUMINUM FINISH. WINDOW FROSTING

905 S. Main St. Bldg B Ste 201

Mansfield, MA 02048

781-331-8541

nes-grouparchitects.com

©COPYRIGHT NES GROUP ARCHITECTS, PC

ALL RIGHTS RESERVED. NO USE OR REPRODUCTION OF THIS MATERIAL IS PERMITTED WITHOUT THE WRITTEN CONSENT OF NES GROUP ARCHITECTS, PC.

905 South Main Street • Design & Project

Description

SCU - CONCORD, NH

285 LOUDON RD CONCORD, NH

CONSTRUCTION

FLOOR PLAN

Project Number

Project Status

Date

Drawn By

Checked By

Scale

25003

Project Status

Issue Date

SMG

Checker

As indicated

DO NOT SCALE DRAWING, USE DIMENSIONS SHOWN. VERIFY ALL DIMENSIONS ON SITE.

Consultant

Project Management

Date

Building B, Suite 201

Mansfield, MA 02048

www.nes-group.com

508-339-6600

TRIFAB VERSAGLAZE 450 STOREFRONT SYSTEM BY KAWNEER. PROVIDE 1/4" CLEAR TEMPERED GLASS (CENTER GLAZED) AND CLEAR ANODIZED ALUMINUM FINISH.

C.01 6" CONC. PAD FOR MECH. EQUIPMENT. VERIFY EXACT SIZE W/ MECH. DWGS & UNIT CLEARANCES. CENTER BETWEEN WINDOWS. REFER TO CIVIL DWGS

C.05 MILLWORK/CASEWORK. REFER TO ENLARGED MILLWORK PLANS & DETAILS. G.C. TO COORDINATE BACKING/SUPPORT FOR ALL WALL MOUNTED FIXTURES

C.14 WALL MOUNTED TV. VERIFY MOUNTING HEIGHT IN FIELD. G.C. TO COORDINATE POWER AND DATA OUTLETS AND BLOCKING FOR SUPPORT

MARK

LINE ABOVE (CEILING,

WALL TYPE TAG, SEE

DOOR TAG - SEE DOOR

WALL TYPES

ROOM NAME

ROOM TAG

SCHEDULE

FINISH TAG, SEE

FINISH SCHEDULE

XXX

101

XX-0

SOFFIT, MILLWORK, ETC.)

CONSTRUCTION LEGEND

NEW PARTITION - SEE

PARTITION TYPES

NEW HALF WALL TO


CONSTRUCTION

REVISION TAG

NEW DOOR, SEE

DOOR SCHEDULE

(101)

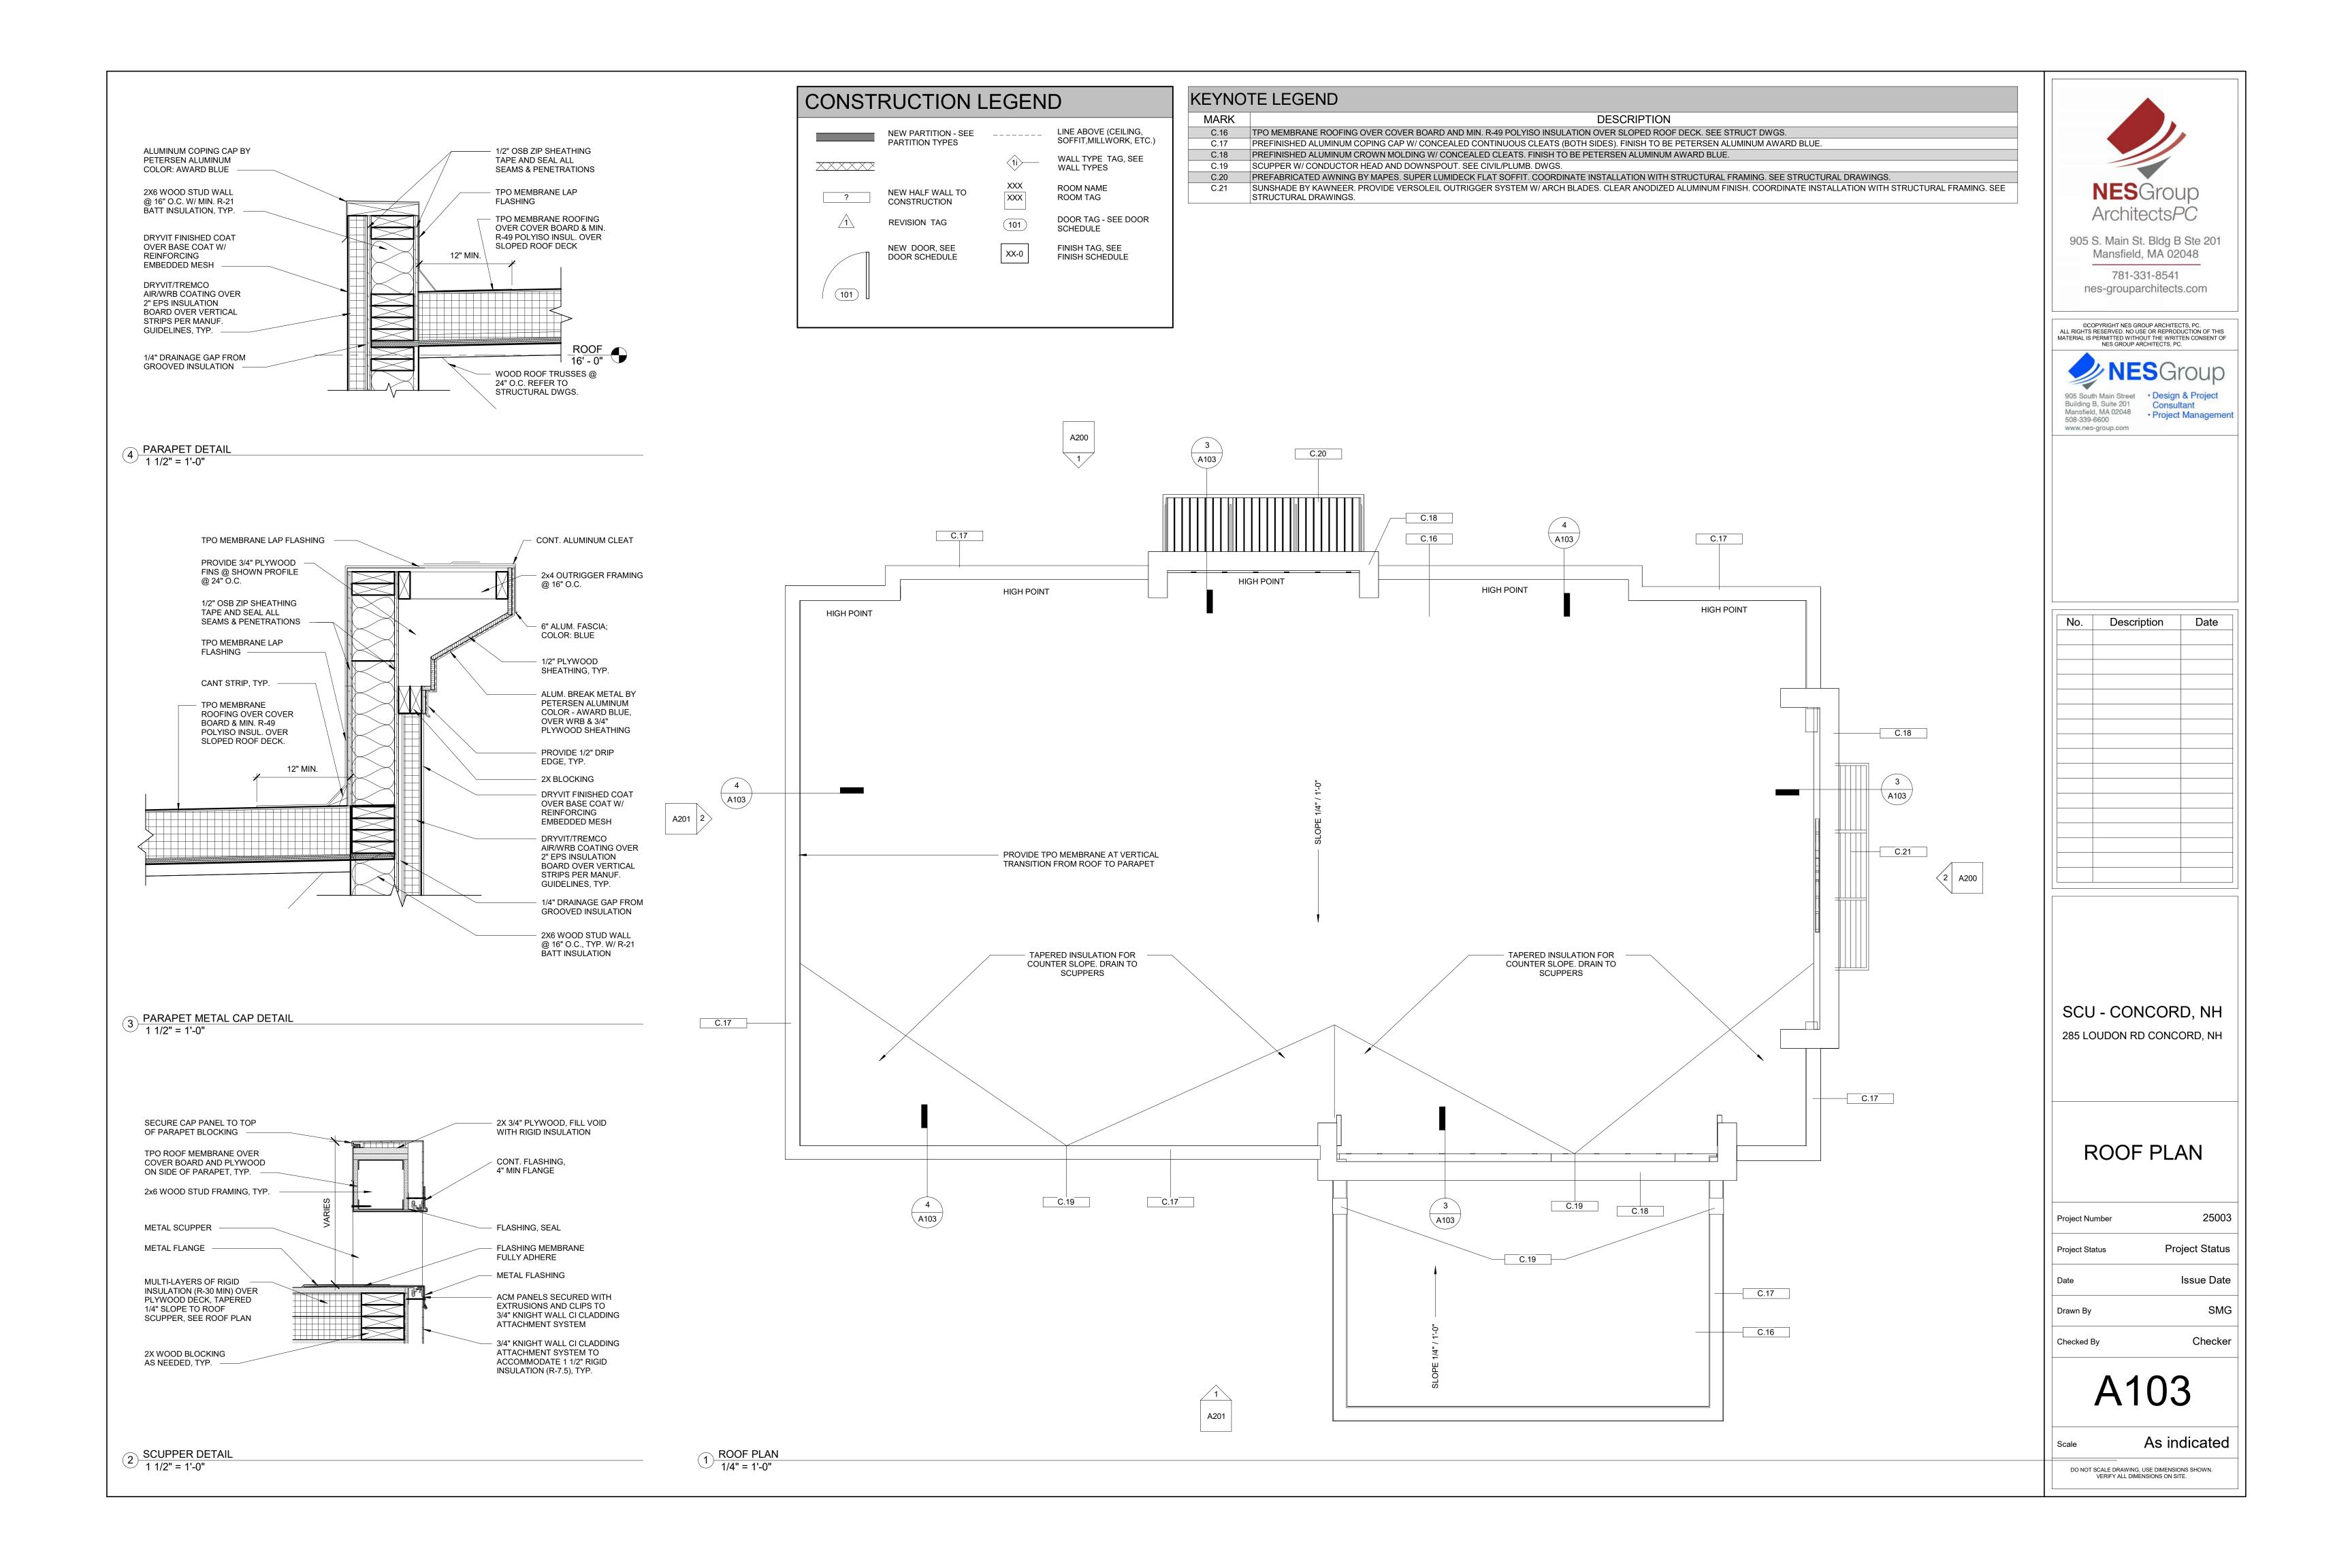

KEYNOTE LEGEND				
	TE LEGENTS			
MARK	DESCRIPTION			
E.01	THIN STONE VENEER BY DELGADO STONE. PROVIDE NEW YORK BLEND WITH ASHLAR PATTERN. INCLUDE STONE SILL & INSTALL PER MANUFACTURER'S STANDARD GUIDELINES.			
E.02	FIBER CEMENT VERTICAL PANELS BY NICHIHA. PROVIDE VINTAGEWOOD SERIES IN BARK FINISH. PROVIDE ALL TRIM & ACCESSORIES FOR A COMPLETE INSTALLATION. FOLLOW MANUFACTURER'S STANDARD GUIDELINES FOR INSTALLATION.			
E.03	E.I.F.S DRYVIT OUTSULATION PLUS MD SYSTEM IN SUPER WHITE. EPS INSULATION TO BE 2" MIN IN DEPTH WITH 1/4" X 1" GROOVES ON THE BACK SIDE FOR DRAINAGE. PROVIDE 1" REVEALS AS INDICATED ON ELEVATIONS. MIN. 3/4" EPS DEPTH AT REVEALS. INSTALL PER MANUFACTURER'S STANDARD GUIDELINES.			
E.04	.032" PREFINIHSED ALUMINUM ROOF EDGE SYSTEM & CROWN MOULDING BY PAC-CLAD / PETERSEN ALUMINUM. COLOR: AWARD BLUE. INSTALL PER MANUFACTURER'S STANDARD INSTALLATION METHODS. PROVIDE CONCEALED CONTINUOUS CLEATS, SPLICE PLATES, MITERED CORNERS, AND END CAPS.			
E.05	STOREFRONT WINDOW SYSTEM BY KAWNEER. PROVIDE TRIFAB VERSAGLAZE 451T (THERMALLY BROKEN) 2" SIGHTLINES x 4-1/2" DEPTH - CLEAR ANODIZED. USE 350 MEDIUM STYLE DOORS W/ 10" BOTTOM RAILS. COORDINATE DOORS W/ AUTOMATIC OPENERS/CLOSERS, CARD READERS, AND ELECTRIC STRIKES. PROVIDE 1" LOW-E INSULATED GLASS. INSTALL PER MANUFACTURER'S STANDARD INSTALLATION GUIDELINES.			
E.06	SUNSHADE BY KAWNEER. PROVIDE VERSOLEIL OUTRIGGER SYSTEM W/ ARCH BLADES. CLEAR ANODIZED ALUMINUM FINISH. COORDINATE INSTALLATION WITH STRUCTURAL FRAMING. SEE STRUCTURAL DRAWINGS.			
E.07	PREFABRICATED AWNING BY MAPES. SUPER LUMIDECK FLAT SOFFIT IN BLACK. COORDINATE INSTALLATION WITH STRUCTURAL FRAMING. SEE STRUCTURAL DRAWINGS.			
E.11	8 FT HIGH WHITE VINYL FENCE W/ STEEL FRAME BACK AND ALUMINUM STIFFENERS IN POSTS AND HORIZONTAL RAILS. COORDINATE POST MOUNTING WITH STRUCTURAL CONCRETE FOOTING. POSTS TO BE 8 FT MAX. SPACING ON CENTER. PROVIDE EQUAL SECTIONS. PROVIDE INTEGRAL GATE AS SHOWN ON DRAWINGS. REFER TO CIVIL DRAWINGS.			
E.12	SIGNAGE BY OTHERS (N.I.C.)			
E.13	EXTERIOR WALL SCONCE. REFER TO LIGHTING FIXTURE SCHEDULE. SEE CIVIL AND ELECTRICAL DRAWINGS.			

1) Elevation Front - Southeast 1/4" = 1'-0"





Date

NESGroup Architects*PC*

905 S. Main St. Bldg B Ste 201 Mansfield, MA 02048

781-331-8541 nes-grouparchitects.com

©COPYRIGHT NES GROUP ARCHITECTS, PC.
ALL RIGHTS RESERVED. NO USE OR REPRODUCTION OF THIS
MATERIAL IS PERMITTED WITHOUT THE WRITTEN CONSENT OF
NES GROUP ARCHITECTS, PC.

905 South Main Street
Building B, Suite 201
Mansfield, MA 02048
508-339-6600

• Design & Project
Consultant
• Project Management

Description

www.nes-group.com

SCU - CONCORD, NH 285 LOUDON RD CONCORD, NH

EXTERIOR ELEVATIONS


Project Number	25003
Project Status	Project Status
Date	Issue Date
Drawn By	SMC
Checked By	Checke
	Project Status Date Drawn By


A200

Scale 1/4" = 1'-0"

DO NOT SCALE DRAWING, USE DIMENSIONS SHOWN. VERIFY ALL DIMENSIONS ON SITE.


KEYNOTE LEGEND				
MARK	DESCRIPTION			
E.01	THIN STONE VENEER BY DELGADO STONE. PROVIDE NEW YORK BLEND WITH ASHLAR PATTERN. INCLUDE STONE SILL & INSTALL PER MANUFACTURER'S STANDARD GUIDELINES.			
E.02	FIBER CEMENT VERTICAL PANELS BY NICHIHA. PROVIDE VINTAGEWOOD SERIES IN BARK FINISH. PROVIDE ALL TRIM & ACCESSORIES FOR A COMPLETE INSTALLATION. FOLLOW MANUFACTURER'S STANDARD GUIDELINES FOR INSTALLATION.			
E.03	E.I.F.S DRYVIT OUTSULATION PLUS MD SYSTEM IN SUPER WHITE. EPS INSULATION TO BE 2" MIN IN DEPTH WITH 1/4" X 1" GROOVES ON THE BACK SIDE FOR DRAINAGE. PROVIDE 1" REVEALS AS INDICATED ON ELEVATIONS. MIN. 3/4" EPS DEPTH AT REVEALS. INSTALL PER MANUFACTURER'S STANDARD GUIDELINES.			
E.04	.032" PREFINIHSED ALUMINUM ROOF EDGE SYSTEM & CROWN MOULDING BY PAC-CLAD / PETERSEN ALUMINUM. COLOR: AWARD BLUE. INSTALL PER MANUFACTURER'S STANDARD INSTALLATION METHODS. PROVIDE CONCEALED CONTINUOUS CLEATS, SPLICE PLATES, MITERED CORNERS, AND END CAPS.			
E.05	STOREFRONT WINDOW SYSTEM BY KAWNEER. PROVIDE TRIFAB VERSAGLAZE 451T (THERMALLY BROKEN) 2" SIGHTLINES x 4-1/2" DEPTH - CLEAR ANODIZED. USE 350 MEDIUM STYLE DOORS W/ 10" BOTTOM RAILS. COORDINATE DOORS W/ AUTOMATIC OPENERS/CLOSERS, CARD READERS, AND ELECTRIC STRIKES. PROVIDE 1" LOW-E INSULATED GLASS. INSTALL PER MANUFACTURER'S STANDARD INSTALLATION GUIDELINES.			
E.06	SUNSHADE BY KAWNEER. PROVIDE VERSOLEIL OUTRIGGER SYSTEM W/ ARCH BLADES. CLEAR ANODIZED ALUMINUM FINISH. COORDINATE INSTALLATION WITH STRUCTURAL FRAMING. SEE STRUCTURAL DRAWINGS.			
E.07	PREFABRICATED AWNING BY MAPES. SUPER LUMIDECK FLAT SOFFIT IN BLACK. COORDINATE INSTALLATION WITH STRUCTURAL FRAMING. SEE STRUCTURAL DRAWINGS.			
E.08	5X5 ALUMINUM DOWNSPOUT & SCUPPER IN BLACK FINISH. TIE INTO UNDERGROUND STORMWATER SEWER SYSTEM. SEE PLUMBING DRAWINGS.			
E.09	EXTRUDED ALUMINUM LOUVER W/ WHITE FINISH. COORDINATE WITH MECHANICAL LAYOUT. SEE MECHANICAL DRAWINGS.			
E.10	4" CONCRETE BOLLARD 36" ABOVE CURB W/ WHITE VINYL COVERS. COORDINATE WITH STRUCTURAL CONCRETE FOOTING. REFER TO CIVIL DRAWINGS.			
E.11	8 FT HIGH WHITE VINYL FENCE W/ STEEL FRAME BACK AND ALUMINUM STIFFENERS IN POSTS AND HORIZONTAL RAILS. COORDINATE POST MOUNTING WITH STRUCTURAL CONCRETE FOOTING. POSTS TO BE 8 FT MAX. SPACING ON CENTER. PROVIDE EQUAL SECTIONS. PROVIDE INTEGRAL GATE AS SHOWN ON DRAWINGS. REFER TO CIVIL DRAWINGS.			
E.13	EXTERIOR WALL SCONCE. REFER TO LIGHTING FIXTURE SCHEDULE. SEE CIVIL AND ELECTRICAL DRAWINGS.			

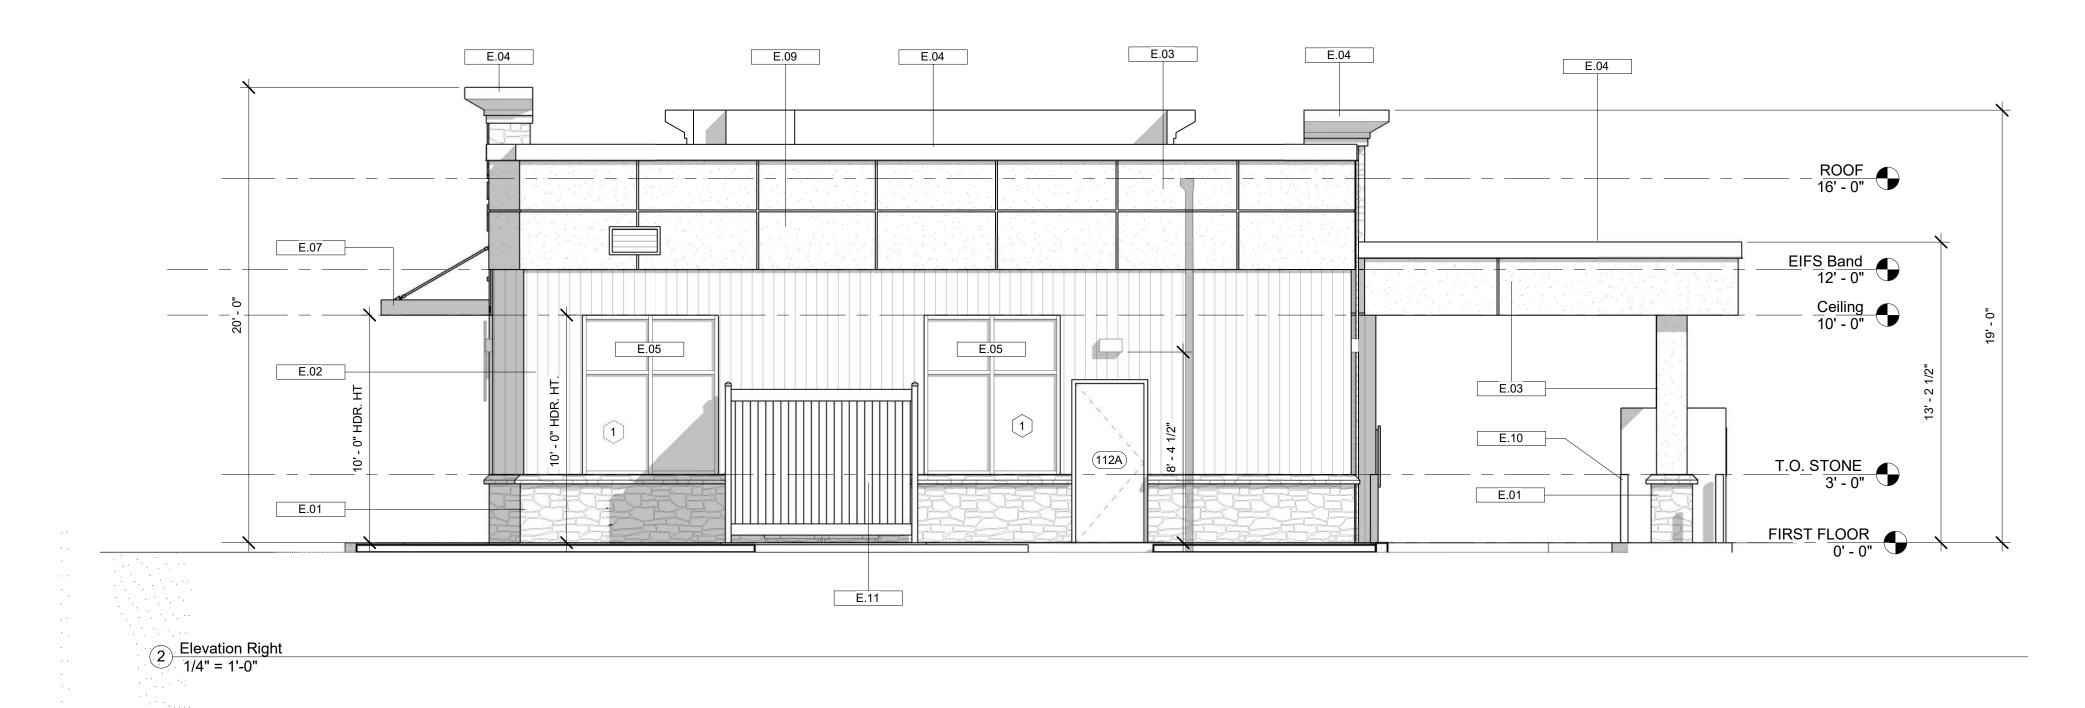

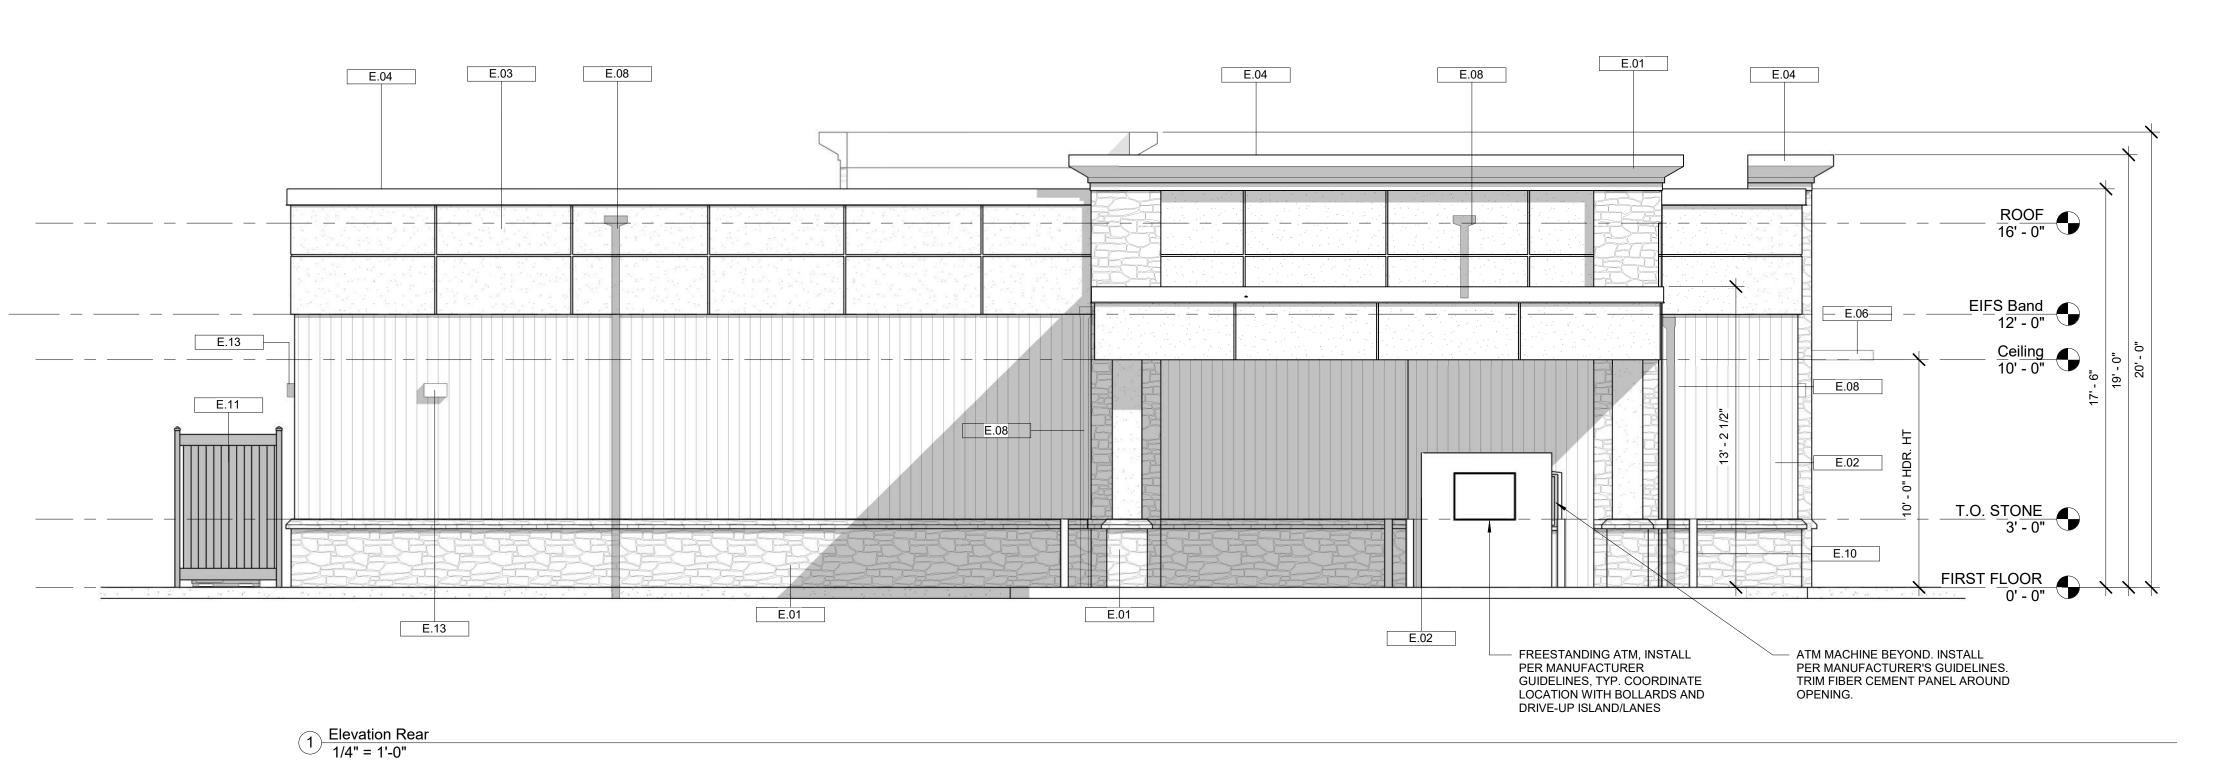



Mansfield, MA 02048
781-331-8541
nes-grouparchitects.com

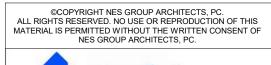



www.nes-group.com

No.	Description	Date

SCU - CONCORD, NH 285 LOUDON RD CONCORD, NH

EXTERIOR ELEVATIONS

Project Number	25003
Project Status	Project Status
Date	Issue Date
Drawn By	Author
Checked By	Checker

A201

Scale 1/4" = 1'-0"

DO NOT SCALE DRAWING, USE DIMENSIONS SHOWN.
VERIFY ALL DIMENSIONS ON SITE.





























FRONT VIEW







SIDE VIEW







DRIVE-UP VIEW







REAR VIEW

