

MATERIALS LEGEND

SYM.	DET.	DESCRIPTION
PAVING		
A1a		BITUMINOUS CONCRETE PAVING, VEHICULAR, SEE CIVIL DWG
A1b		BITUMINOUS CONCRETE PAVING, PEDESTRIAN, SEE CIVIL DWG
SITE FURNITURE		
F1	1 U7.1	TRASH AND RECYCLING RECEPTACLE
F2	4 U7.1	BIKE RACKS
F3	1 U7.1	MONUMENTAL SEATING FEATURE
F4	8 U7.1	FLAG POLE
F5	9 U7.1	PEDESTRIAN FOOTBRIDGE AT RAIN GARDEN
F6	10 U7.1	BOULDERS
F7a	1 U7.3	ORNAMENTAL METAL FENCE - 4' HEIGHT
F7b	2 U7.3	ORNAMENTAL METAL GATE WITH PUSH BAR - 4' WIDE
F8a		CHAIN LINK FENCE - 4'-0" HEIGHT - REFER TO CIVIL DRAWINGS
F8b	3 U7.3	CHAIN LINK FENCE - 10'-0" HEIGHT

SYM. DET. DESCRIPTION

A11	9 U7.1	FLAGSTONE PAVING
A12		RIP RAP - 4"-10" - COLOR TO MATCH FLAGSTONE PAVING
SITE FURNITURE		
F1	1 U7.2	TRASH AND RECYCLING RECEPTACLE
F2	4 U7.2	BIKE RACKS
F3	1 U7.4	MONUMENTAL SEATING FEATURE
F4	8 U7.4	FLAG POLE
F5	9 U7.4	PEDESTRIAN FOOTBRIDGE AT RAIN GARDEN
F6	10 U7.4	BOULDERS
F7a	1 U7.3	ORNAMENTAL METAL FENCE - 4' HEIGHT
F7b	2 U7.3	ORNAMENTAL METAL GATE WITH PUSH BAR - 4' WIDE
F8a		CHAIN LINK FENCE - 4'-0" HEIGHT - REFER TO CIVIL DRAWINGS
F8b	3 U7.3	CHAIN LINK FENCE - 10'-0" HEIGHT

SYM. DET. DESCRIPTION

F9a	1 U7.4	PLAY EQUIPMENT-TYPE 1
F9b	2 U7.4	PLAY EQUIPMENT-TYPE 2
F9c	3 U7.4	PLAY EQUIPMENT-TYPE 3
F9d	4 U7.4	PLAY EQUIPMENT-TYPE 4
F9e	5 U7.4	PLAY EQUIPMENT-TYPE 5
F10		BASKETBALL OUTFITS - QTY 4
F11	6 U7.2	PICNIC TABLE
F12	7 U7.2	DINING TABLE & CHAIRS
F13		VEHICULAR GATE - SEE CIVIL DWGS.
F14		AREA DRAIN - REFER TO CIVIL DWGS.
F15a	2 U7.2	BENCH
F15b		TEAM BENCH
F16	4 U7.1	LANDSCAPE METAL EDGING

SYM. DET. DESCRIPTION

F17	4 U7.3	METAL GUARDRAIL
F18a		BOLLARD - REFER TO CIVIL DWGS.
F18b	3 U7.2	PEDESTRIAN BOLLARD
F19		ENTRY SIGN, REFER TO ARCH DWGS.
F20		PV PARKING CANOPY - REFER TO MECHANICAL DRAWINGS
CURBS, WALLS AND STAIR		
W1		ROADWAY CURB - REFER TO CIVIL DWGS
W2		ACCESSIBLE CURB RAMP WITH DETECTABLE WARNING - REFER TO CIVIL DWGS.
W3		FLUSH CURB - REFER TO CIVIL DWGS
W4	7 U7.2	CAST-IN-PLACE CONCRETE RETAINING WALL
W5	7 U7.1	CAST-IN-PLACE FLUSH CONCRETE CURB
W6		DETECTABLE WARNING STRIP - REFER TO CIVIL DRAWINGS
W7		NO MOW SEED MIX PLANTING
W8		UPLAND SEED MIX PLANTING
SPORT FIELDS		
S1		MULTIUSE PLAY FIELD



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DESCRIPTION

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GRADING LEGEND


SYMBOL	DESCRIPTION
—	EXISTING CONTOUR
—	PROPOSED CONTOUR
(XXX)	EXISTING SPOT ELEVATION
+	PROPOSED SPOT ELEVATION
RIM	TOP OF DRAINAGE INLET
HP	HIGH POINT
EX	EXISTING GRADE TO REMAIN
FFE	FINISH FLOOR ELEVATION
TW	TOP OF WALL ELEVATION
BW	BOTTOM OF WALL ELEVATION
TC	TOP OF CURB ELEVATION
BC	BOTTOM OF CURB ELEVATION
TS	TOP OF STEP ELEVATION
BS	BOTTOM OF STEP ELEVATION
TR	TOP OF RAMP ELEVATION
BR	BOTTOM OF RAMP ELEVATION


LEGEND

SYMBOL	DESCRIPTION
—	PROPERTY LINE
—	LIMIT OF WORK LINE
—	WETLAND BUFFER

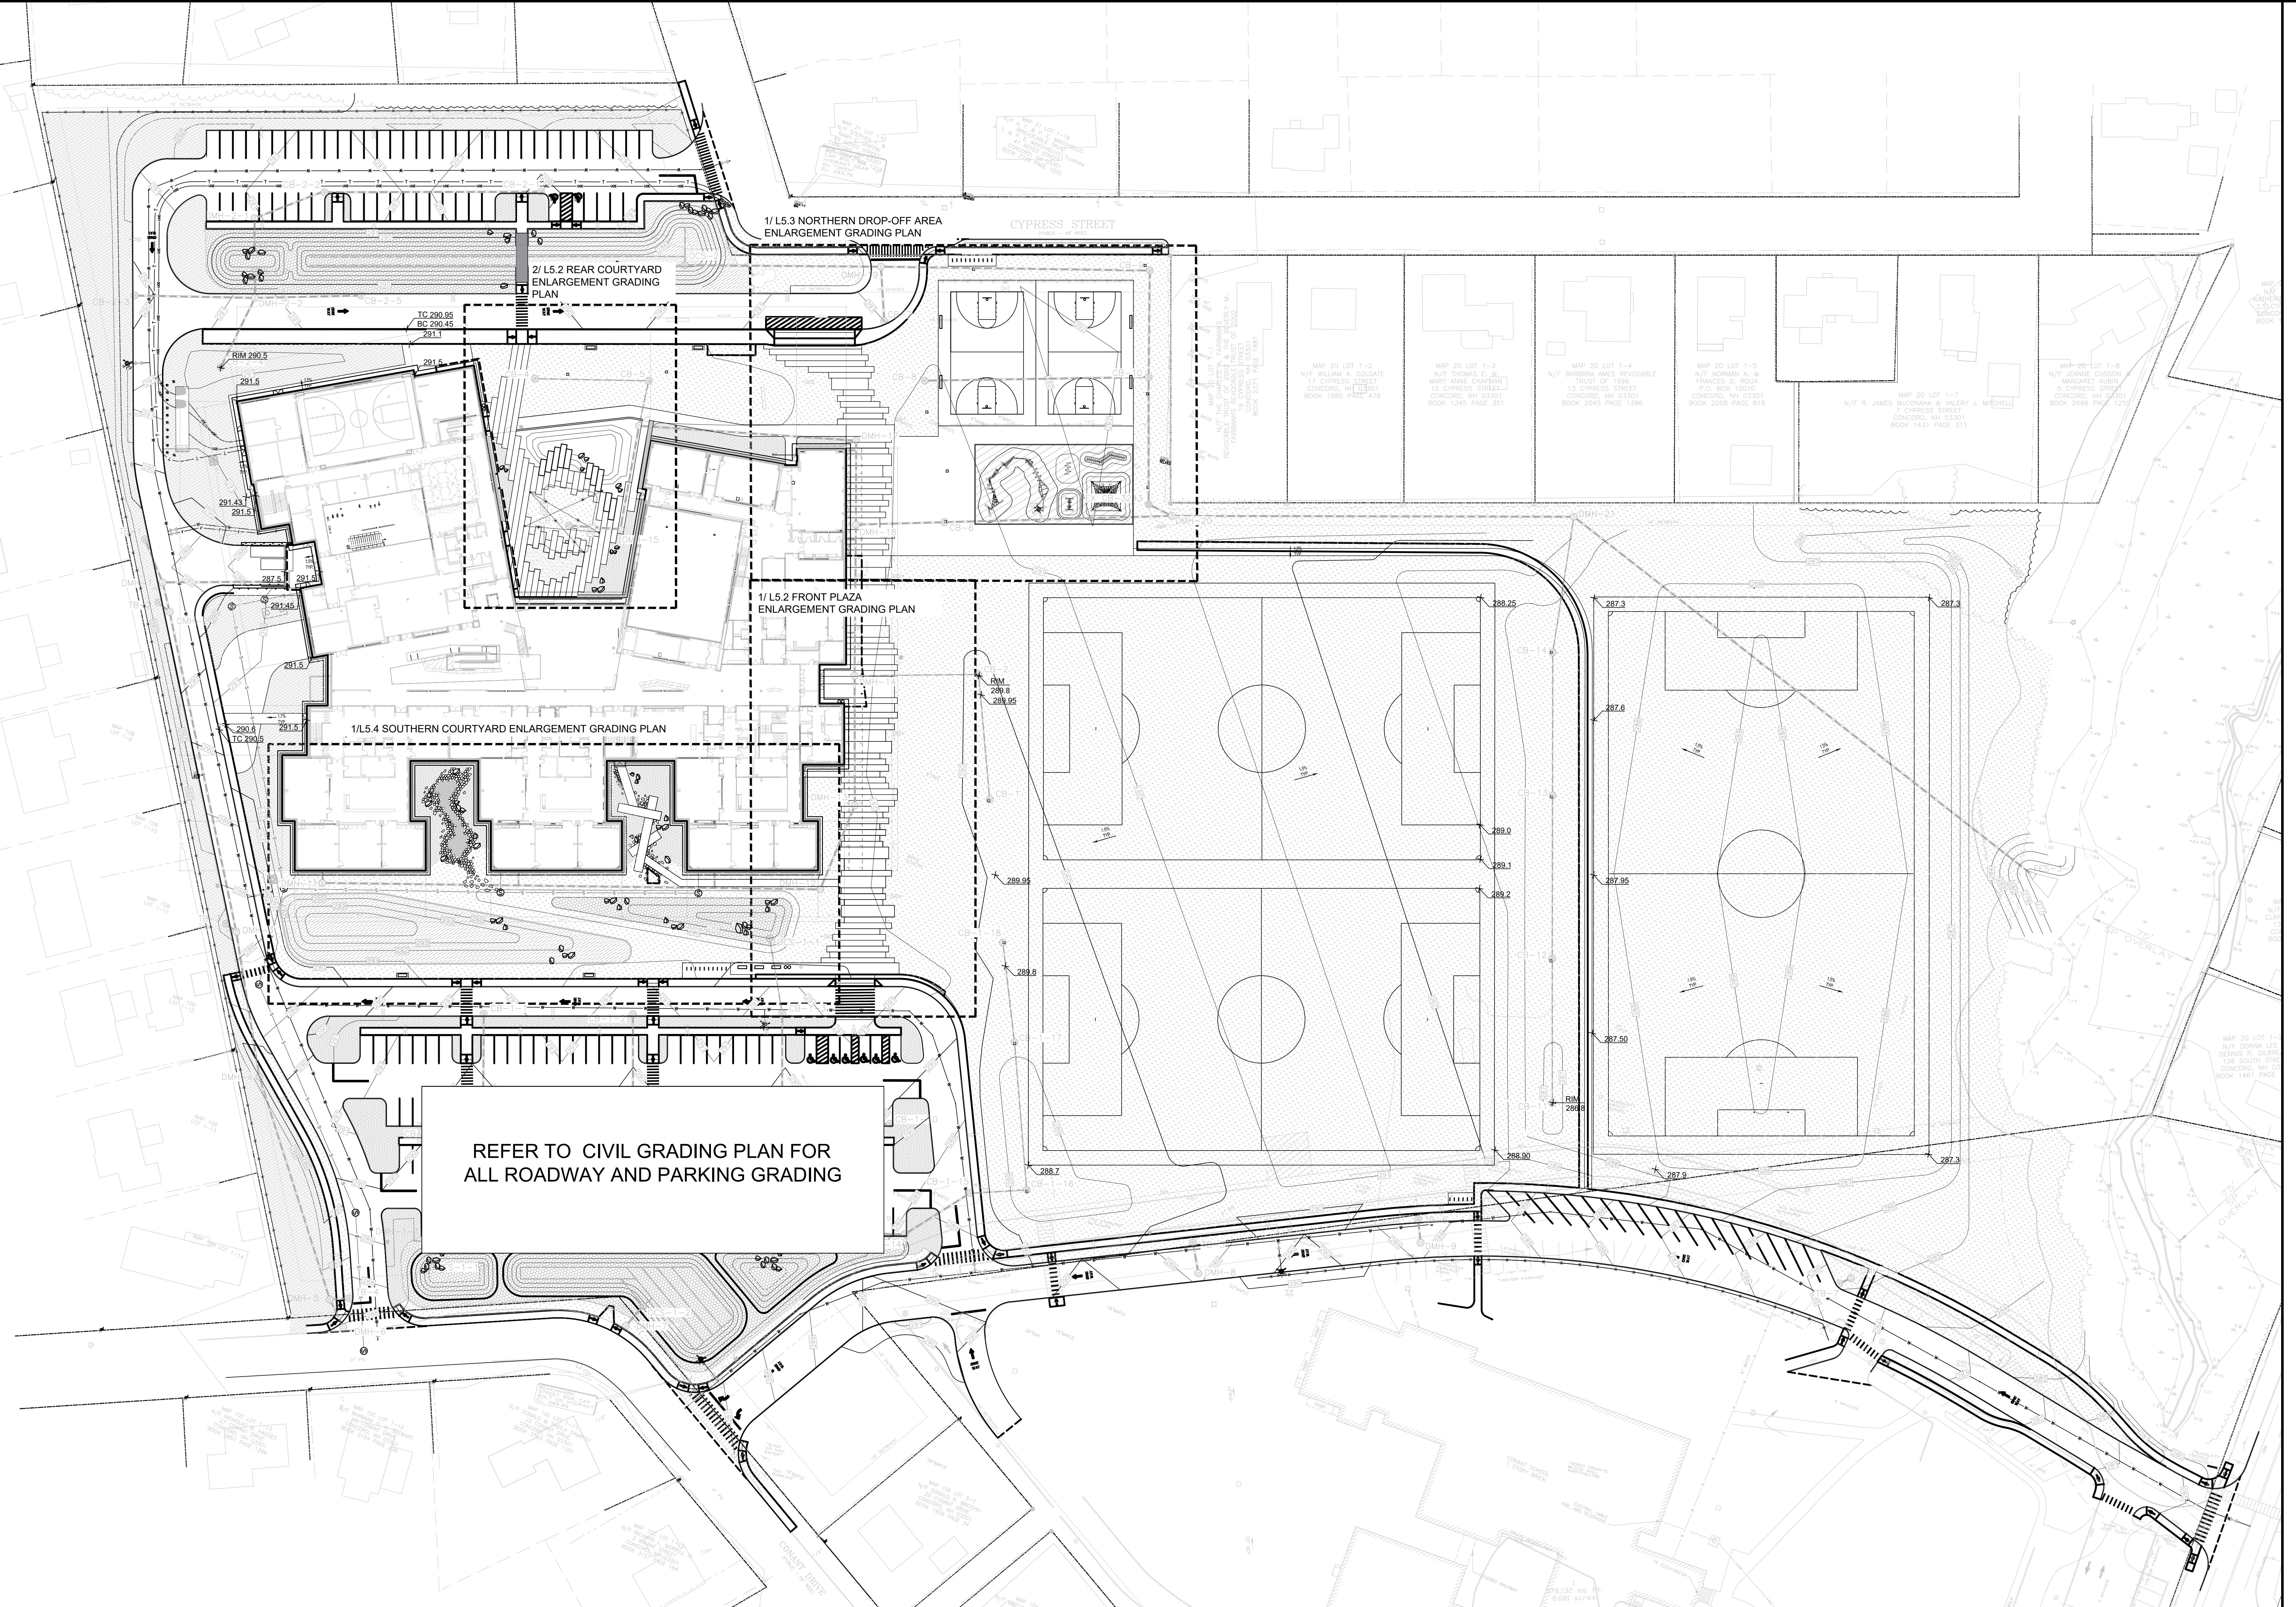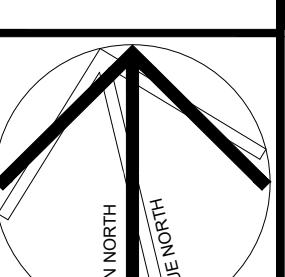GRADING NOTES:

1. USE ONE SINGLE BENCHMARK FOR WORK.
2. GRADE EVENLY BETWEEN SPOT GRADES AS NOTED.
3. THE CONTRACTOR SHALL VERIFY EXISTING UTILITY LOCATIONS PRIOR TO EXCAVATION OF ANY TYPE, INCLUDING TREES.
4. EXCAVATE BY HAND IN CLOSE PROXIMITY TO EXISTING UTILITIES, STRUCTURES AND ITEMS TO REMAIN.
5. RIM ELEVATIONS OF ANY NEW OR EXISTING DRAINAGE AND UTILITY STRUCTURES SHALL BE FLUSH WITH FINAL SURROUNDING GRADES SO NOT TO CAUSE A TRIP EDGE.
6. FINAL SHAPING OF EARTHWORK SHALL BE APPROVED IN THE FIELD BY THE LANDSCAPE ARCHITECT AND OWNER LANDSCAPE ARCHITECT TO REVIEW AND APPROVE ROUGH GRADING BEFORE THE CONTRACTOR COMMENCES FINE GRADING AND LAYING OF TOPSOIL.
7. PITCH PAVEMENT TO PROVIDE POSITIVE DRAINAGE.
8. PAVEMENT CROSS PITCH SHALL NOT BE GREATER THAN 1.9% OR LESS THAN 0.50%.
9. ALL CONTOURS ARE FOR REFERENCE ONLY. REFER TO CIVIL DRAWING FOR SITE GRADING.
10. MAINTAIN EXISTING GRADE WITHIN CRITICAL ROOT ZONE OF THE EXISTING TREE TO REMAIN.

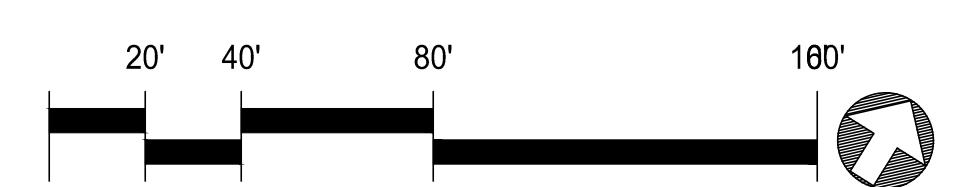

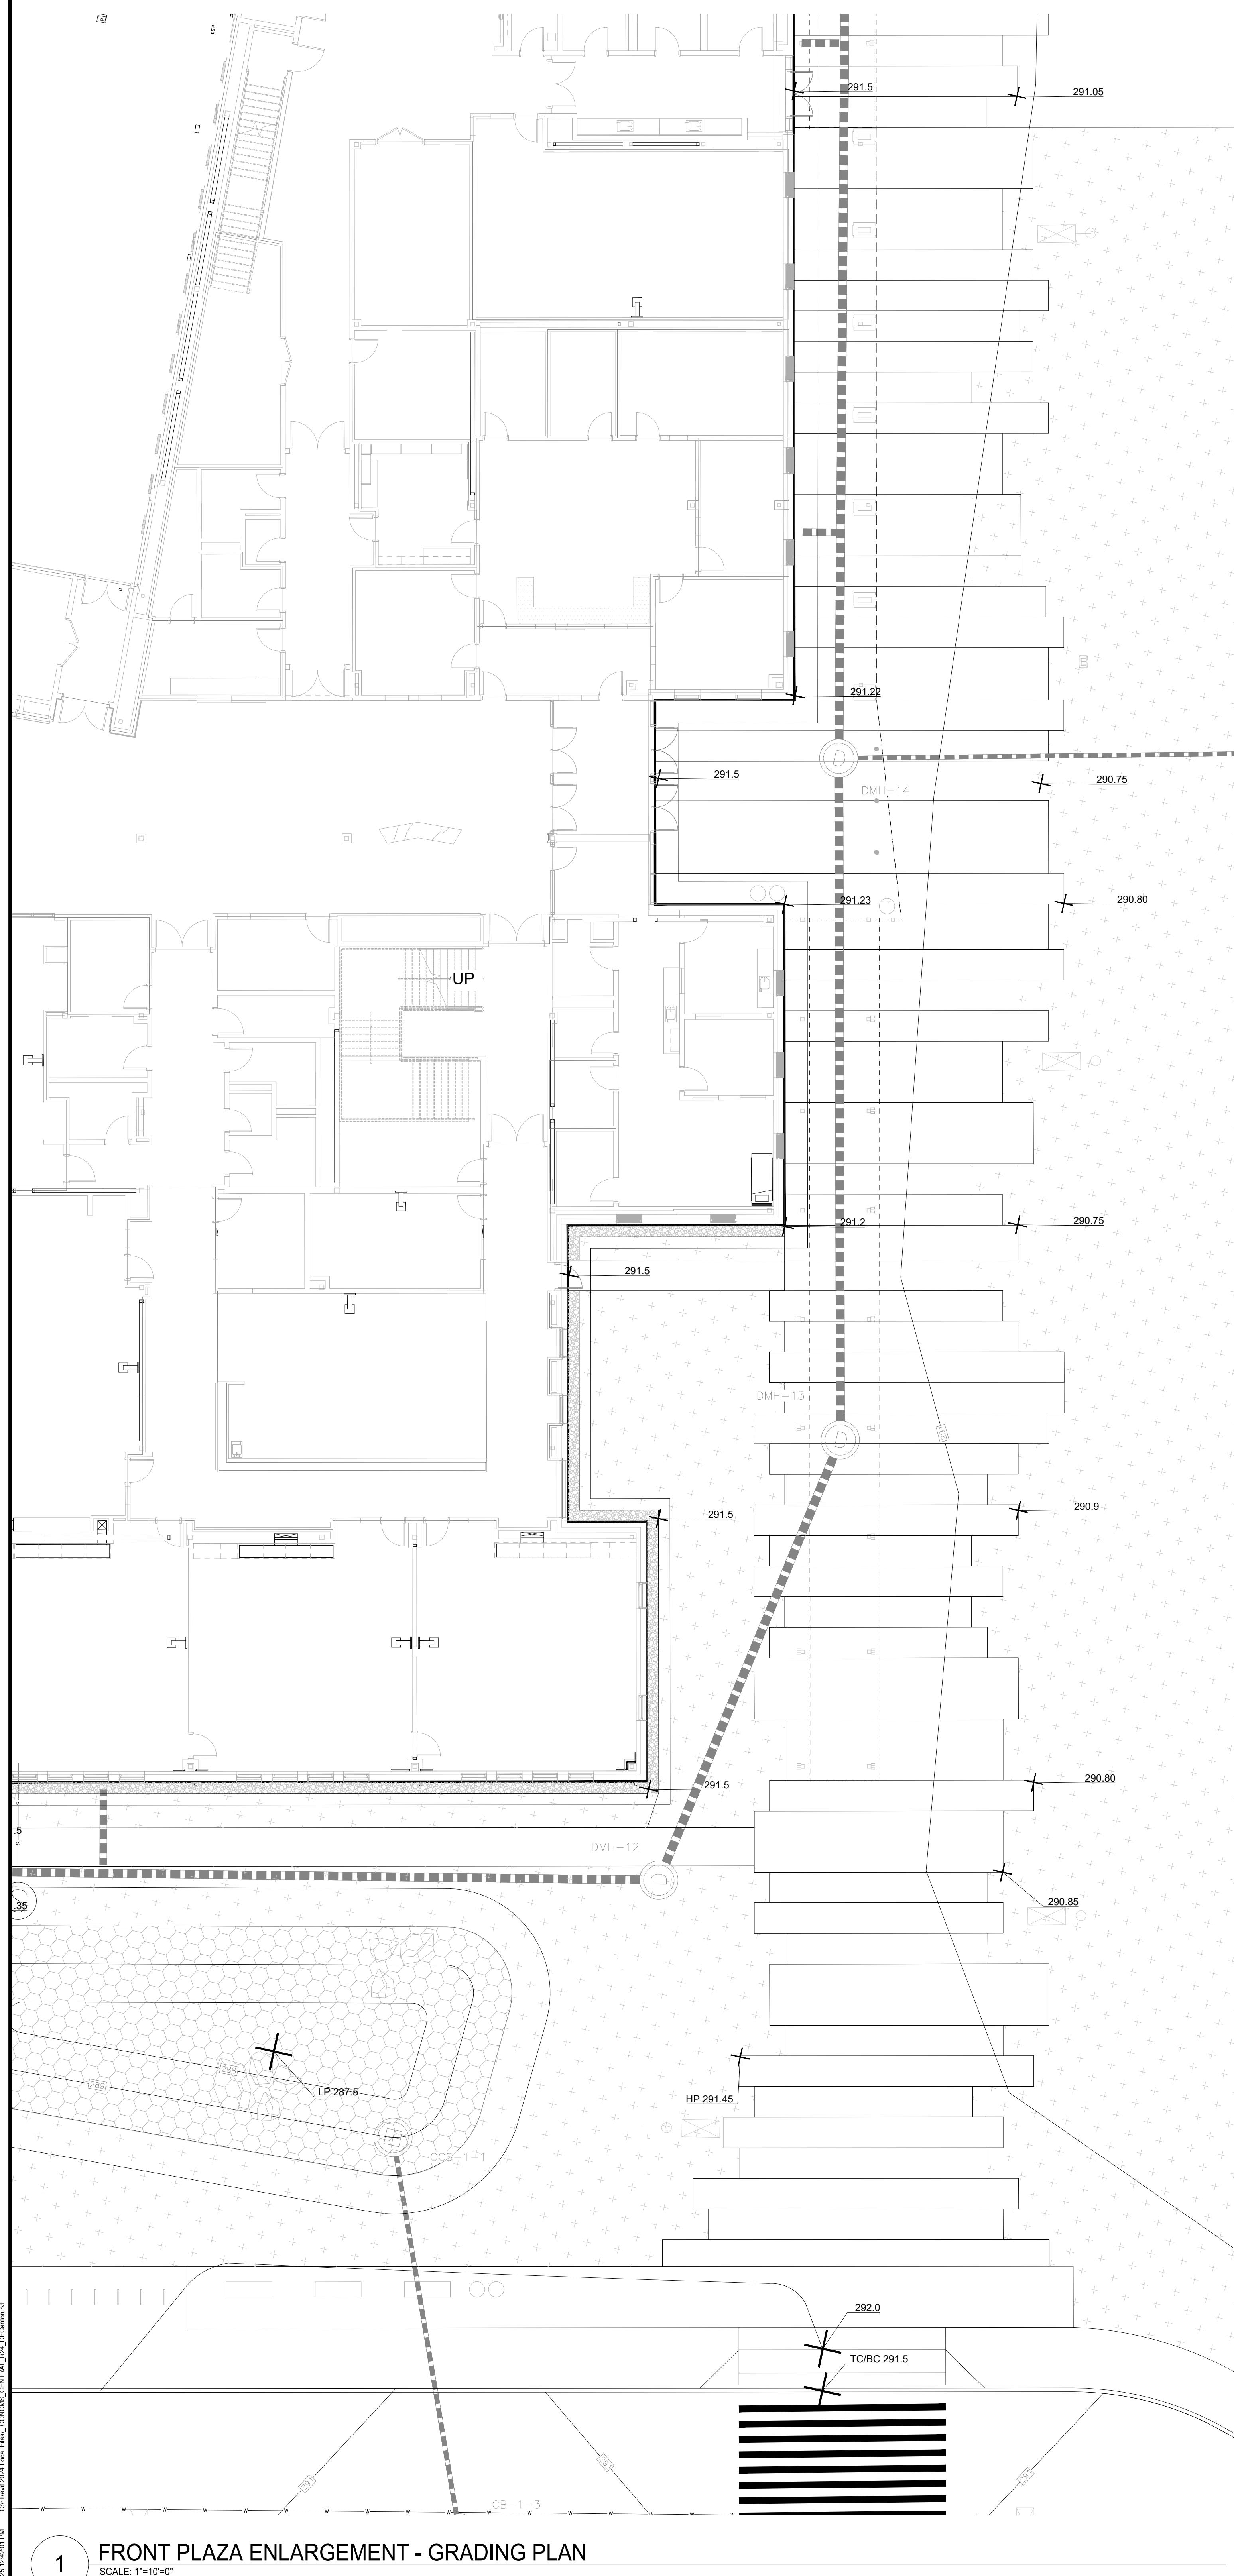

2 REAR COURTYARD ENLARGEMENT - GRADING PLAN

SCALE: 1"=10'0"

GRADING LEGEND

SYMBOL	DESCRIPTION
	EXISTING CONTOUR
— 15 —	PROPOSED CONTOUR
(XX.XX)	EXISTING SPOT ELEVATION
+	PROPOSED SPOT ELEVATION
RIM	TOP OF DRAINAGE INLET
HP	HIGH POINT
EX	EXISTING GRADE TO REMAIN
FFE	FINISH FLOOR ELEVATION
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BW	BOTTOM OF WALL ELEVATION


LEGEND

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	PROPERTY LINE
	LIMIT OF WORK LINE
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KEYPLAN



Civil Permitting Drawings 12/17/2025 (Not For Construction)


A compass rose diagram. It features a circle with a vertical line through the center. The vertical line is labeled 'PLAN NORTH' at its bottom. A diagonal line extends from the center to the top-right, labeled 'TRUE NORTH' at its top. The circle is divided into four quadrants by lines extending from the center to the circumference. The top-right quadrant is shaded black.

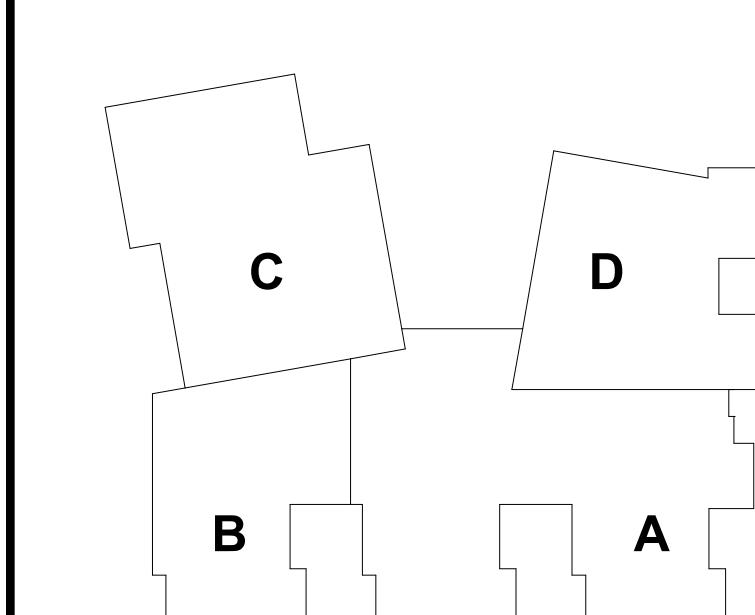ICORD MIDDLE SCHOOL ORD, NEW HAMPSHIRE ONT PLAZA

		BY
DRAWING NUMBER		
L		
5.2		
		JOB NUMBER
		468

CYPRESS STREET

(PUBLIC - 40' WIDE)

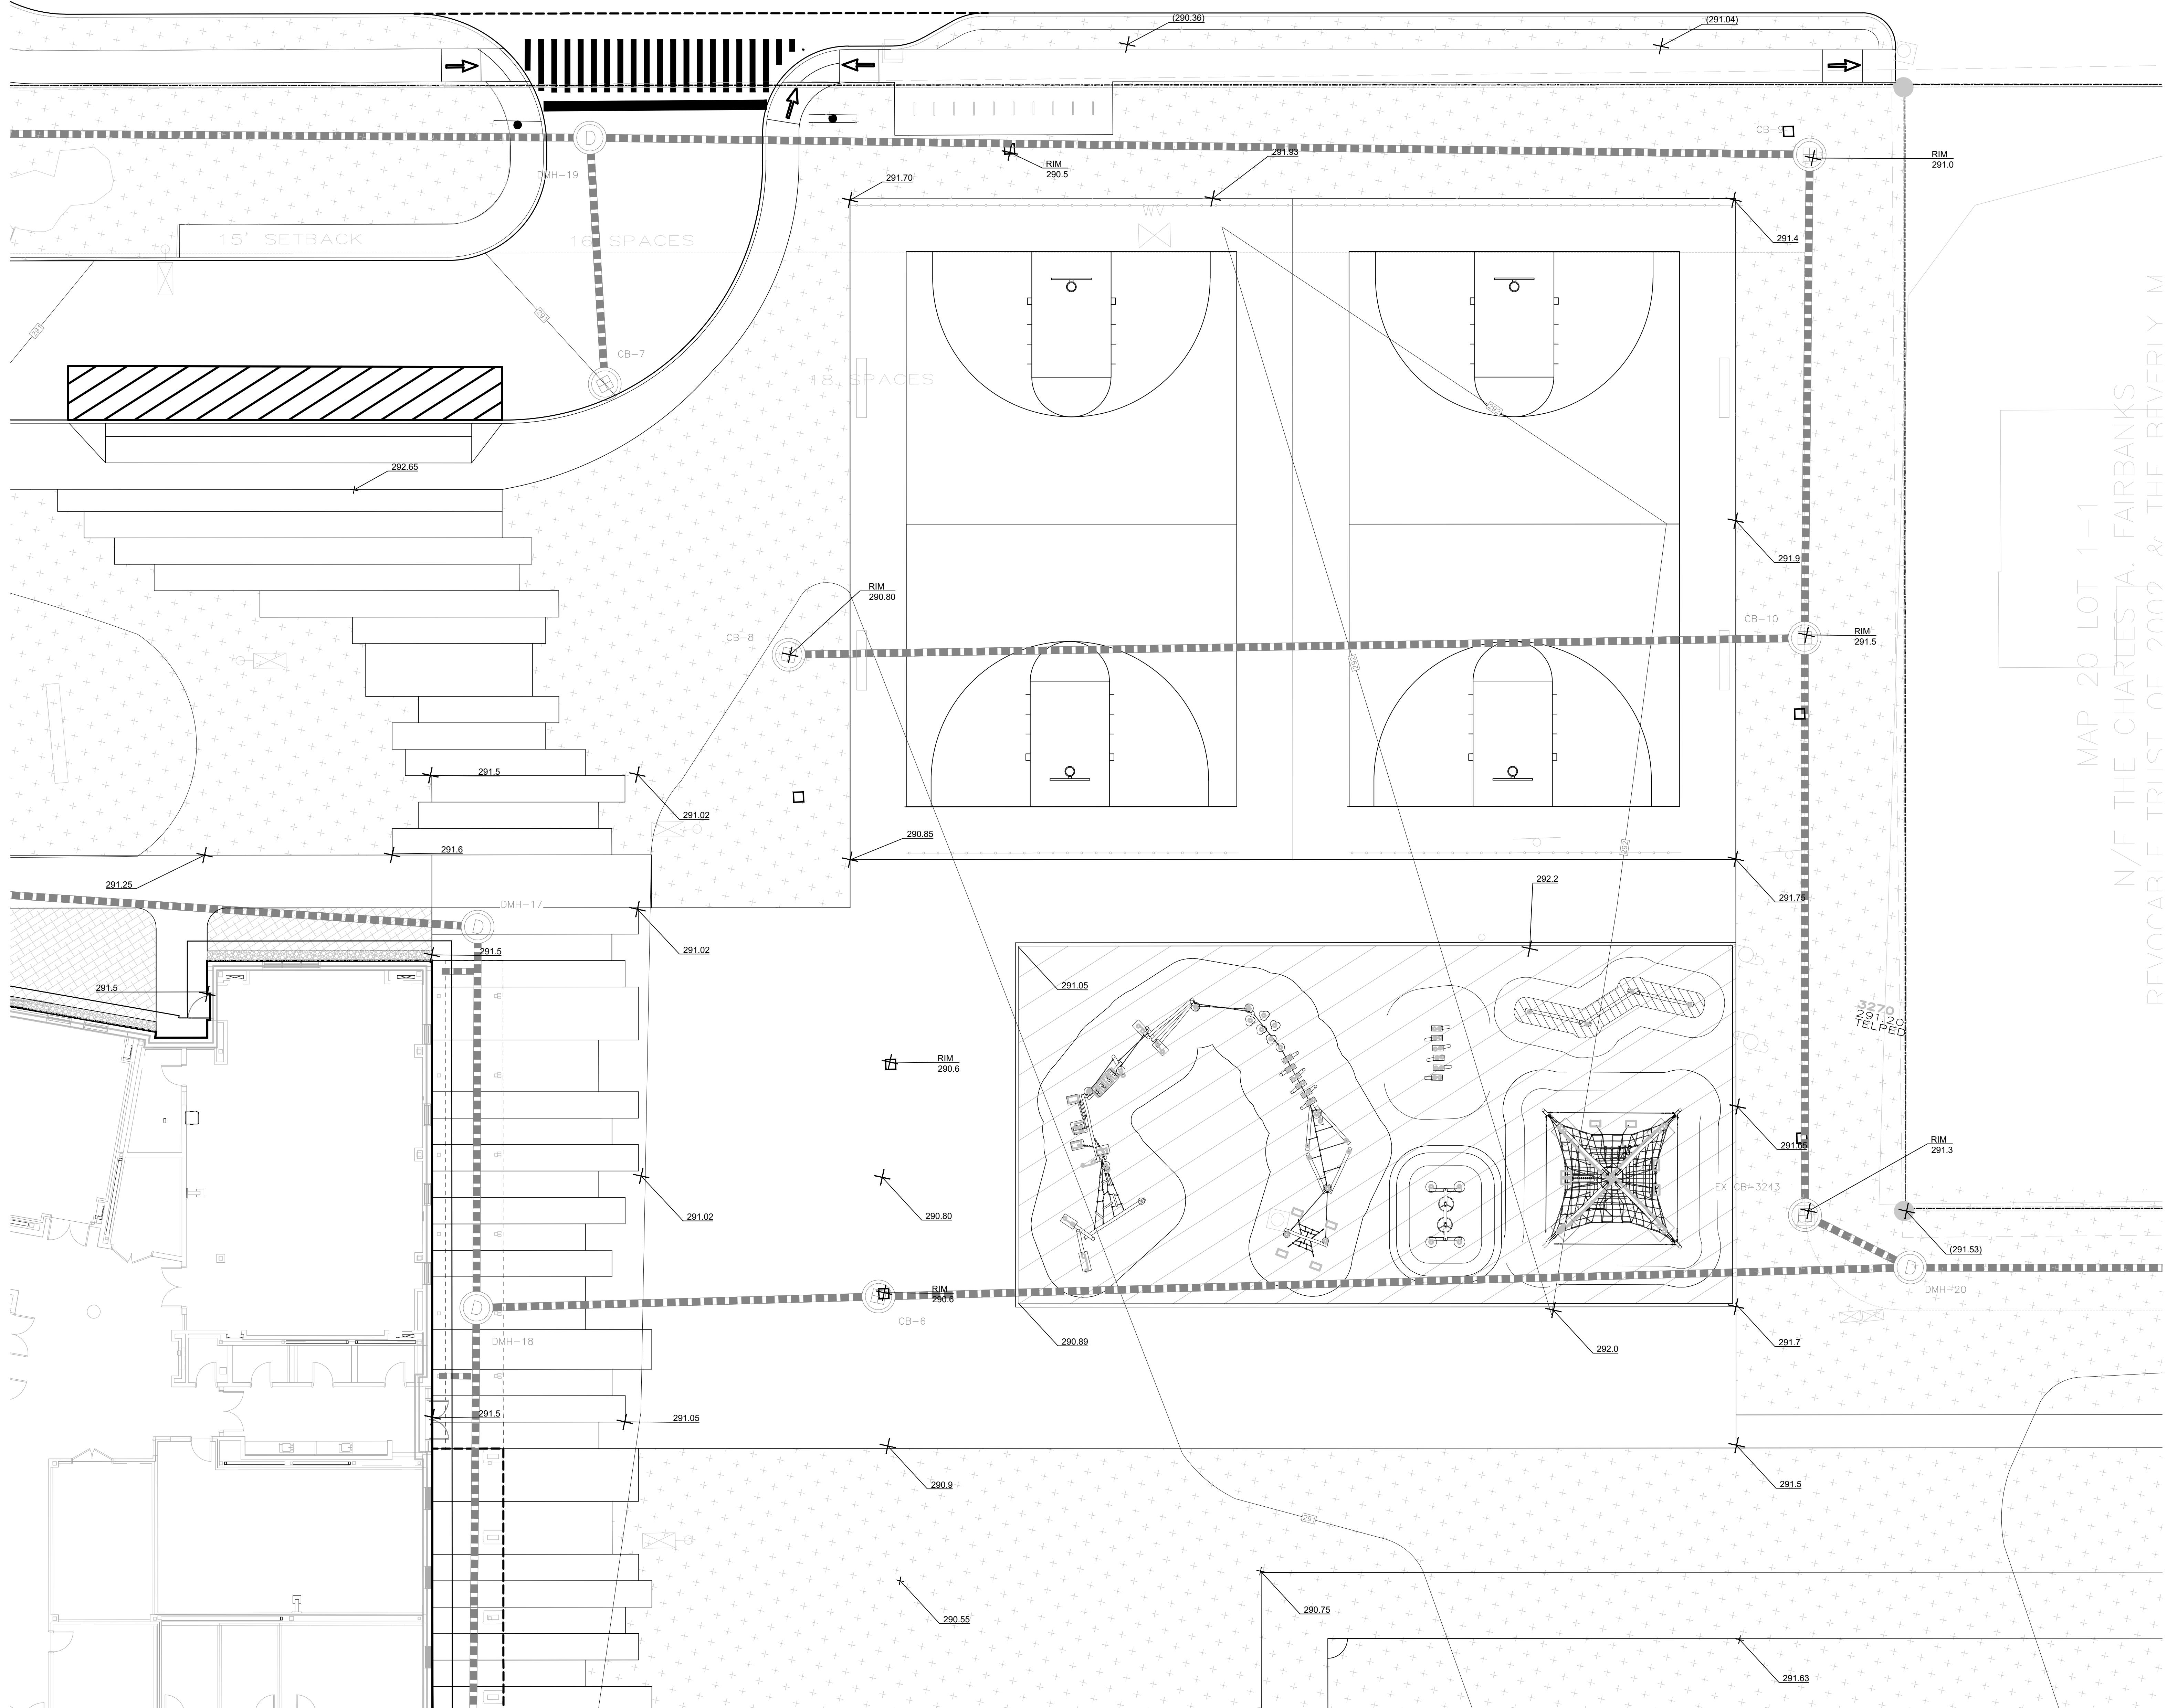

GRADING LEGEND


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LEGEND


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—	LIMIT OF WORK LINE
—	WETLAND BUFFER

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Civil Permitting Drawings
12/17/2025 (Not For Construction)



Halvorson
Engineering Studio

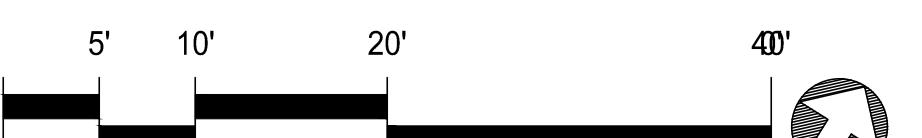12/17/2025
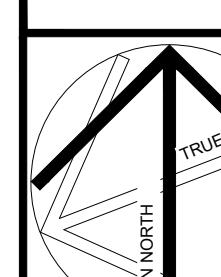
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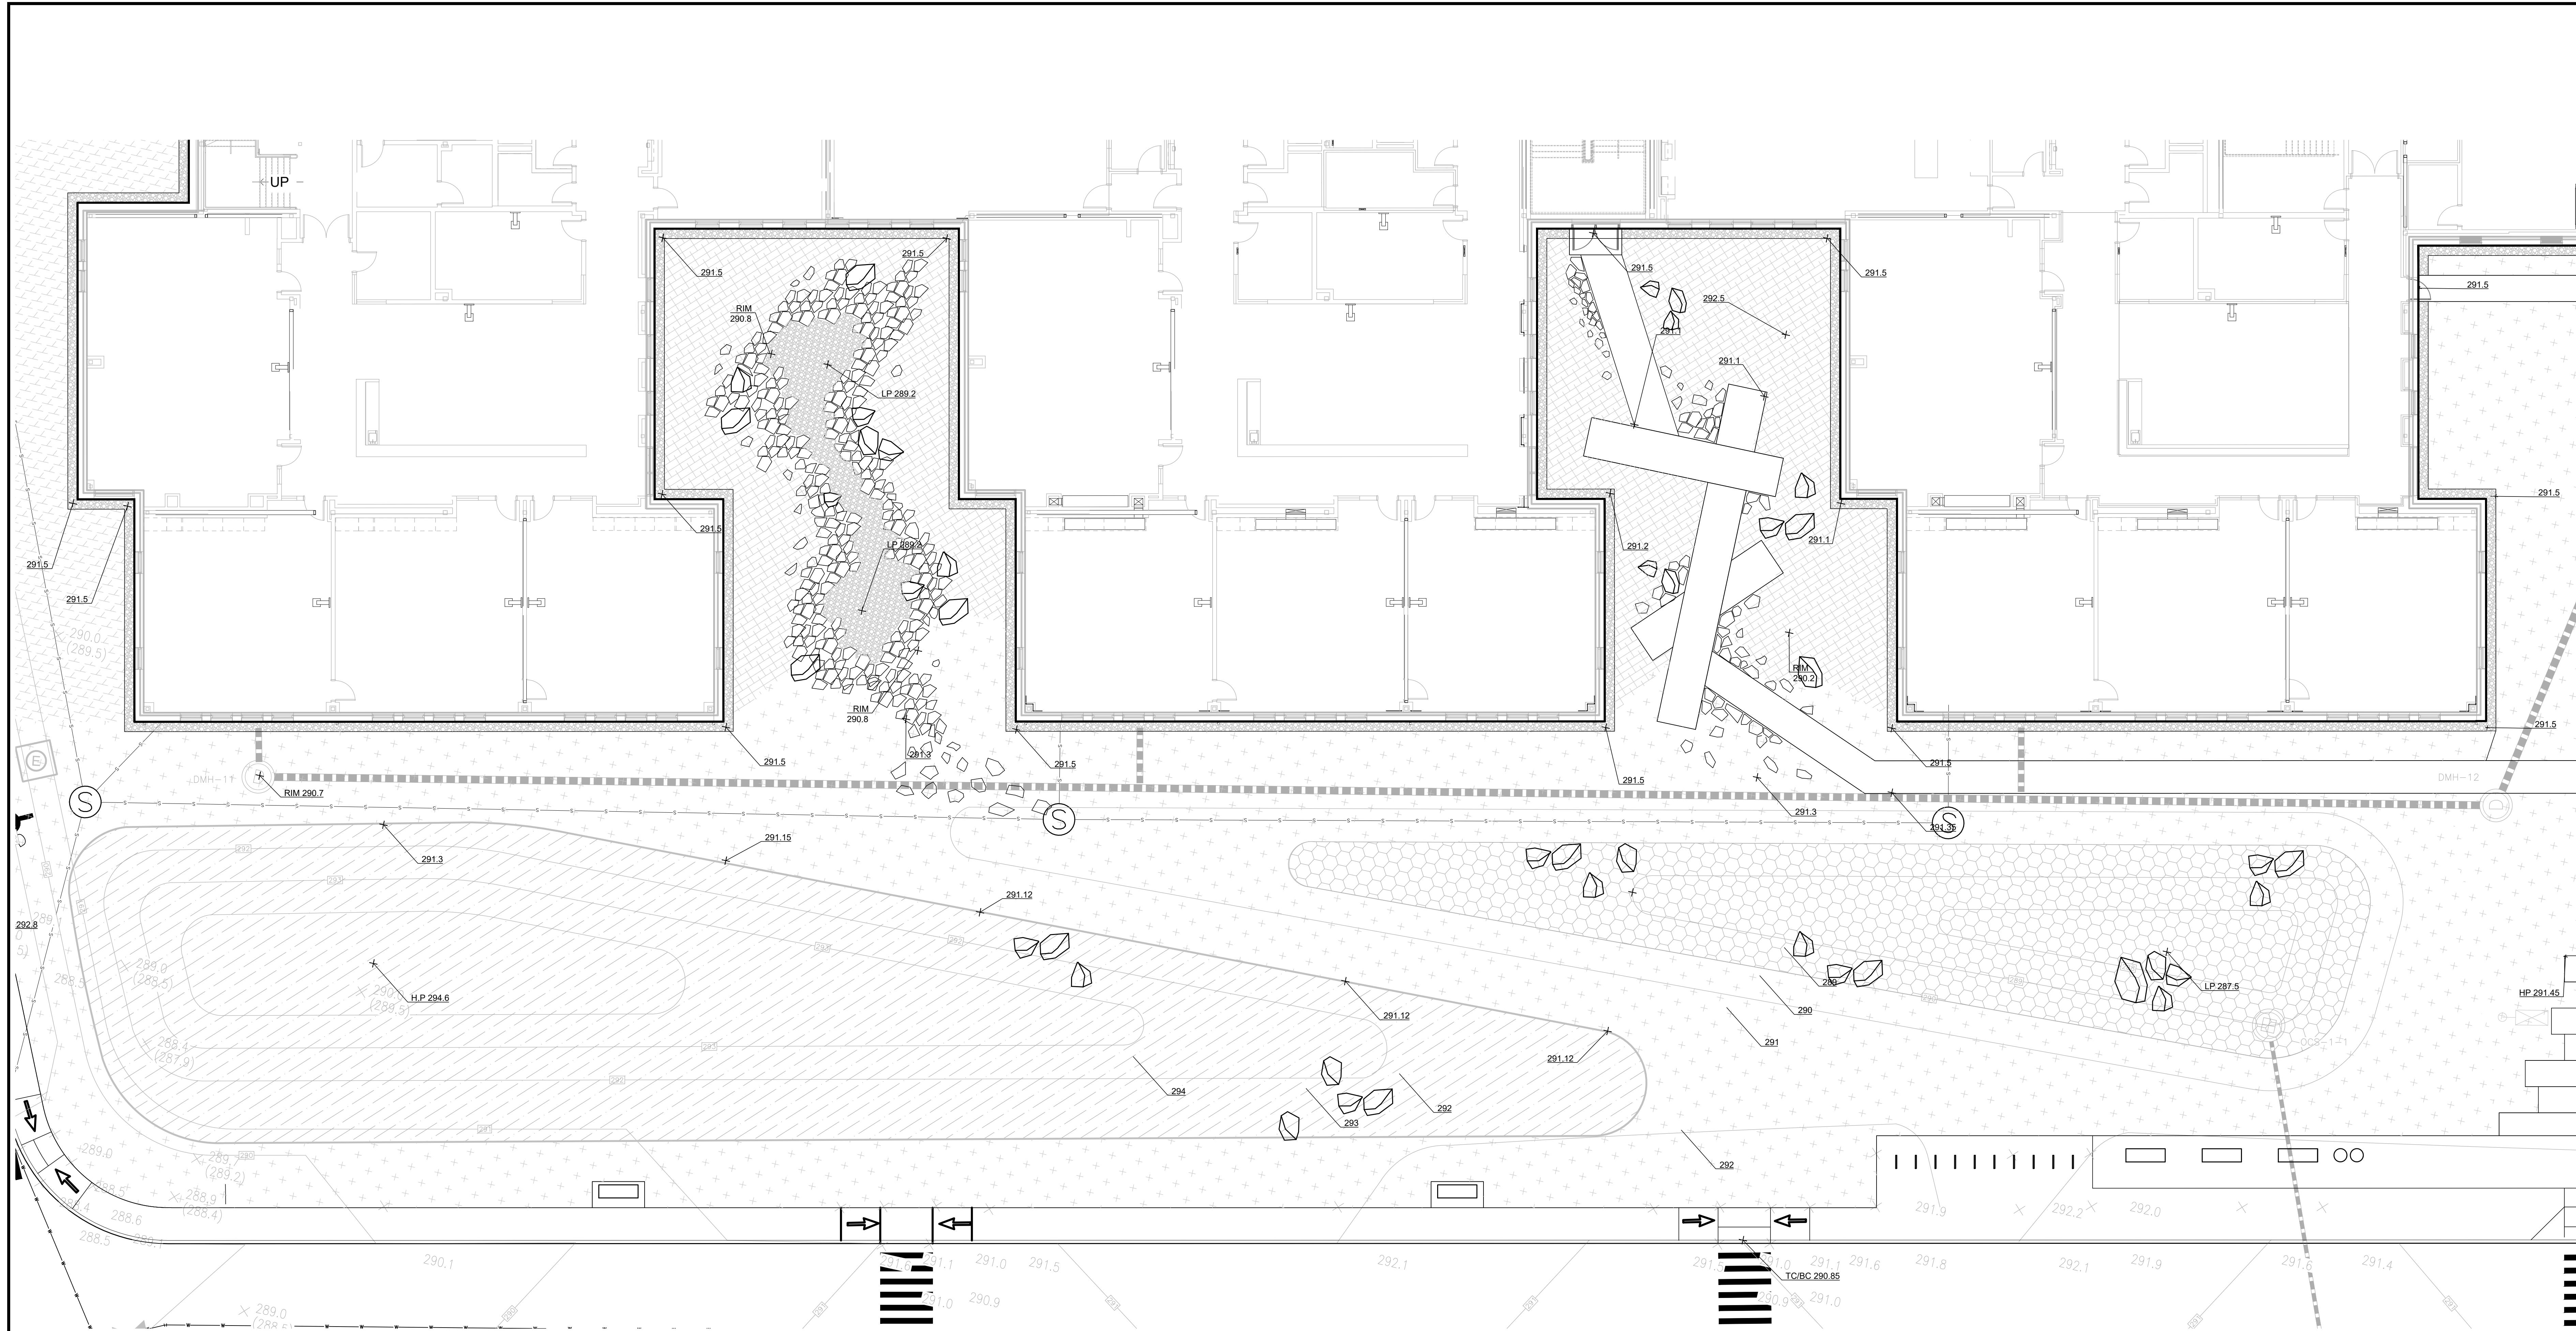
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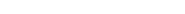
1 SOUTHERN COURTYARD ENLARGEMENT - GRADING PLAN

1

GRADING LEGEND

SYMBOL	DESCRIPTION	
	EXISTING CONTOUR	T
—15—	PROPOSED CONTOUR	B
(XX.XX)	EXISTING SPOT ELEVATION	T
+	PROPOSED SPOT ELEVATION	B
RIM	TOP OF DRAINAGE INLET	T
HP	HIGH POINT	B
EX	EXISTING GRADE TO REMAIN	
FFE	FINISH FLOOR ELEVATION	
TW	TOP OF WALL ELEVATION	
BW	BOTTOM OF WALL ELEVATION	


LEGEND

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	PROPERTY LINE
	LIMIT OF WORK LINE
	WETLAND BUFFER

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KEYPLAN



Civil Permitting Drawings

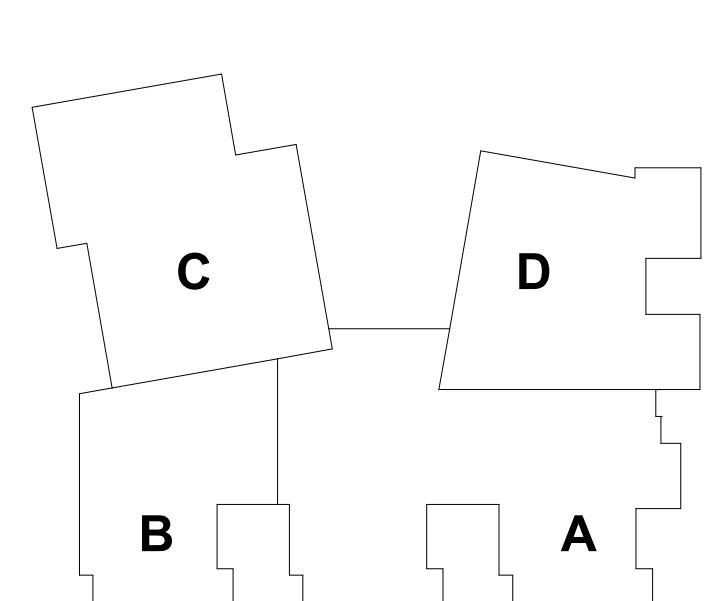
12/17/2025 (Not For Construction)

CONCORD MIDDLE SCHOOL

CONCORD, NEW HAMPSHIRE

FRONT COURTYARD

BY
DRAWING NUMBER
L
5.4
JOB NUMBER
46

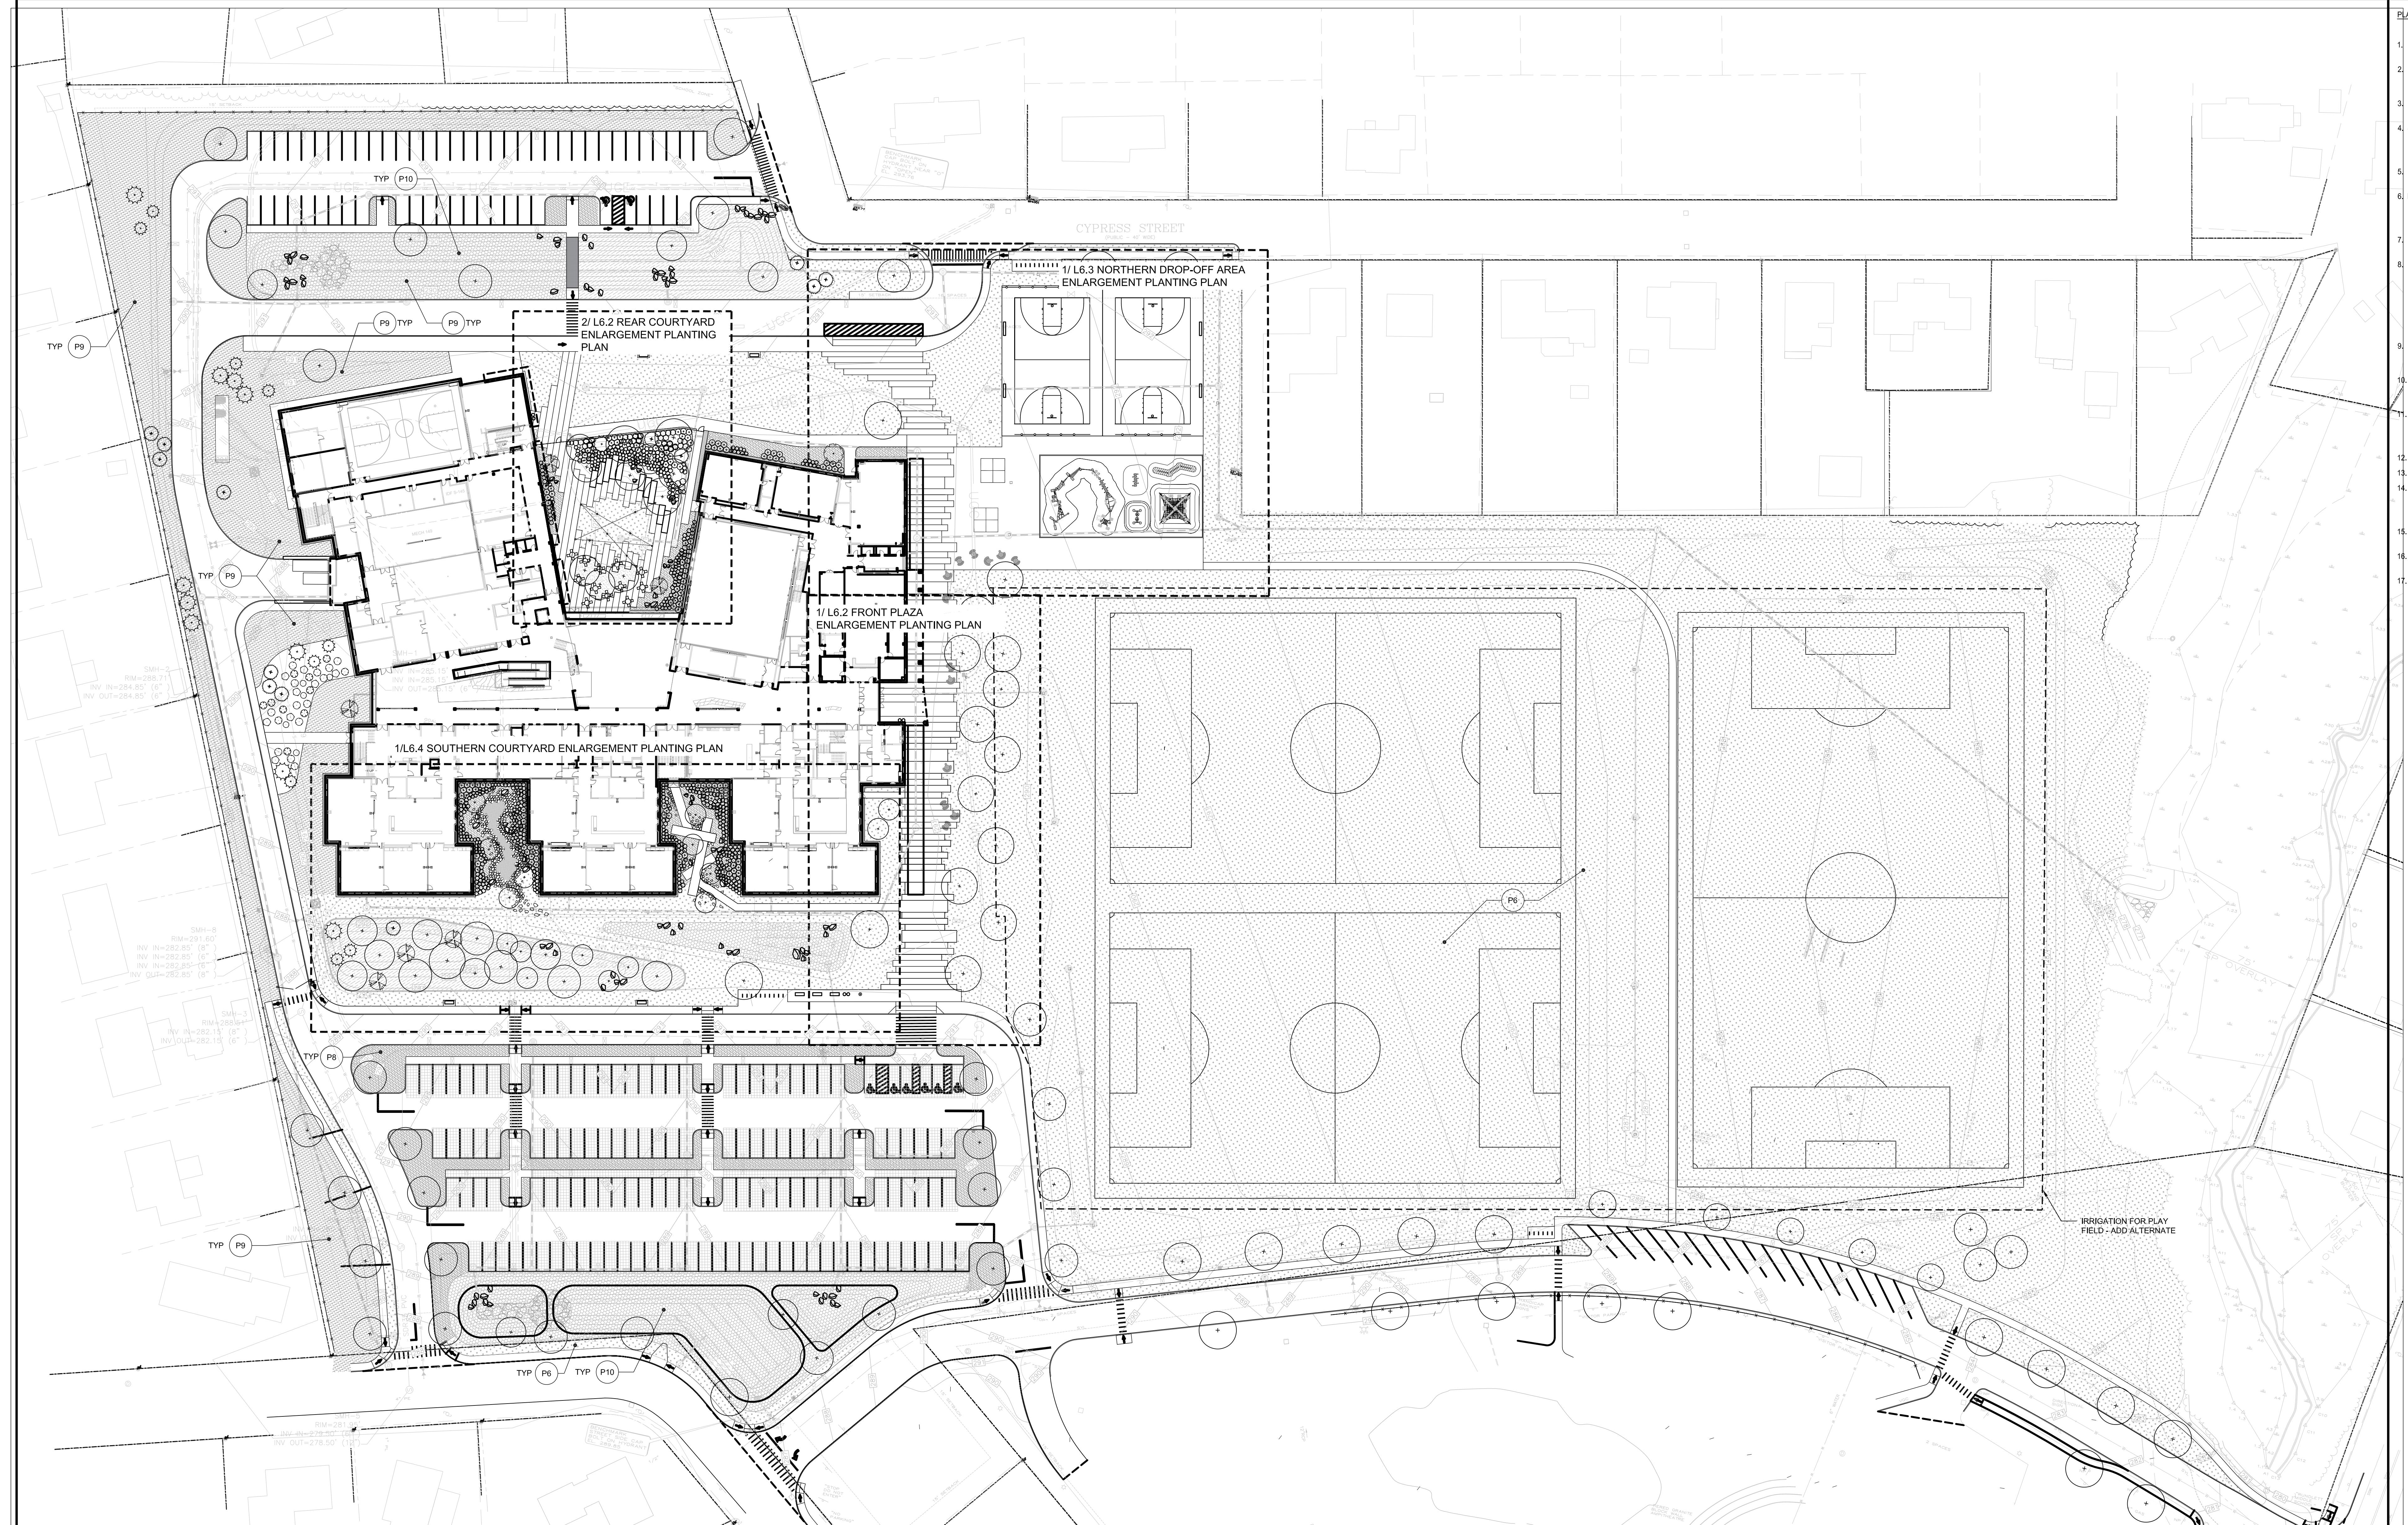


PLANTING NOTES

1. LANDSCAPE ARCHITECT TO APPROVE PLANT MATERIAL AT THE NURSERY OR AS SHIPPED IN SITE PRIOR TO PLANTING.
2. PLANT MATERIALS SHALL CONFORM TO THE AMERICAN STANDARD FOR NURSERY STOCK, PUBLISHED BY AMERICANHORT (WWW.AMERICANHORT.ORG).
3. NO SUBSTITUTIONS OF PLANT SPECIES WITHOUT LANDSCAPE ARCHITECT'S WRITTEN APPROVAL.
4. SUBSTITUTIONS OF PLANT SPECIES SHALL BE A PLANT OF EQUIVALENT SIZE, SHAPE, COLOR, BRANCHING HABIT, FLOWER, LEAF AND FRUIT, COLOR AND TIME OF BLOOM, AS APPROVED BY LANDSCAPE ARCHITECT.
5. LOCATE AND VERIFY UTILITY LINE LOCATIONS PRIOR TO STAKING AND REPORT CONFLICT TO LANDSCAPE ARCHITECT.
6. PLANTING DLOCATION OF BINS, GARBAGE, LUMPS OF CONCRETE, STEEL OTHER MATERIALS BELONGING TO THE OWNER OF THE PROPERTY AS DETERMINED BY LANDSCAPE ARCHITECT SHALL BE REMOVED FROM ALL PLANTING AREAS.
7. NO PLANTING TO BE INSTALLED BEFORE ACCEPTANCE OF ROUGH TRADES.
8. ALL PROPOSED TREE LOCATIONS SHALL BE STANDED OR LAD OUT IN THEIR APPROXIMATE LOCATION BY THE CONTRACTOR. REFER TO LAYOUT AND PLANTING SHEETS FOR LAYOUT INFORMATION. THE CONTRACTOR SHALL NOTIFY THE LANDSCAPE ARCHITECT AND THE LANDSCAPE ARCHITECT TO ACCOUNT FOR SUBSURFACE UTILITIES AND OTHER FIELD CONDITIONS. FINAL LOCATIONS OF ALL PLANTS MUST BE APPROVED BY THE LANDSCAPE ARCHITECT PRIOR TO PLANTING.
9. TOTAL QUANTITY OF PLANTS FOR EACH AREA TO BE AVAILABLE ON SITE AT THE TIME OF PLANTING FOR FIELD LAYOUT BY ENGINEER, NO PARTIAL LAYOUT AND PLANTING OF AREAS WILL BE ACCEPTABLE.
10. INSTALL PLANTS WITH ROOT FLARES FLUSH WITH FINISHED GRADE. PLANTS SHALL NOT SINK OR SAG. PLANTS THAT SETTLE OUT OF PLUMB OR BELOW FINISHED GRADE.
11. PLANT UNDER FULL TIME SUPERVISION OF CERTIFIED ARBORIST, NURSERYMAN, OR LICENSED LANDSCAPE ARCHITECT. PROVIDE WRITTEN CERTIFICATE OF PLANTING AND CONSTRUCTION LICENSE FOR LANDSCAPE ARCHITECT'S APPROVAL.
12. LOOSE OR CRACKED ROOT BALLS ARE UNACCEPTABLE.
13. DO NOT USE TREE WRAPS.
14. REMOVE TOP 2/3 OF WIRE BASKETS, REMOVE TOP 1/3 OF BURLAP. SYNTHETIC BURLAP WILL NOT BE ACCEPTED. FOR CONTAINER PLANTS, REMOVE CONTAINER AND SCRAPPY EDGES OF ROOT BALL 1/2" DEEP IN A MINIMUM OF FOUR LOCATIONS.
15. PLANTING AND PLANT SETTLEMENTS SHALL SETTLE WITHIN 24 HOURS.
16. RAISE AND REPLANT PLANTS THAT SETTLE. AFTER PLANTING AND WATERING.
17. ALL TREES PLANTED IN TREE PITS AND STRUCTURAL SOIL SHALL BE UNDERDRAINED. SEE PLANTING DETAILS AND CIVIL DRAWINGS.

HALVORSON
Tigard Studio
25445 HUNTER ST. #200, CEDAR RAPIDS, IA 50614
515.242.2500 | 515.242.2501 | 515.242.2502 | 515.242.2503

Civil Permitting Drawings
12/17/2025 (Not For Construction)

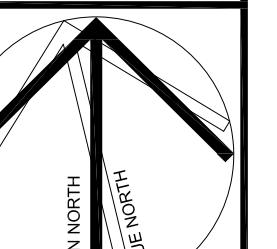

PLANTING MATERIALS LEGEND

SYM.	DET.	DESCRIPTION
P1		EXISTING TREE TO REMAIN
P2	1 17.0	DECIDUOUS TREE
P3	1 17.0	EVERGREEN TREE
P4	1 17.0	ORNAMENTAL TREE
P5	2 17.0	TREE IN PERMEABLE RESIN BOUND AGGREGATE SURFACING
P6		SOD LAWN
P7	5 17.0	SPORT FIELD LAWN - SOD
P8	6 17.0	SHRUB AND GROUND COVER PLANTING
P9	7/4 17.0	NO MOW SEED MIX
P10		BIORETENTION SEED MIX
P11		UPLAND SEED MIX
		LIMIT OF SAND BASED STRUCTURAL SOIL

PLANT SCHEDULE

CODE	QTY	BOTANICAL NAME	COMMON NAME	SIZE	REMARKS
TREES					
AB BA L	11	<i>Abies balsamea</i>	Balsam Fir	12'-14' Ht.	
AB BA	9	<i>Abies balsamea</i>	Balsam Fir	8'-10' B&B	
AC RU S	11	<i>Acer rubrum 'October Glory'</i>	October Glory Red Maple	1" Cal.	
AC RU S2	5	<i>Acer rubrum 'October Glory'</i>	October Glory Red Maple	1/2" cal.	
AC RU	16	<i>Acer rubrum 'October Glory'</i>	October Glory Red Maple	3"-3.5" cal., B&B	Single stem, matched specimen, first branch to 7 ft
AC SA	2	<i>Acer saccharum</i>	Sugar Maple	3"-3.5" cal., B&B	Single stem, matched specimen
AC SA S	9	<i>Acer saccharum 'Legacy'</i>	Legacy Sugar Maple	1" Cal.	
AC SA L	3	<i>Acer saccharum 'Legacy'</i>	Legacy Sugar Maple	5"-5 1/2" cal.	
AC MA	24	<i>Acer x freemanii 'Marmo'</i>	Marmo Freeman Maple	Single stem, matched specimen, first branch to 7 ft	
AC MA L	7	<i>Acer x freemanii 'Marmo'</i>	Marmo Freeman Maple	5" Cal.	
AM LA S	4	<i>Amelanchier laevis 'Cumulus'</i>	Cumulus Allegheny Serviceberry	1" Cal.	
AM LA	6	<i>Amelanchier laevis 'Cumulus'</i>	Cumulus Allegheny Serviceberry	8"-10" MULTI STEM - 3-6 STEMS	
BE PO	19	<i>Betula populifolia 'Whitespine'</i>	Whitespine Gray Birch	10"-12" ht. B&B	Single stem, matched specimen
GL TR	6	<i>Gleditsia triacanthos inermis 'Skyline'</i>	Skyline Honey Locust	3"-3.5" cal., B&B	Single stem, matched specimen, first branch to 7 ft
GL TR L	5	<i>Gleditsia triacanthos inermis 'Skyline'</i>	Skyline Honey Locust	5"-5 1/2" cal.	Single stem, matched specimen, first branch to 7 ft
HAM WCH	1	<i>Hamamelis virginiana 'Winter Champagne'</i>	Winter Champagne Witch Hazel	3"-3.5" cal., B&B	
LI ST L	3	<i>Liquidambar styraciflua</i>	Sweet Gum	5"-5 1/2" cal.	
LI TU	9	<i>Liriodendron tulipifera</i>	Tulip Poplar	3"-3.5" cal., B&B	Single stem, matched specimen, first branch to 7 ft
LI TU L	5	<i>Liriodendron tulipifera</i>	Tulip Poplar	5"-5 1/2" cal.	
NY SY	7	<i>Nyssa sylvatica</i>	Tupelo	3"-3.5" cal., B&B	Single stem, matched specimen
QU PA S	8	<i>Quercus palustris</i>	Pin Oak	1" Cal.	
QU PA	5	<i>Quercus palustris</i>	Pin Oak	3"-3.5" cal., B&B	Single stem, matched specimen, first branch to 7 ft
QU RU	7	<i>Quercus rubra</i>	Red Oak	3"-3.5" cal., B&B	Single stem, matched specimen
TH GG	13	<i>Thuja x 'Green Giant'</i>	Green Giant Arborvitae	10"-12" ht. B&B	


PLANT SCHEDULE

CODE	QTY	BOTANICAL NAME	COMMON NAME	SIZE	REMARKS
SHRUBS					
Arc abr	11	<i>Aronia arbutifolia 'Brilliantissima'</i>	Brilliant Red Chokeberry	3.5"-4" Ht.	
Cl al	130	<i>Clethra alnifolia</i>	Summersweet	30"-36" ht	
Cor fa	232	<i>Corus siericea 'Farrow'</i>	Arctic Fire® Red Twig Dogwood	30"-36" ht	
Lon rv	125	<i>Dienivilla x splendens</i>	Kodial® Orange Diervilla	24"-30" ht	
Ille mn	23	<i>Ilex glabra</i>	Inkberry Holly Male	---	
Ille sh	6	<i>Ilex glabra 'Shamrock'</i>	Shamrock Inkberry Holly	5 gal.	
Ille ve	3	<i>Ilex verticillata 'Winter Red'</i>	Winter Red Winterberry	5 gal.	
Iti ll	167	<i>Itea virginica 'Little Henry'</i>	Virginia Sweetspire	24"-36"	
Rh gl	81	<i>Rhus aromatica 'Gro-Low'</i>	Gro-Low Fragrant Sumac	3 gal.	


PLANT SCHEDULE

BOTANICAL NAME	COMMON NAME
GROUND COVERS	
<i>Allium cernuum</i>	Nodding Onion
<i>Amsonia tabernaemontana 'Blue Ice'</i>	Blue Ice Eastern Bluestar
<i>Carex appalachica</i>	Appalachian Sedge
<i>Carex eburnea</i>	Bristleleaf Sedge
<i>Carex laxiculmis 'Hob'</i>	Bunny Blue Spreading Sedge
<i>Carex rosea</i>	Rosy Sedge
<i>Deschampsia flexuosa</i>	Crinkled Hair Grass
<i>Echinacea purpurea</i>	Coreflower
<i>Liatris spicata</i>	Blazing Star
<i>Panicum virgatum 'Cheyenne Sky'</i>	Cheyenne Sky Prairie Winds® Switch Grass
<i>Phlox divaricata</i>	Woodland Phlox
<i>Polygonum aciculoides</i>	Christmas Fern
<i>Sporobolus heterolepis</i>	Prairie Dropseed

KEYPLAN

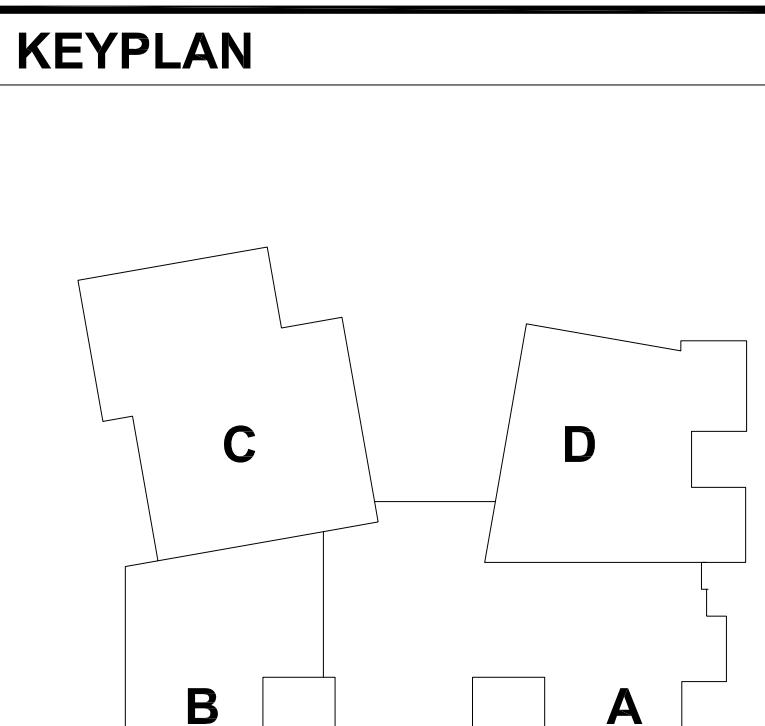


REVISIONS NO.	DATE	REMARKS
		DRAWN BY: LB
		CHECKED BY: LB
		SCALE: 1"=40'-0"
		CONCORD NEW HAMPSHIRE OVERALL PLANTING PLAN
		CONCORD MIDDLE SCHOOL
		BY: HMFH ARCHITECTS
		DRAWN BY: LB
		SCALE: 1"=40'-0"
		L 6.1
		JOB NUMBER: 466723

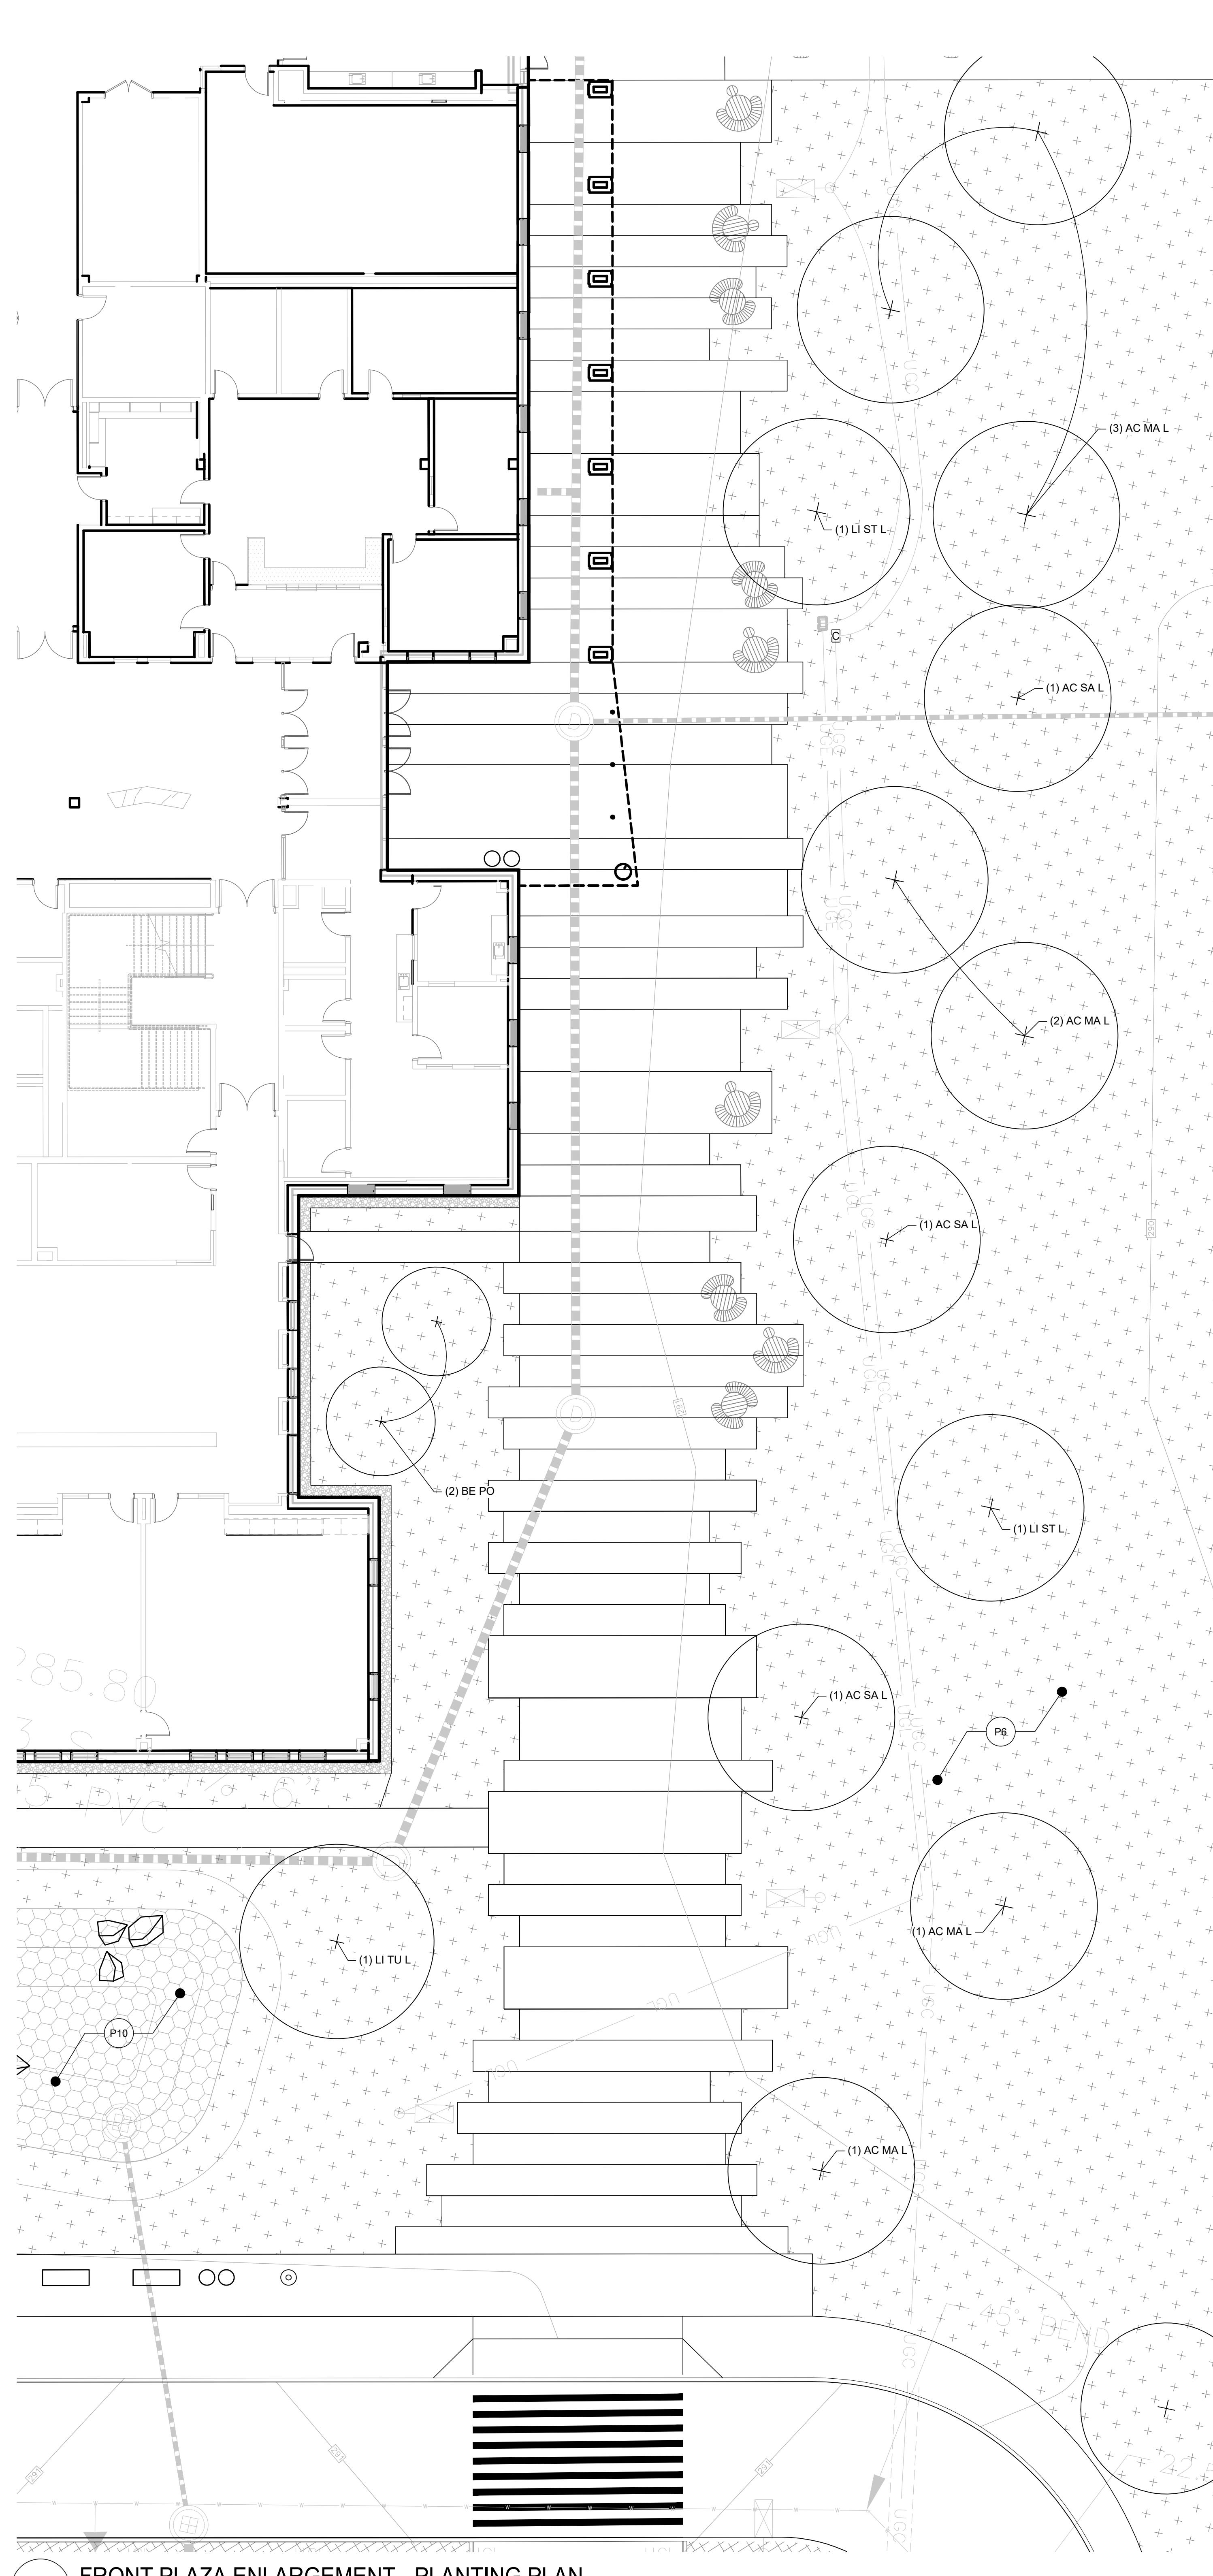


PLANTING MATERIALS LEGEND


PLANTING MATERIALS LEGEND			
SYM.	DET.	DESCRIPTION	
•	P1		EXISTING TREE TO REMAIN
+	P2	1 L7.6	DECIDUOUS TREE
	P3	1 L7.6	EVERGREEN TREE
	P4	1 L7.6	ORNAMENTAL TREE
+	P5	2 L7.6	TREE IN PERMEABLE RESIN BOUND AGGREGATE SURFACING
	P6		SOD LAWN
	P7	5 L7.6	SPORT FIELD LAWN - SOD
	P8	6 L7.6	SHRUB AND GROUND COVER PLANTING
	P9	3/4 L7.6	NO MOW SEED MIX
	P10		BIORETENTION SEED MIX
	P11		UPLAND SEED MIX
 LIMIT OF SAND BASED STRUCTURAL SOIL			

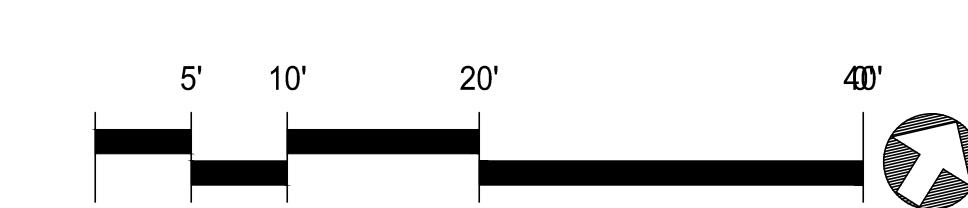

KEYPLA

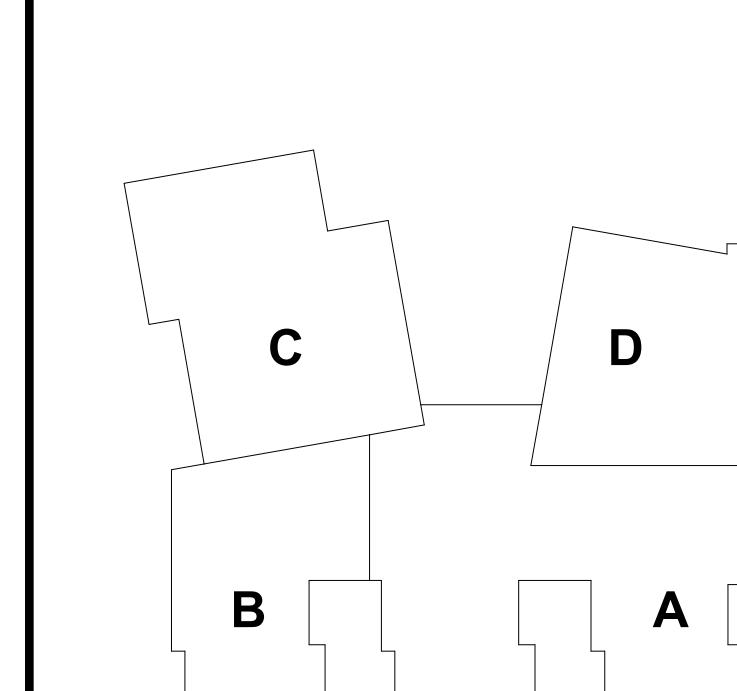

CONCORD MIDDLE SCHOOL	
CONCORD, NEW HAMPSHIRE	
FRONT PLAZA	
ENCLADEMENT I AVAILT DI AN	
6.2	BY
DRAWING NUMBER	
JOB NUMBER	
468	

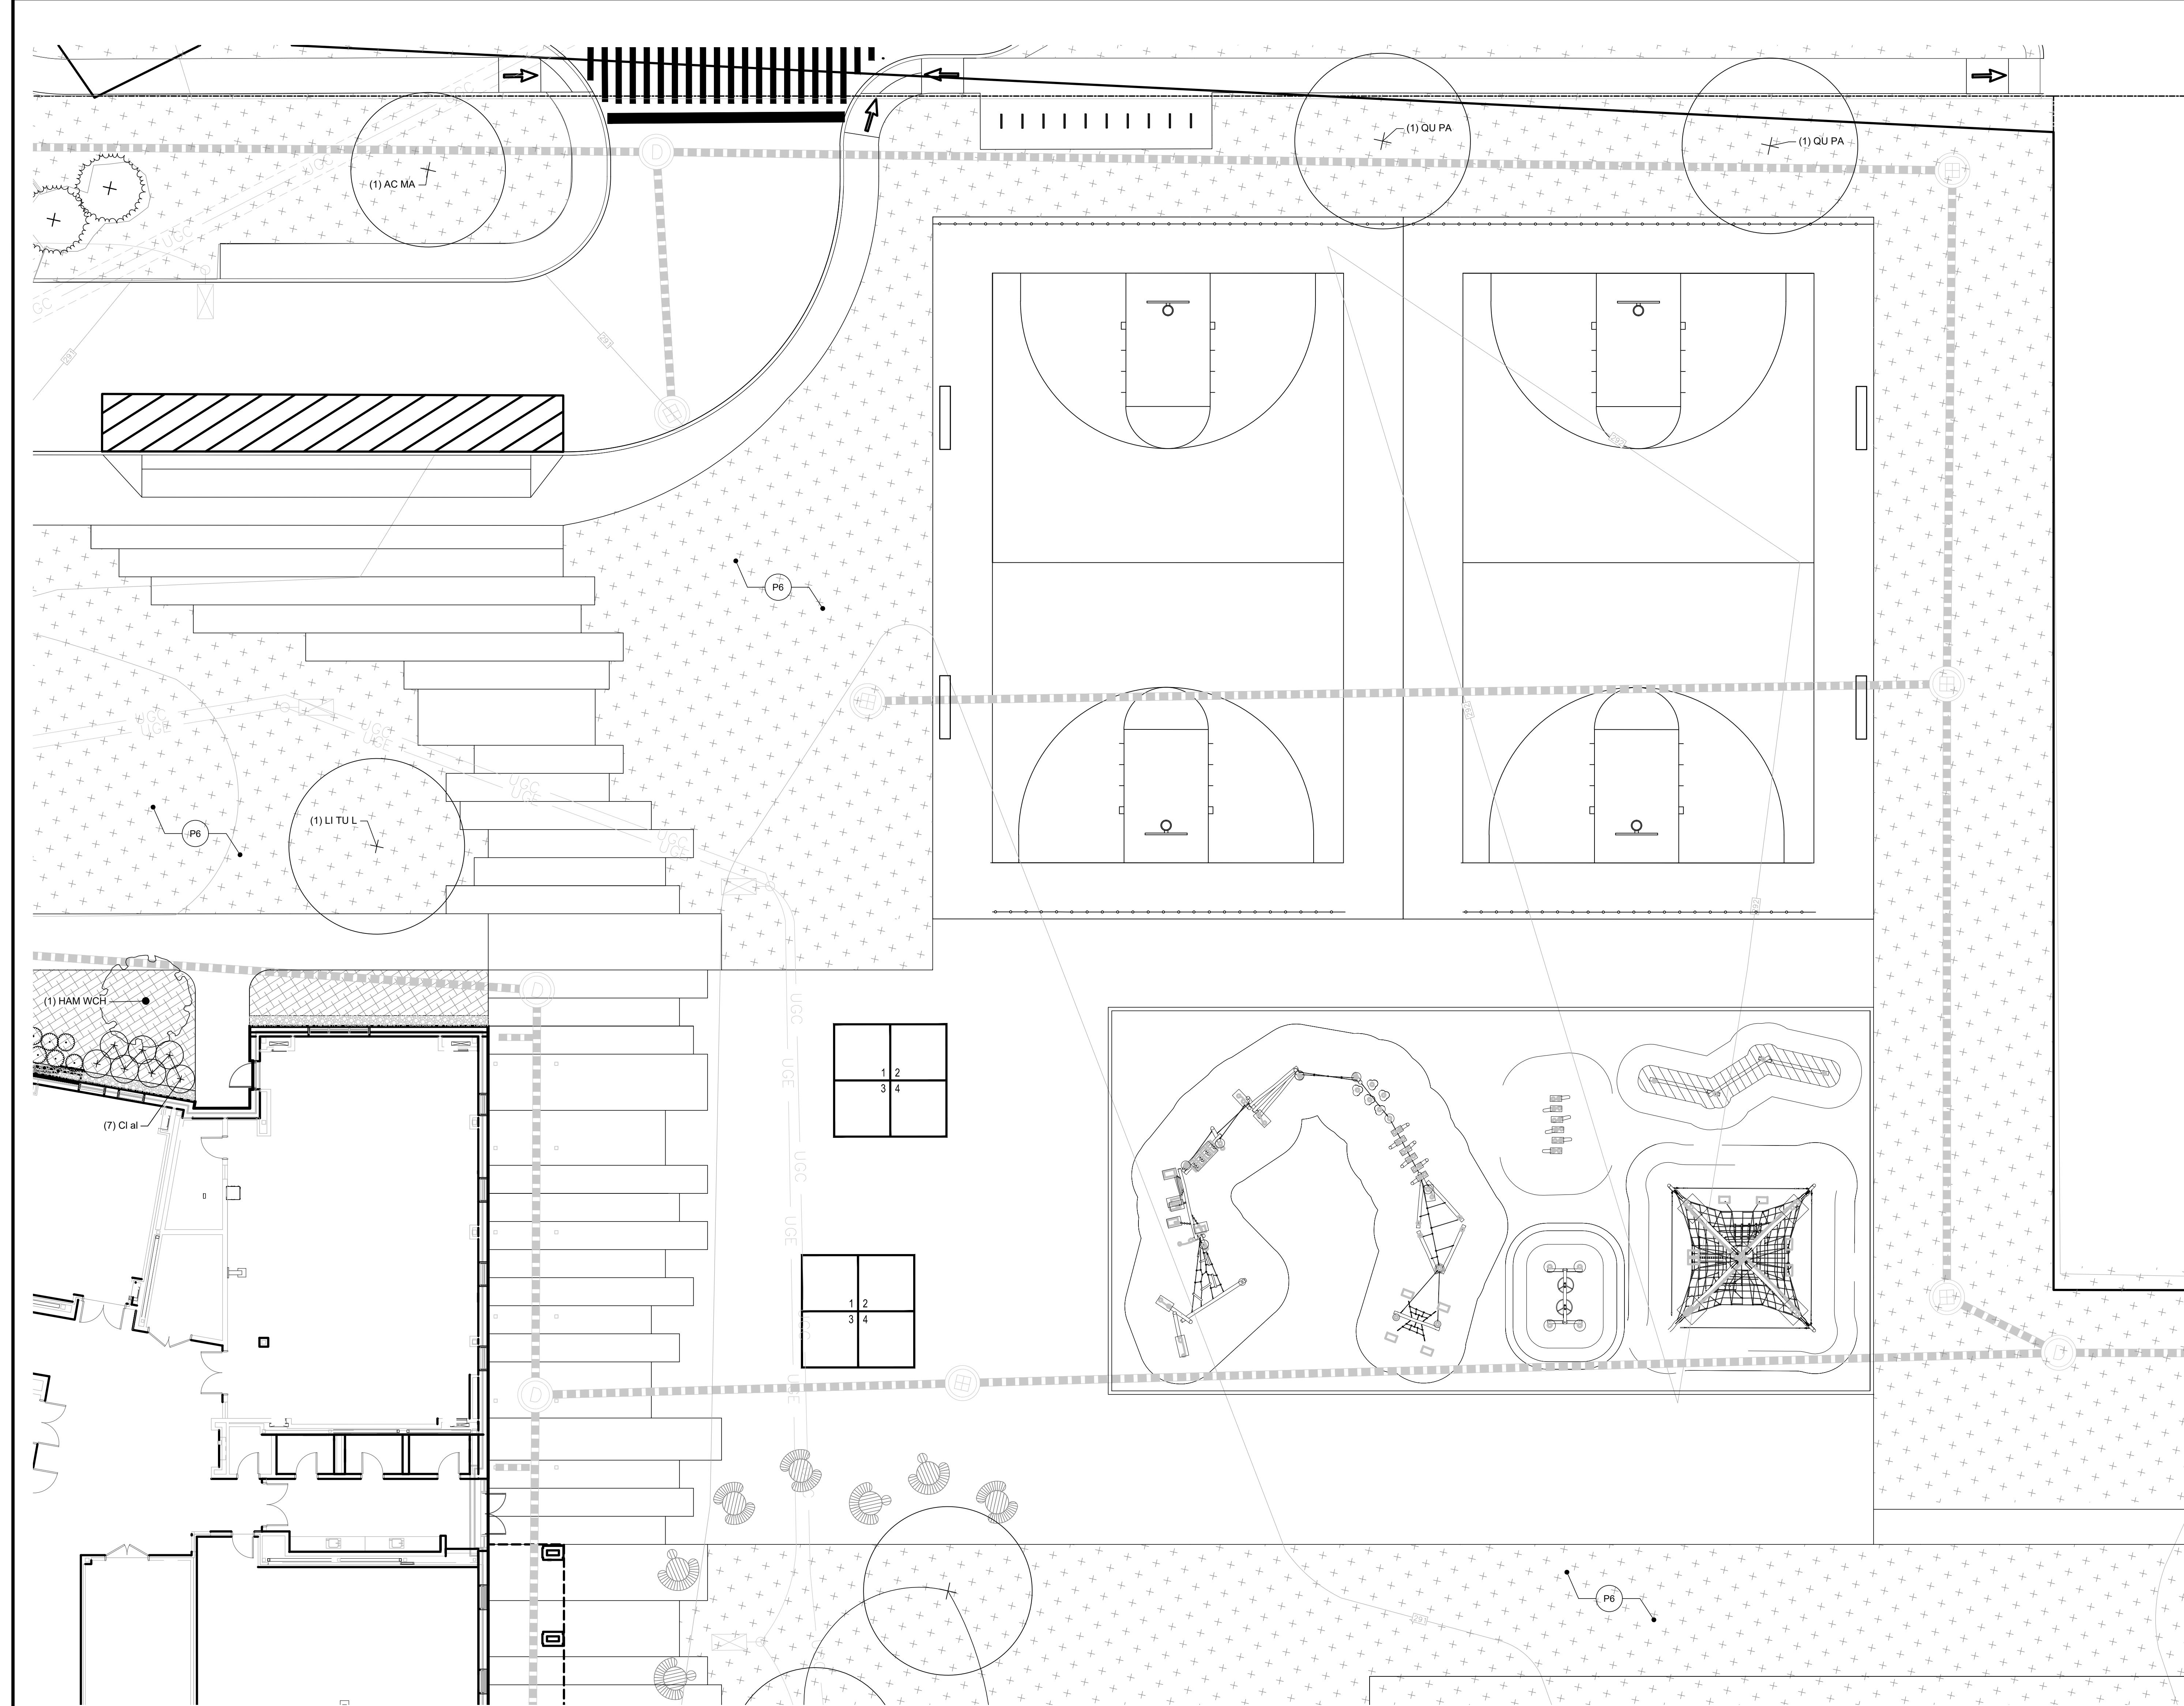

1 NORTHERN DROP-OFF AREA ENLARGEMENT - PLANTING PLAN


SCALE: 1"=10'0"

PLANTING MATERIALS LEGEND

SYM.	DET.	DESCRIPTION
●	P1	EXISTING TREE TO REMAIN
●	P2	DECIDUOUS TREE
●	P3	EVERGREEN TREE
●	P4	ORNAMENTAL TREE
●	P5	TREE IN PERMEABLE RESIN BOUND AGGREGATE SURFACING
■	P6	SOD LAWN
■	P7	SPORT FIELD LAWN - SOD
■	P8	SHRUB AND GROUND COVER PLANTING
■	P9	NO MOW SEED MIX
■	P10	BIORETENTION SEED MIX
■	P11	UPLAND SEED MIX
■		LIMIT OF SAND BASED STRUCTURAL SOIL


5' 10' 20' 40'

KEYPLAN

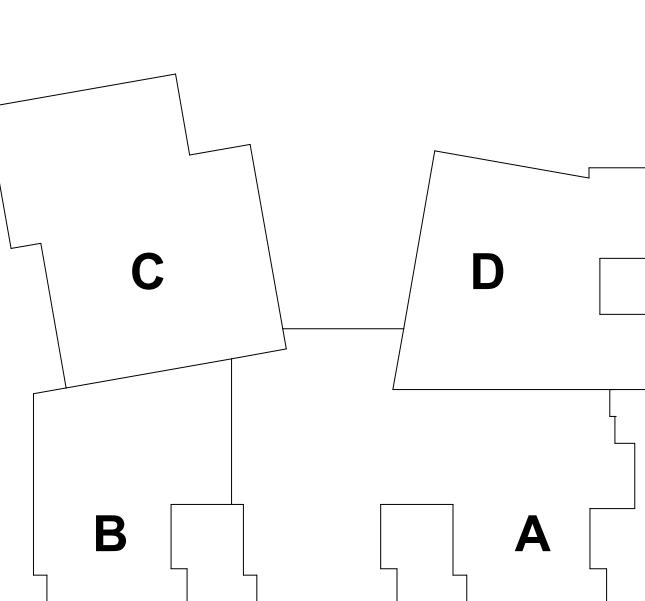

CONCORD NEW HAMPSHIRE
REAR PLAZA
ENLARGEMENT PLANTING PLAN
DRAWN BY LB
CHECKED BY JLB
SCALE: 1"=10'0"

6.3
JOB NUMBER 468723
DRAWING NUMBER
REVISIONS NO. DATE REMARKS
BY

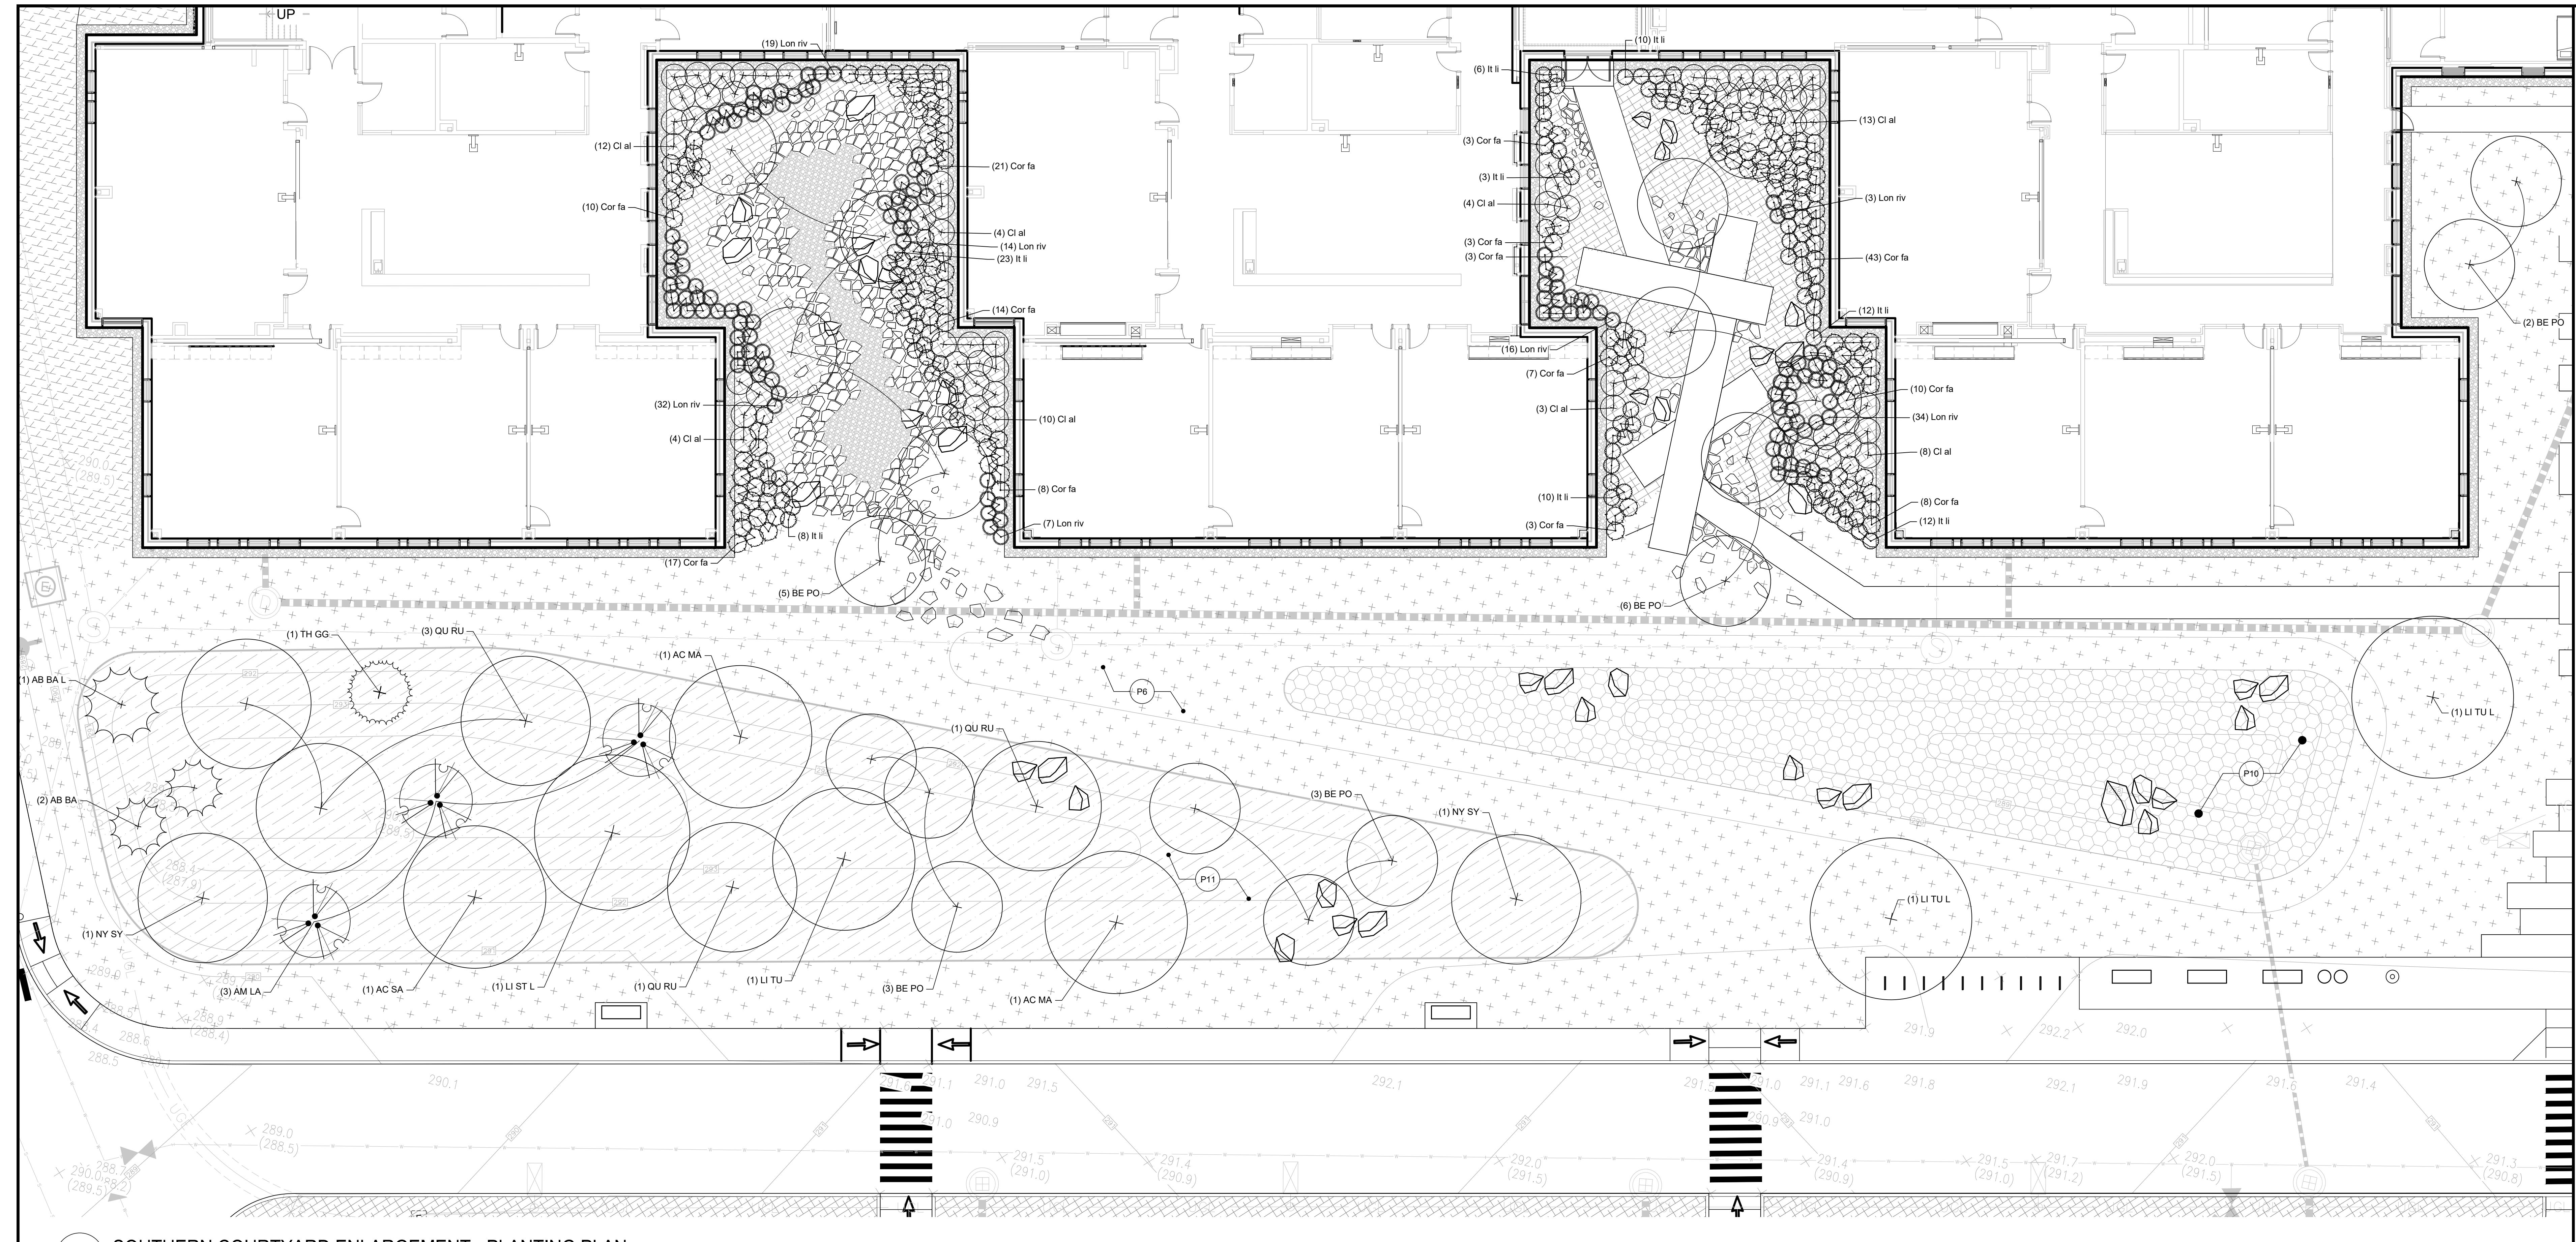


1 SOUTHERN COURTYARD ENLARGEMENT - PLANTING PLAN
SCALE: 1"=10'0"




SCALE: 1"=10'=0

PLANTING MATERIALS LEGEND


SYM.	DET.	DESCRIPTION
•	P1	EXISTING TREE TO REMAIN
+	P2	DECIDUOUS TREE
	P3	EVERGREEN TREE
*	P4	ORNAMENTAL TREE
+	P5	TREE IN PERMEABLE RESIN BOUND AGGREGATE SURFACING
	P6	SOD LAWN
	P7	SPORT FIELD LAWN - SOD
	P8	SHRUB AND GROUND COVER PLANTING
	P9	NO MOW SEED MIX
	P10	BIORETENTION SEED MIX
	P11	UPLAND SEED MIX
		LIMIT OF SAND BASED STRUCTURAL SOIL

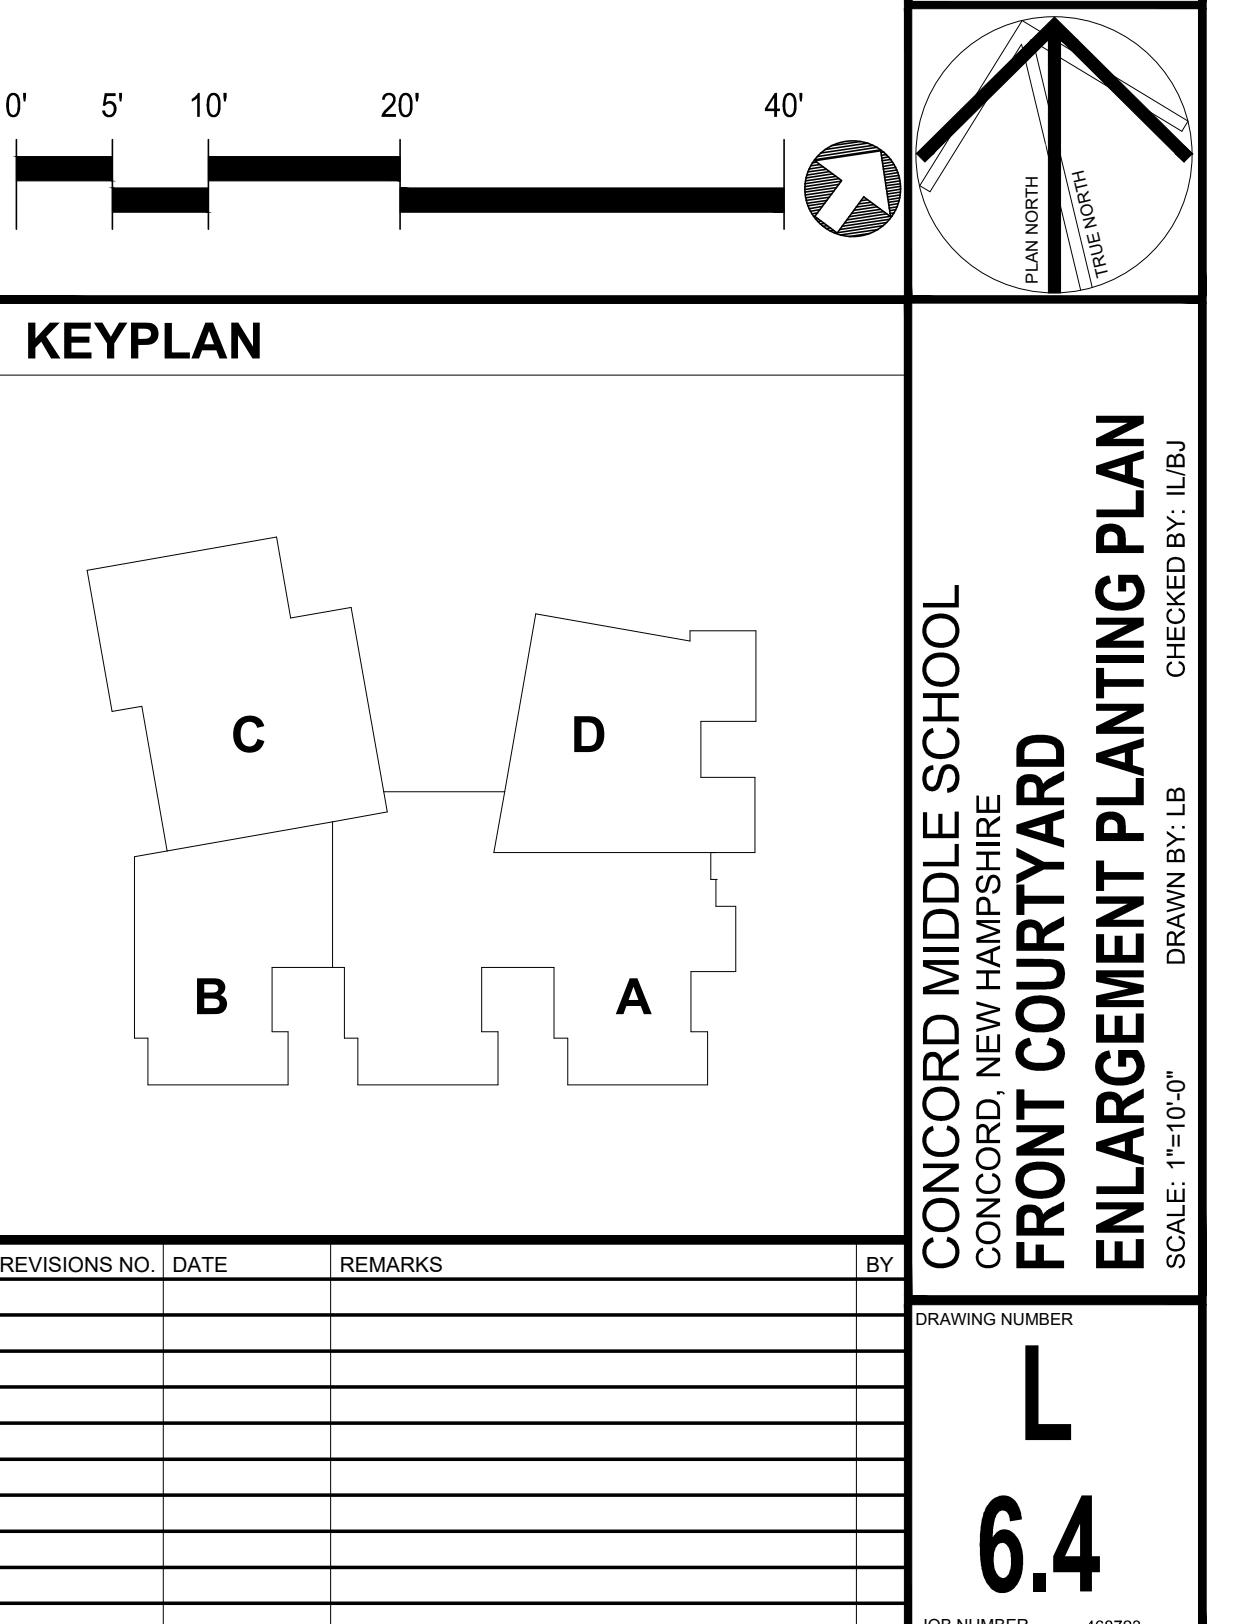

6.4

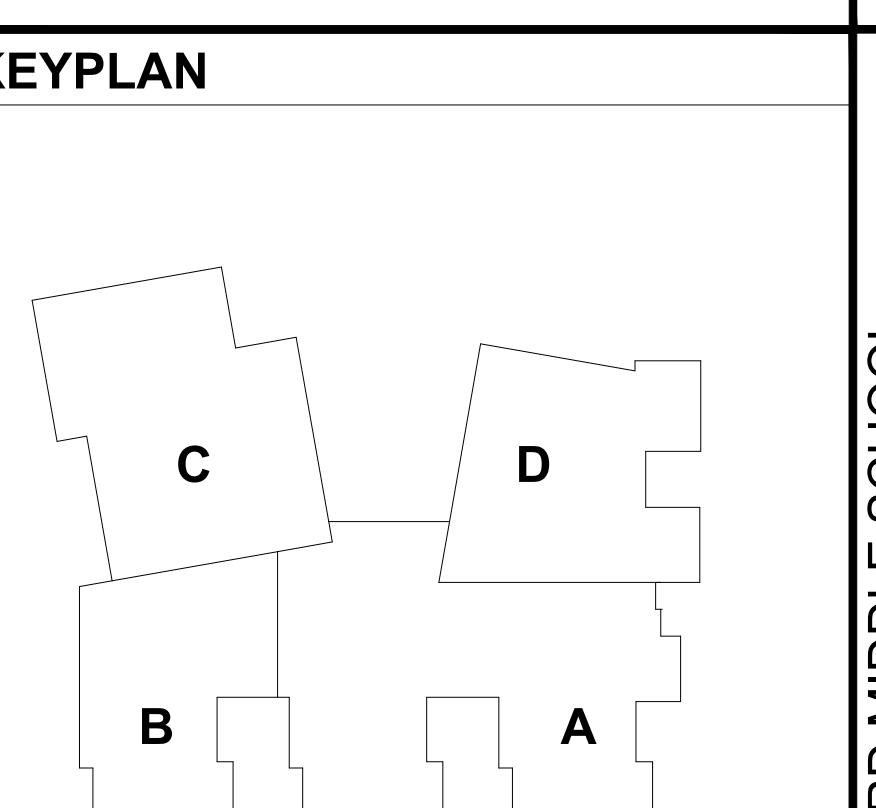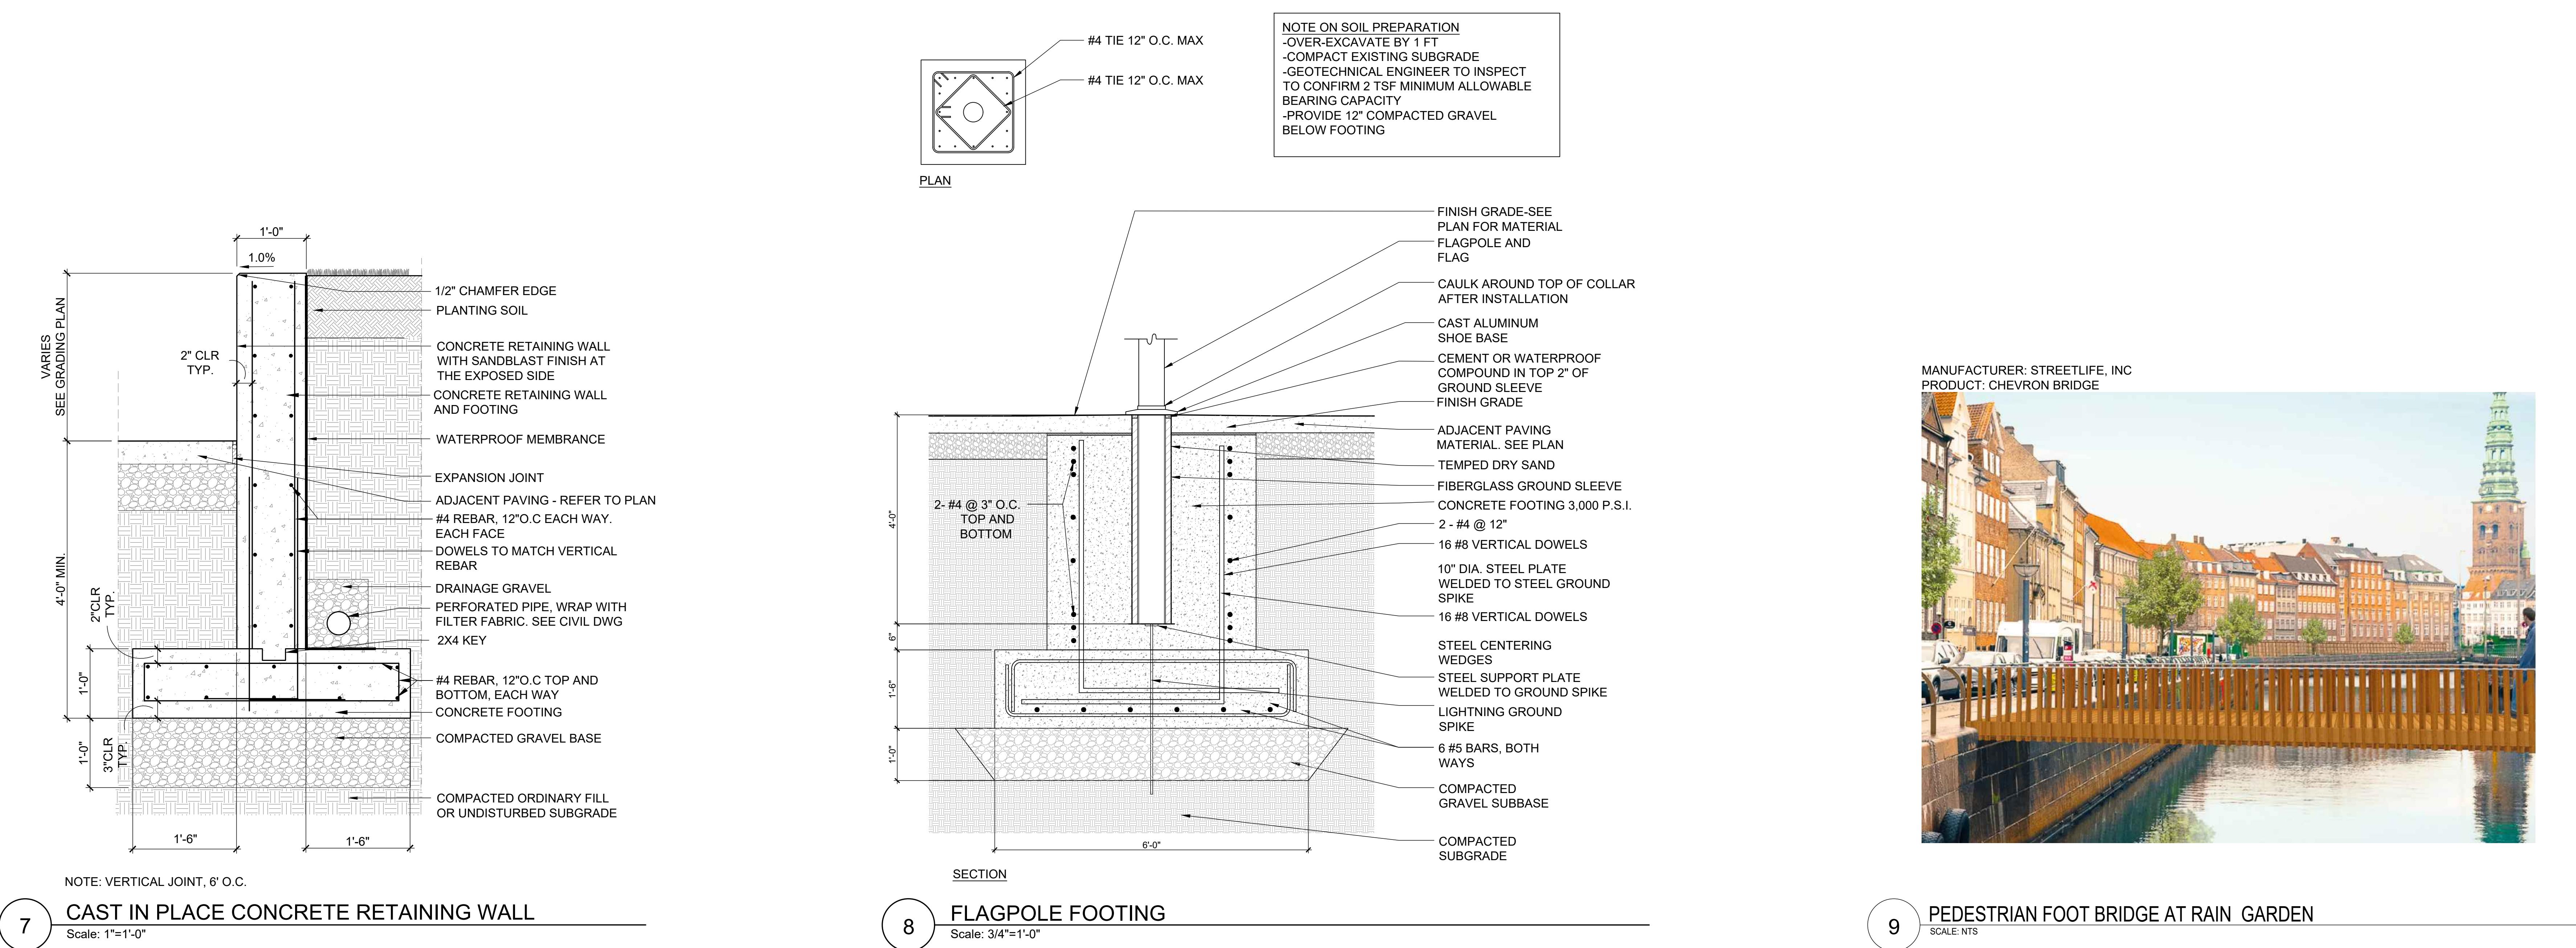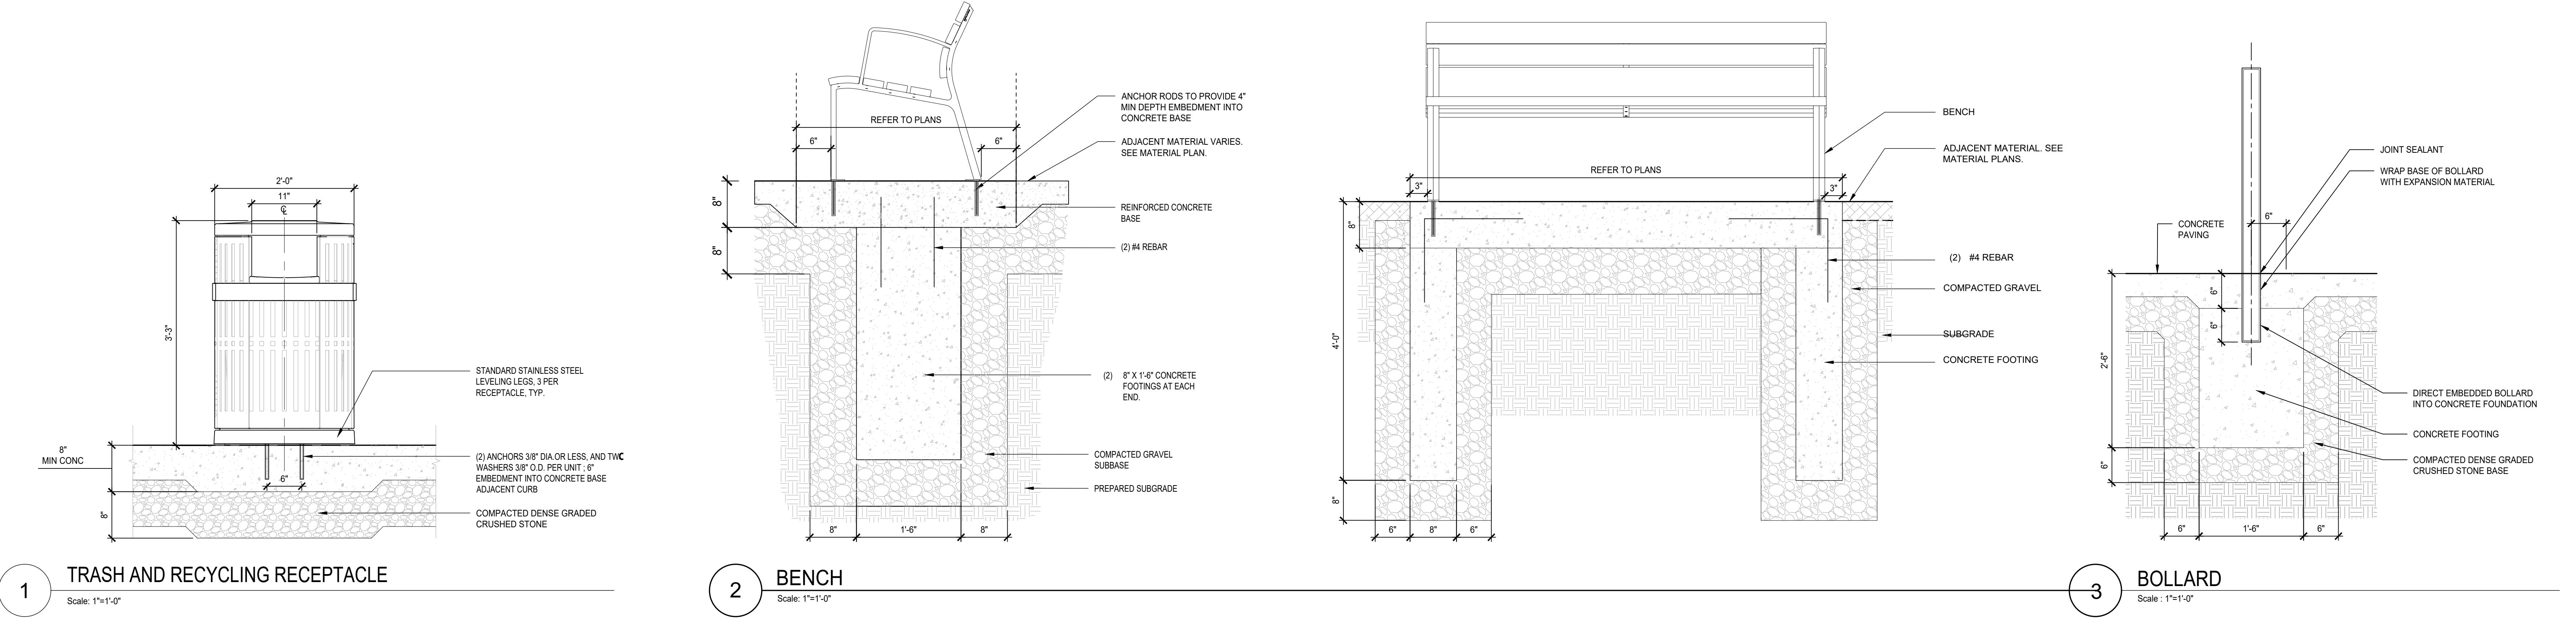


REVISIONS NO.	DATE	REMARKS
1	12/17/2025	DRAWN BY: LB
2	12/17/2025	CHECKED BY: ILB
3	12/17/2025	SCALE AS NOTED
4	12/17/2025	CONCORD MIDDLE SCHOOL
5	12/17/2025	CONCORD NEW HAMPSHIRE
6	12/17/2025	SITE DETAILS
7	12/17/2025	KEYPLAN
8	12/17/2025	L
9	12/17/2025	7.2

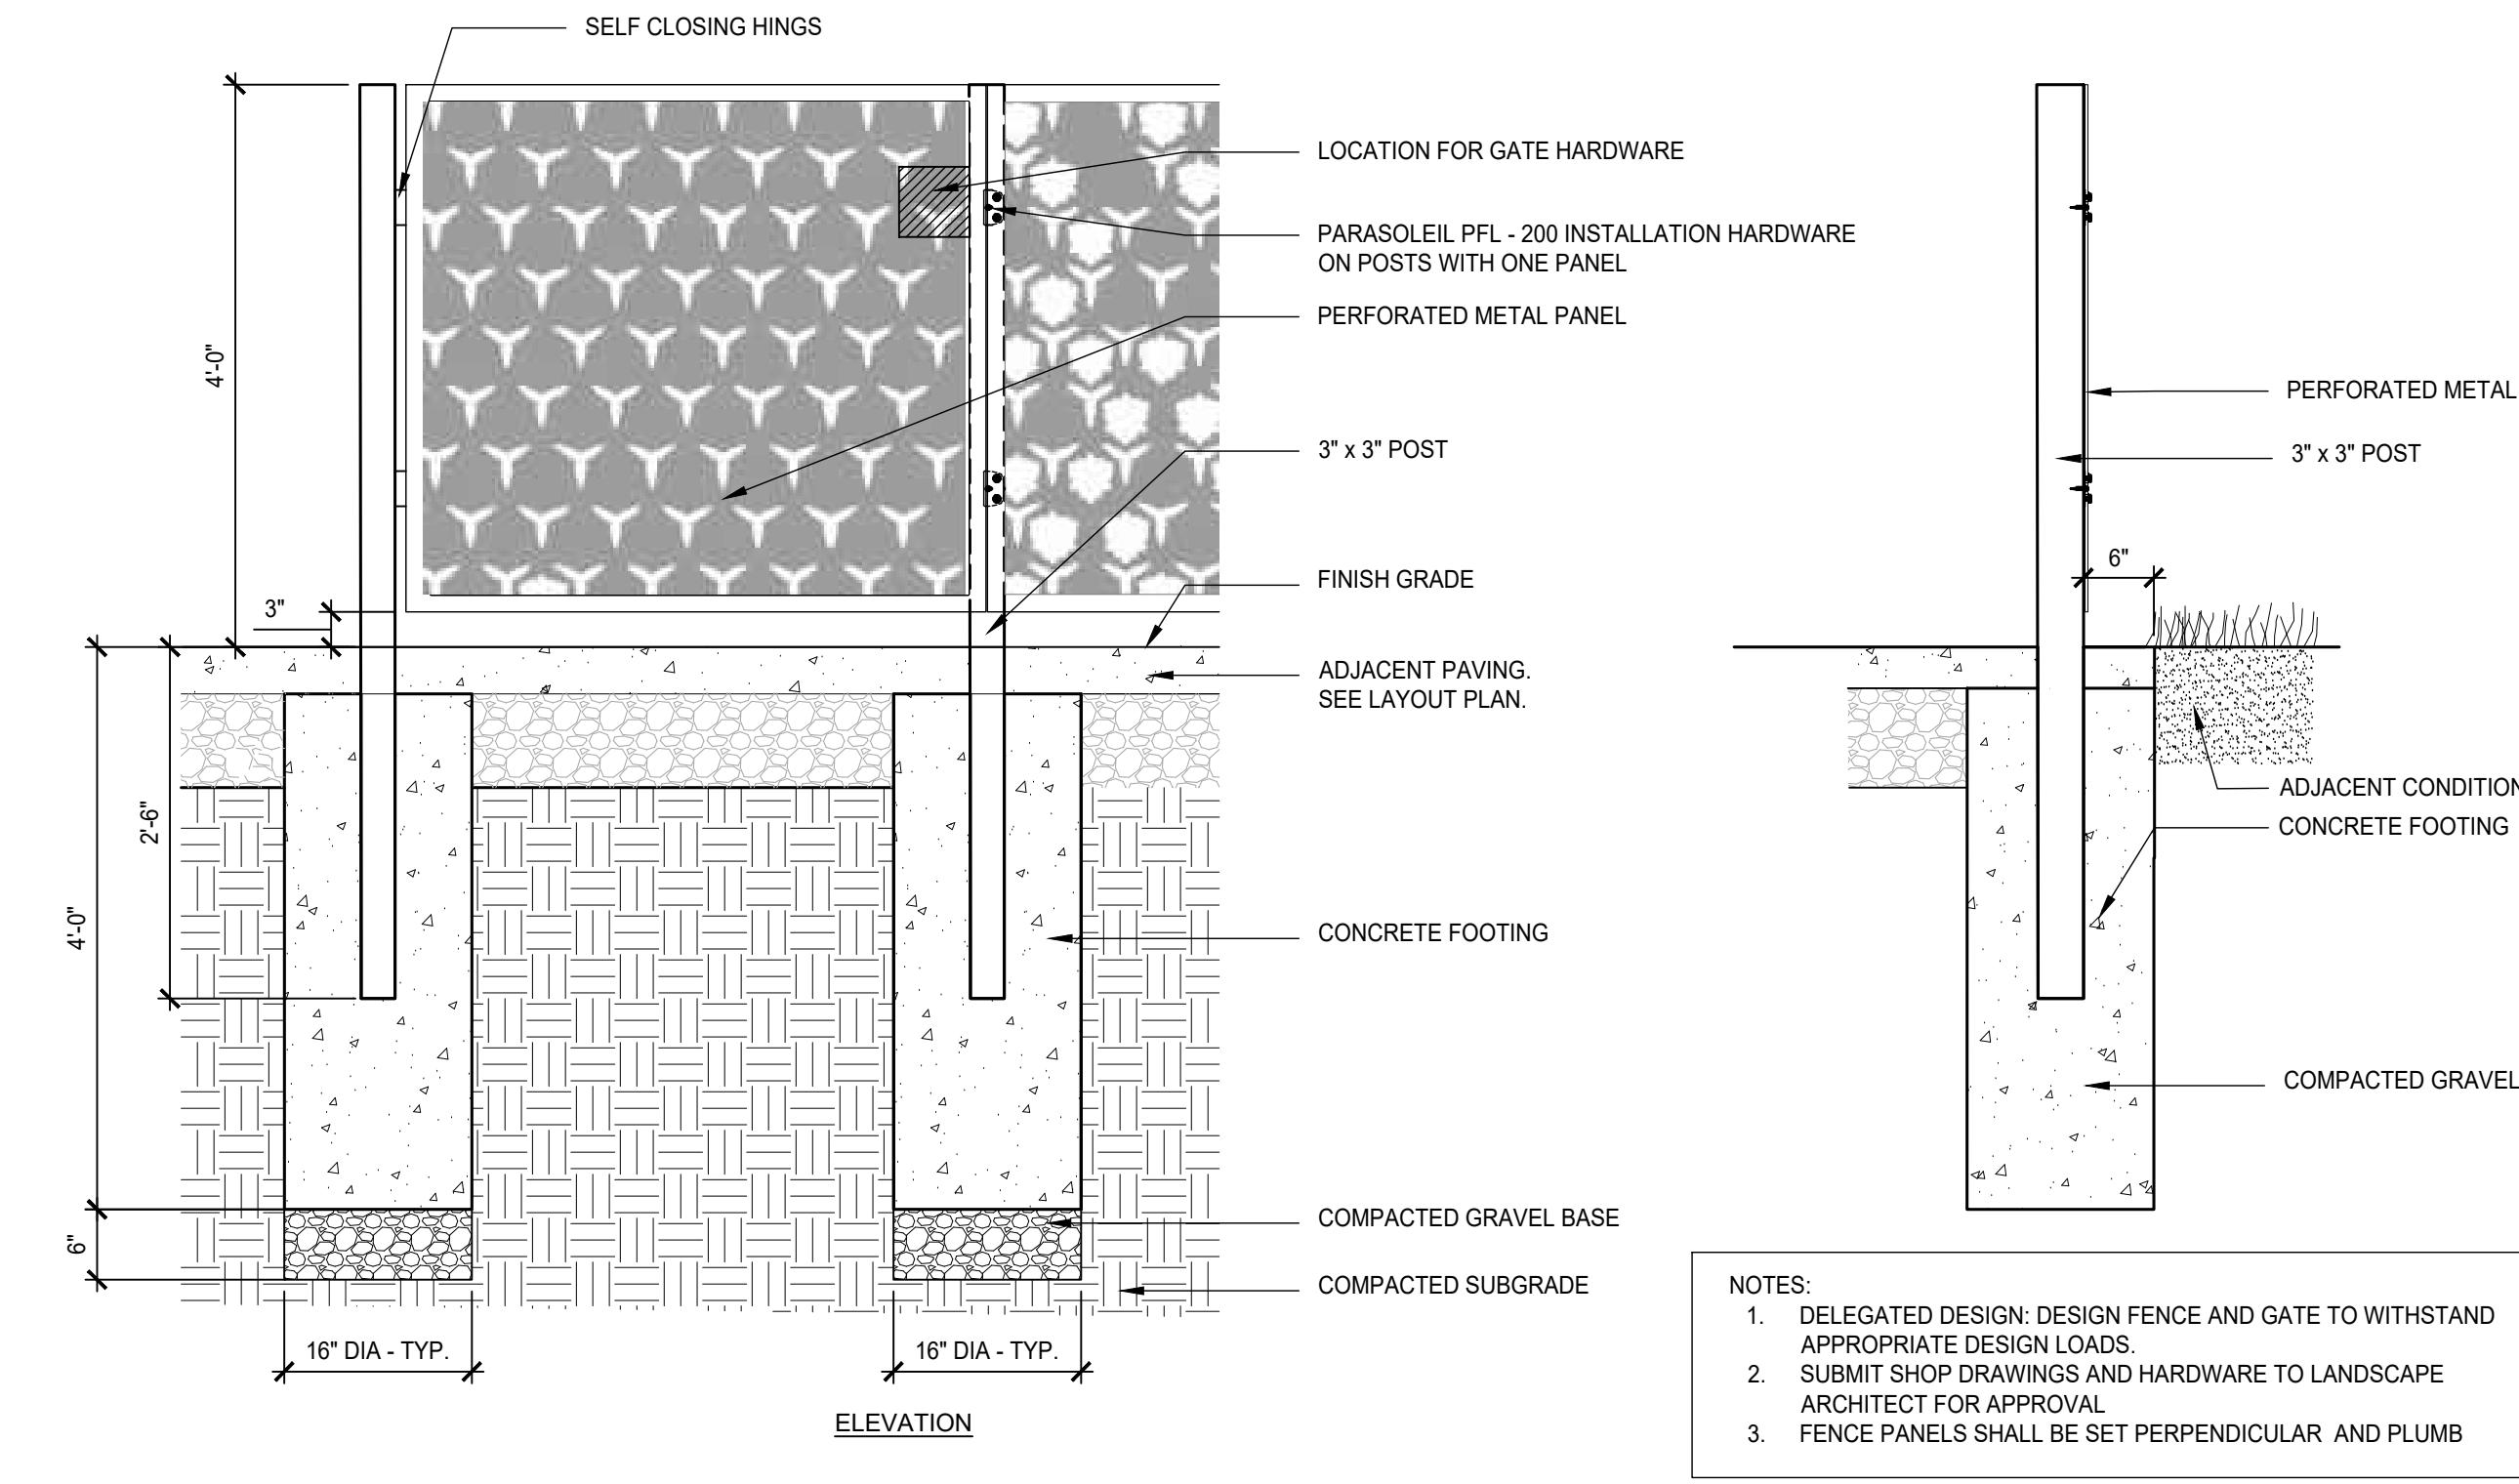


1 ORNAMENTAL METAL SINGLE GATE

Scale: 3/4" = 1'

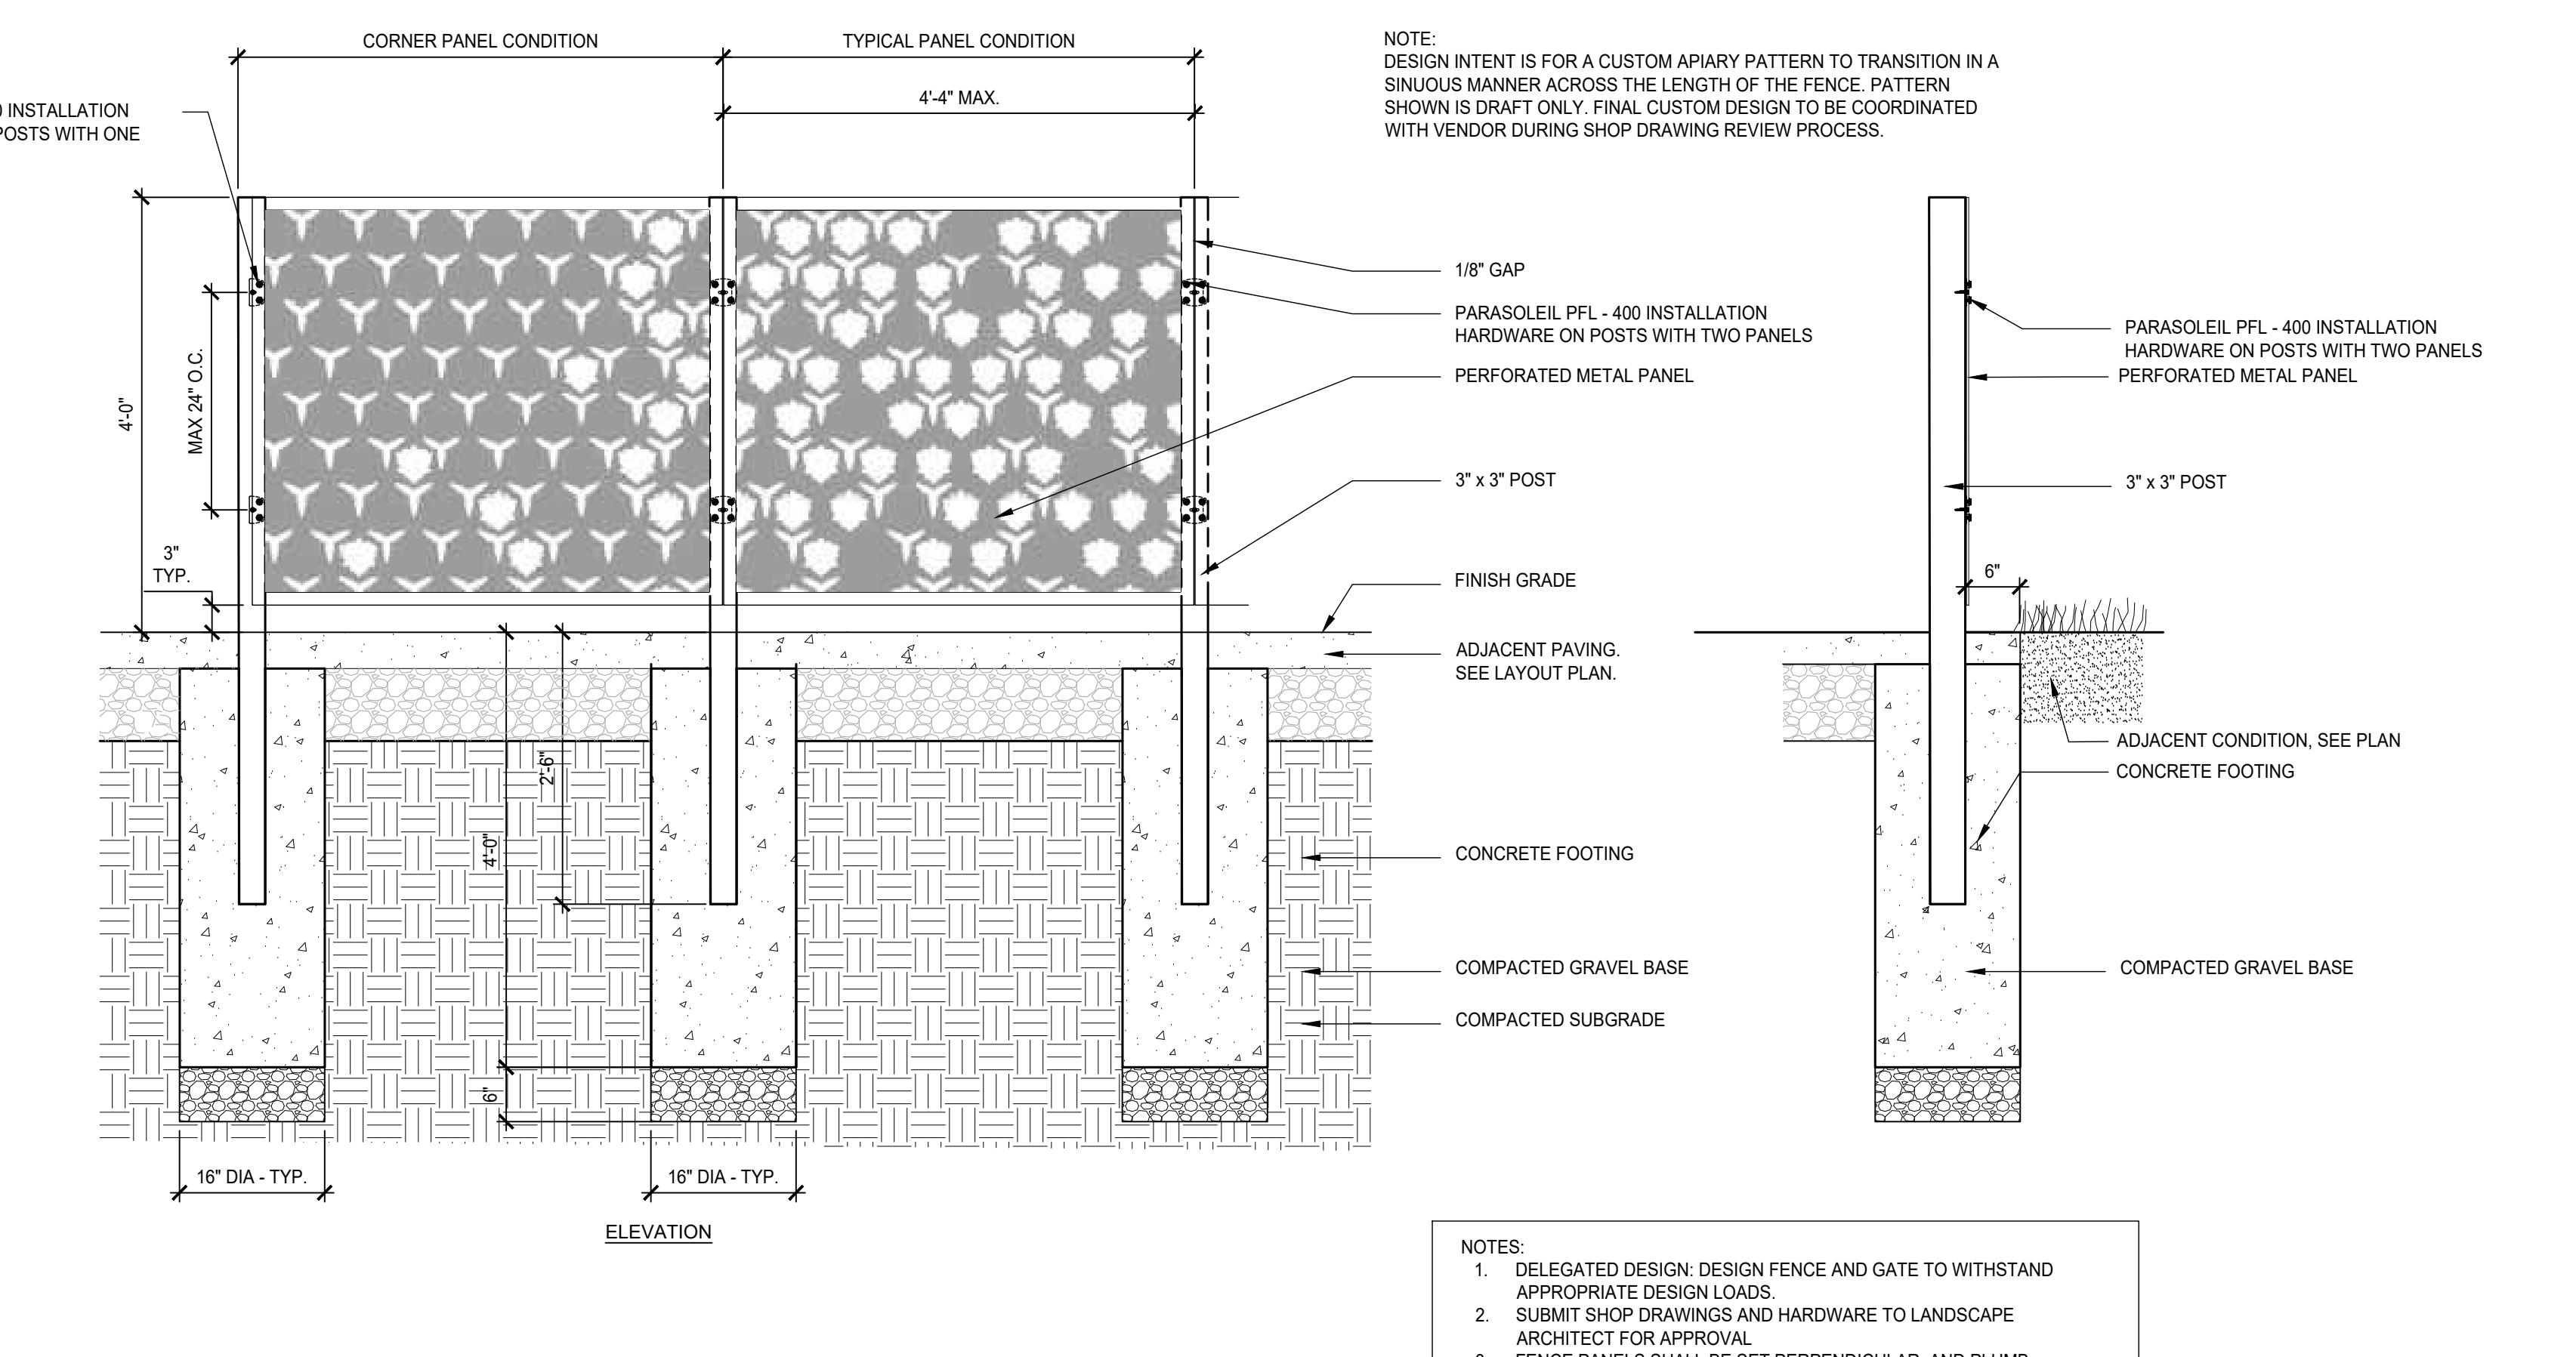


2 ORNAMENTAL METAL FENCE

2 Scale: 3/4" = 1

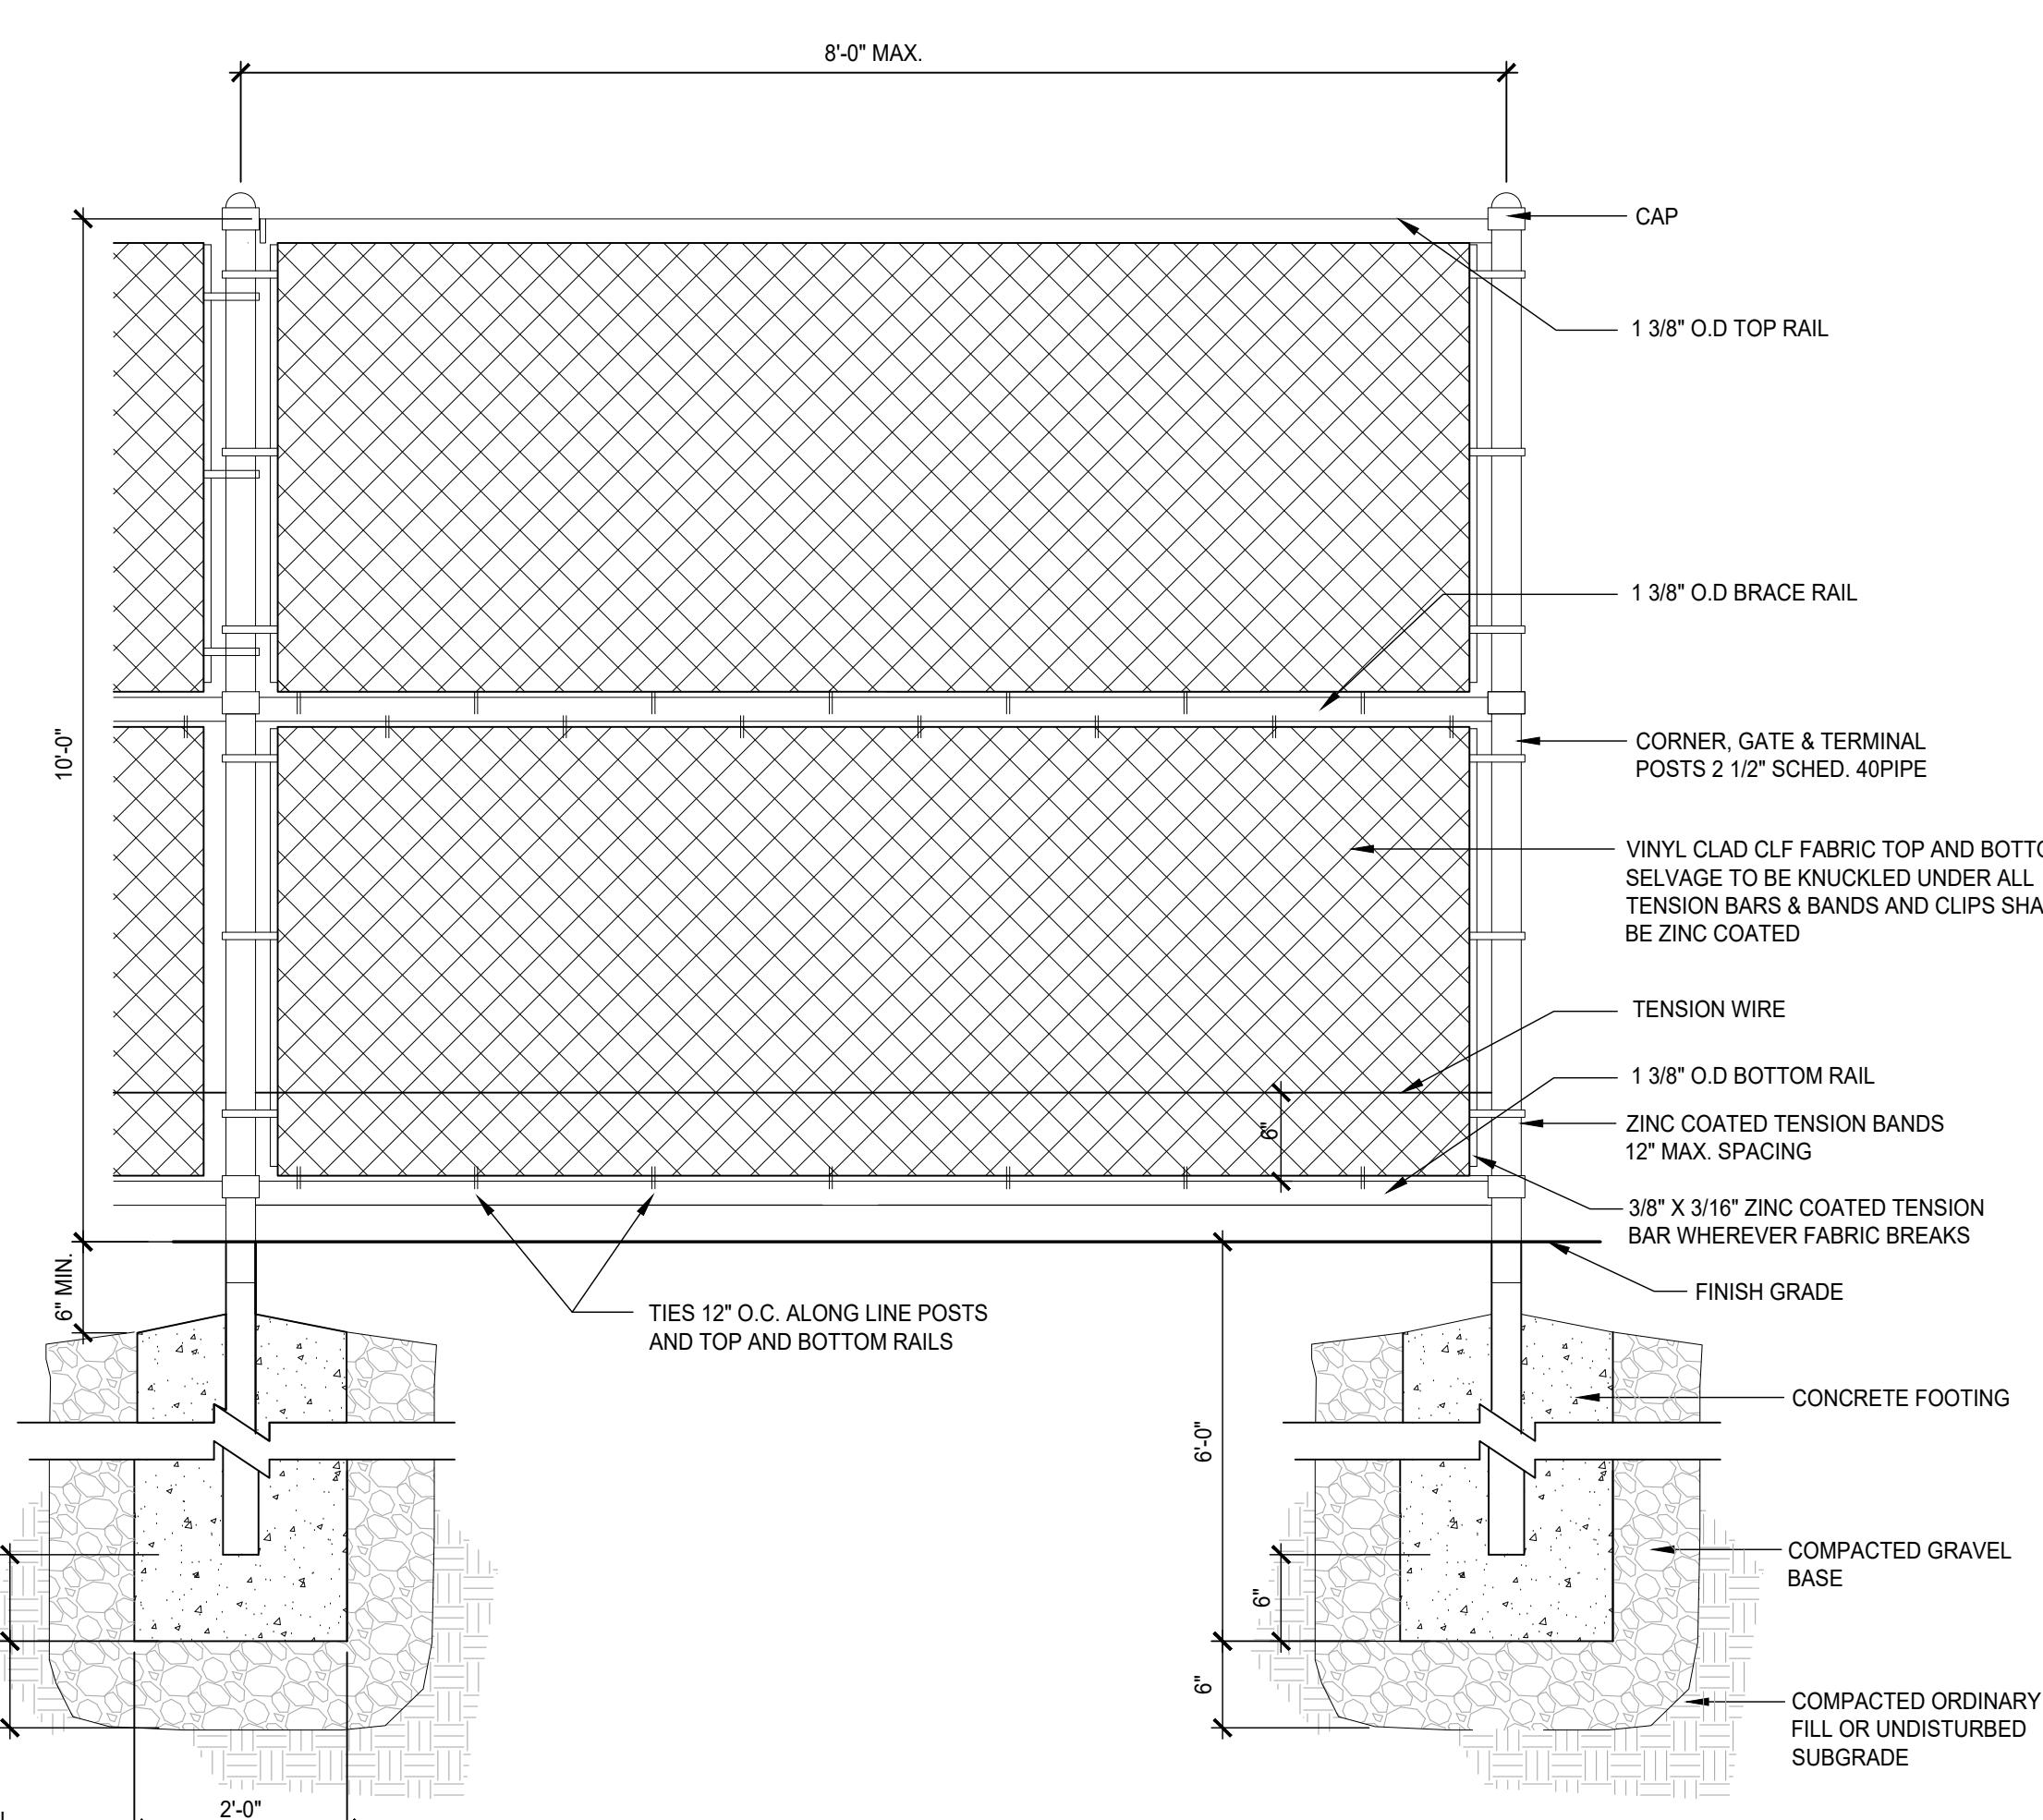


3 CHAIN LINK FENCE - 10'-0" H

3

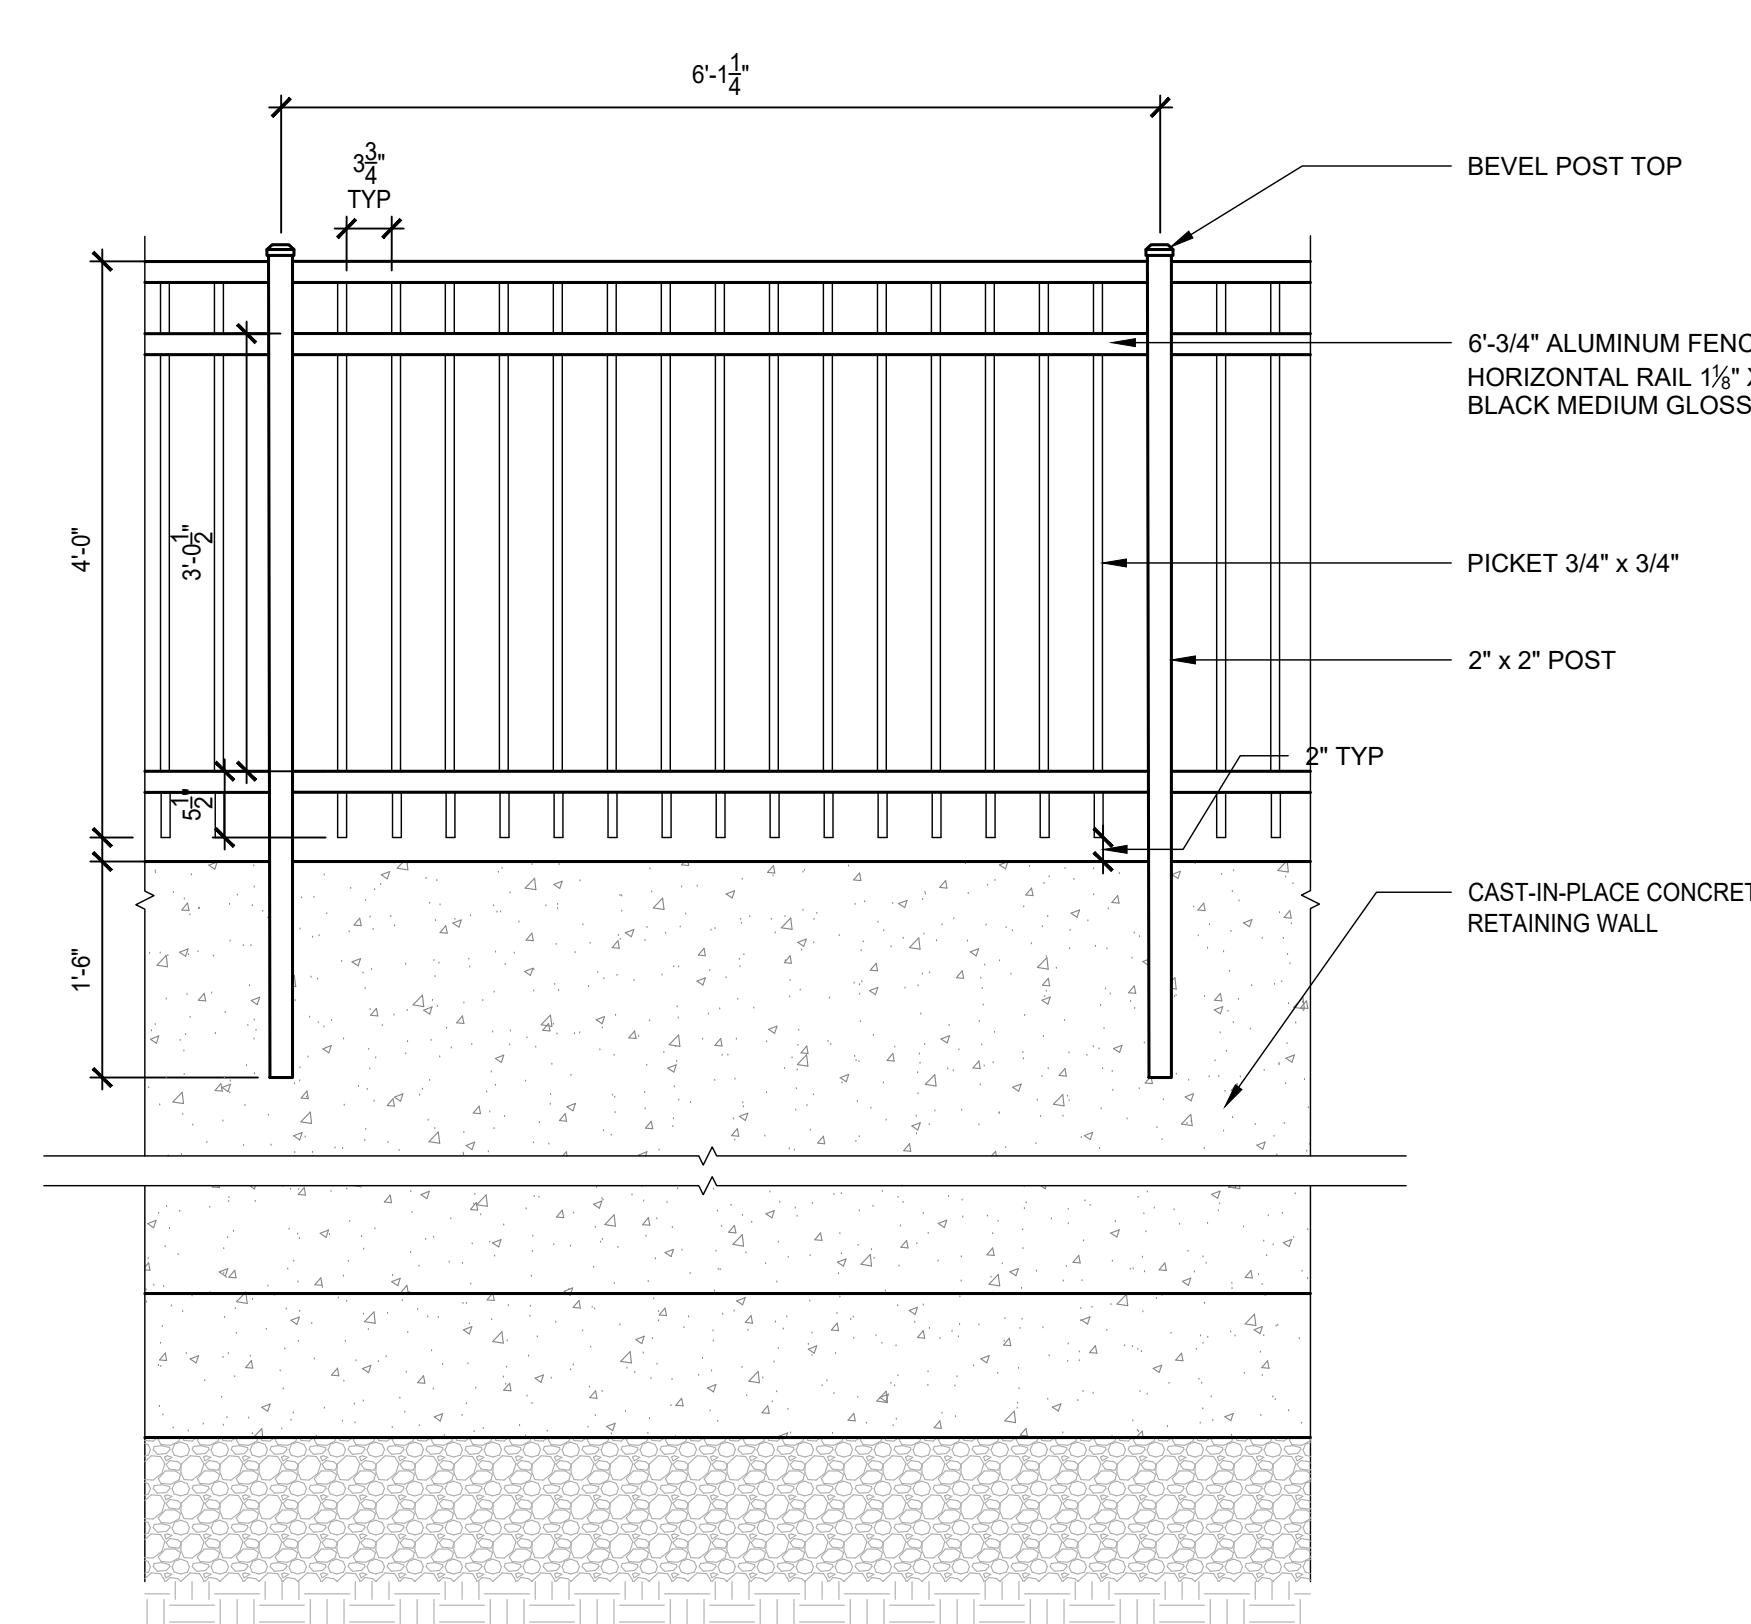

ORNAMENTAL METAL GUARDRAIL 4' HT

(4) ORN
SCALE 2/4

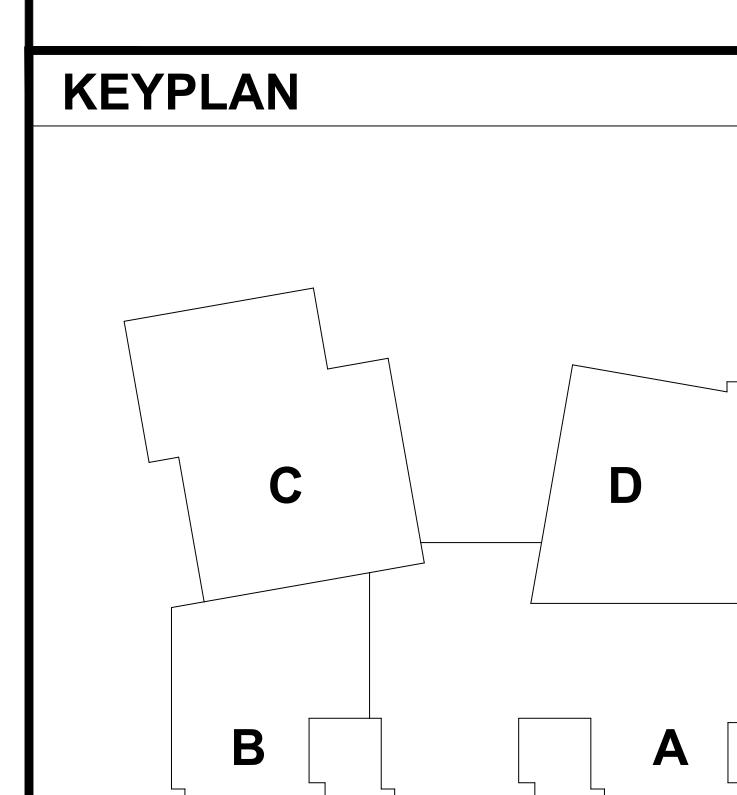

KEYPI

