# MINOR SITE PLAN SINGLE-FAMILY RESIDENCE & HOME BUSINESS



# TAX MAPS, LOT: 411Z/49 & 28Z/43 50 & 68 SHAKER ROAD, CONCORD, NH

### GENERAL LEGEND DESCRIPTION GENERAL TIDAL WETLANDS SOIL BOUNDARY TREE LINE EDGE OF GRAVEL **GUARDRAIL** MAJOR CONTOUR **CIVIL ENGINEER** MINOR CONTOUR **FENCE** JONES & BEACH ENGINEERS, INC. CENTERLINE PO BOX 219 SILTFENCE **85 PORTSMOUTH AVE** LIGHT POLE SINGLE/DOUBLE POST SIGN STRATHAM, NH 03885 (603) 772-4746 TEMPORARY BENCHMARK CONTACT: IAN MACKINNON, P.E. TEST PIT PERCOLATION TEST TEST BORING WETLAND CONSULTANT LEDGE PROBE MONITORING WELL POND VIEW WETLAND CONSULTANTS, LLC PHOTO LOCATION 237 BEAUTY HILL RD CENTER BARNSTEAD, NH 03225 DRAIN LINE (603) 520-6120 UNDERDRAIN CONTACT: JIM FOUGERE, CWS ROOF DRAIN FOUNDATION DRAIN CATCH BASIN DRAIN MANHOLE WATER MAIN LINE FIRE DEPARTMENT CONNECTION WATER GATE VALVE HYDRANT WELL SEWER LINE SEWER FORCEMAIN SEWER MANHOLE OVERHEAD ELECTRIC LINES UNDERGROUND ELECTRIC LINES UTILITY POLE GUY WIRE ANCHOR UTILITY SUPPORT POLE ELECTRIC METER TRANSFORMER GAS LINE GAS METER GAS GATE VALVE BOUNDARY PROPERTY LINE ABUTTER PROPERTY LINE EASEMENT LINE • STONE WALL .00000000 REMNANT STONE WALL BARBWIRE FENCE DH DRILL HOLE O IR/IP IRON ROD / IRON PIPE AS NOTED GRANITE BOUND ■ BND

# LOCUS SCALE: 1"=500"

LOCUS SCALE: 1"=2000'

# SHEET INDEX

- **EXISTING CONDITIONS PLAN**
- **OVERALL SITE & UTILITY PLAN**
- SITE & UTILITY PLAN
- **GRADING & DRAINAGE PLAN**
- LIGHTING PLAN
- **DRIVEWAY PLAN & PROFILE**
- **DETAIL SHEET**
- **EROSION & SEDIMENT CONTROL NOTES & DETAILS**
- **BUILDING ELEVATIONS WORKSHOP**
- **BUILDING ELEVATIONS SINGLE-FAMILY HOME**

APPROVED UNDER THE PROVISIONS OF R.S.A. 674: 35 & R.S.A. 674: 36 CITY PLANNING BOARD CITY OF CONCORD, NEW HAMPSHIRE IN ACCORDANCE WITH VOTE OF THE BOARD DATED:

APPROVAL OF THIS PLAT IS LIMITED TO LOTS AS SHOWN.

CLERK CHAIR

PROJECT PARCEL CITY OF CONCORD, NH TAX MAPS & LOTS: 411Z/49 AND 28Z/43

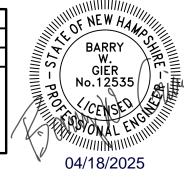
APPLICANT AARON LECLERC & CARA SCALA 29 HOT HOLE ROAD, CONCORD, NH 0330

**TOTAL LOT AREAS** 

656,373 SQ. FT. 21.8± ACRES 15.07 ACRES

Date: 04/18/2025 Design: ISM Draft: ISM Checked: WGM Scale: AS SHOWN Project No.: 24022 Drawing Name: 24022-PLAN.DWG

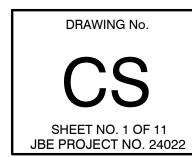
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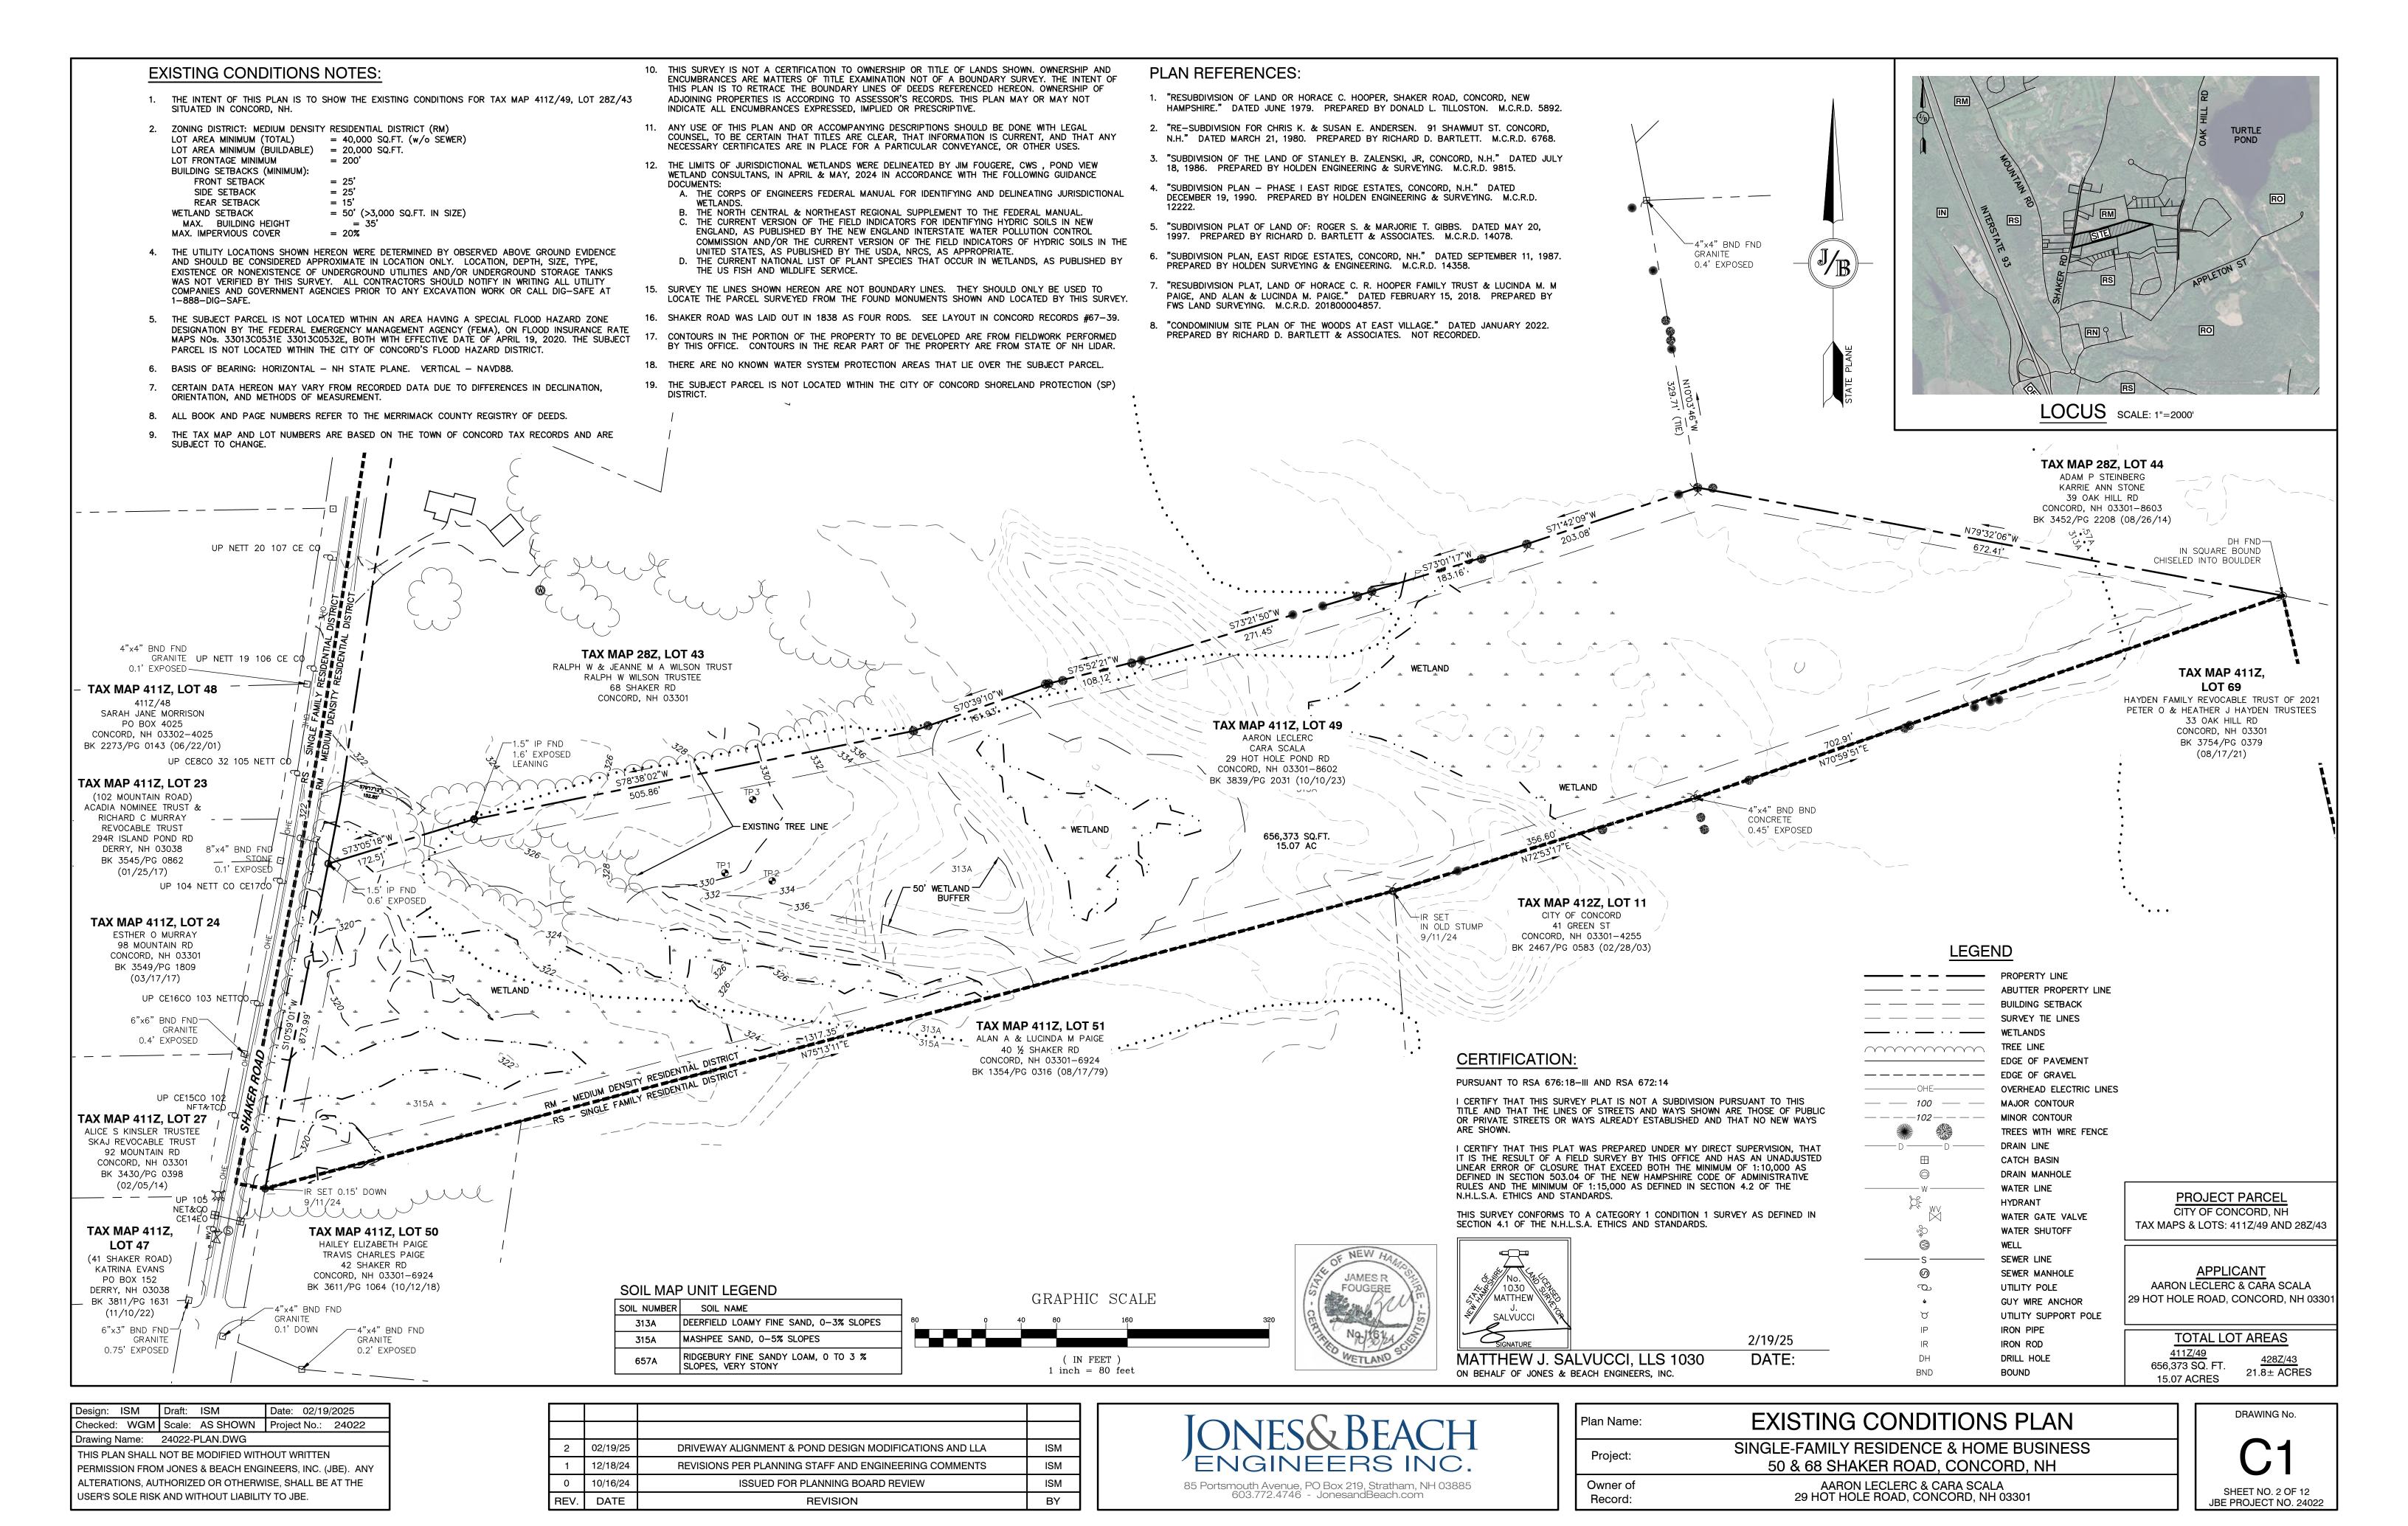


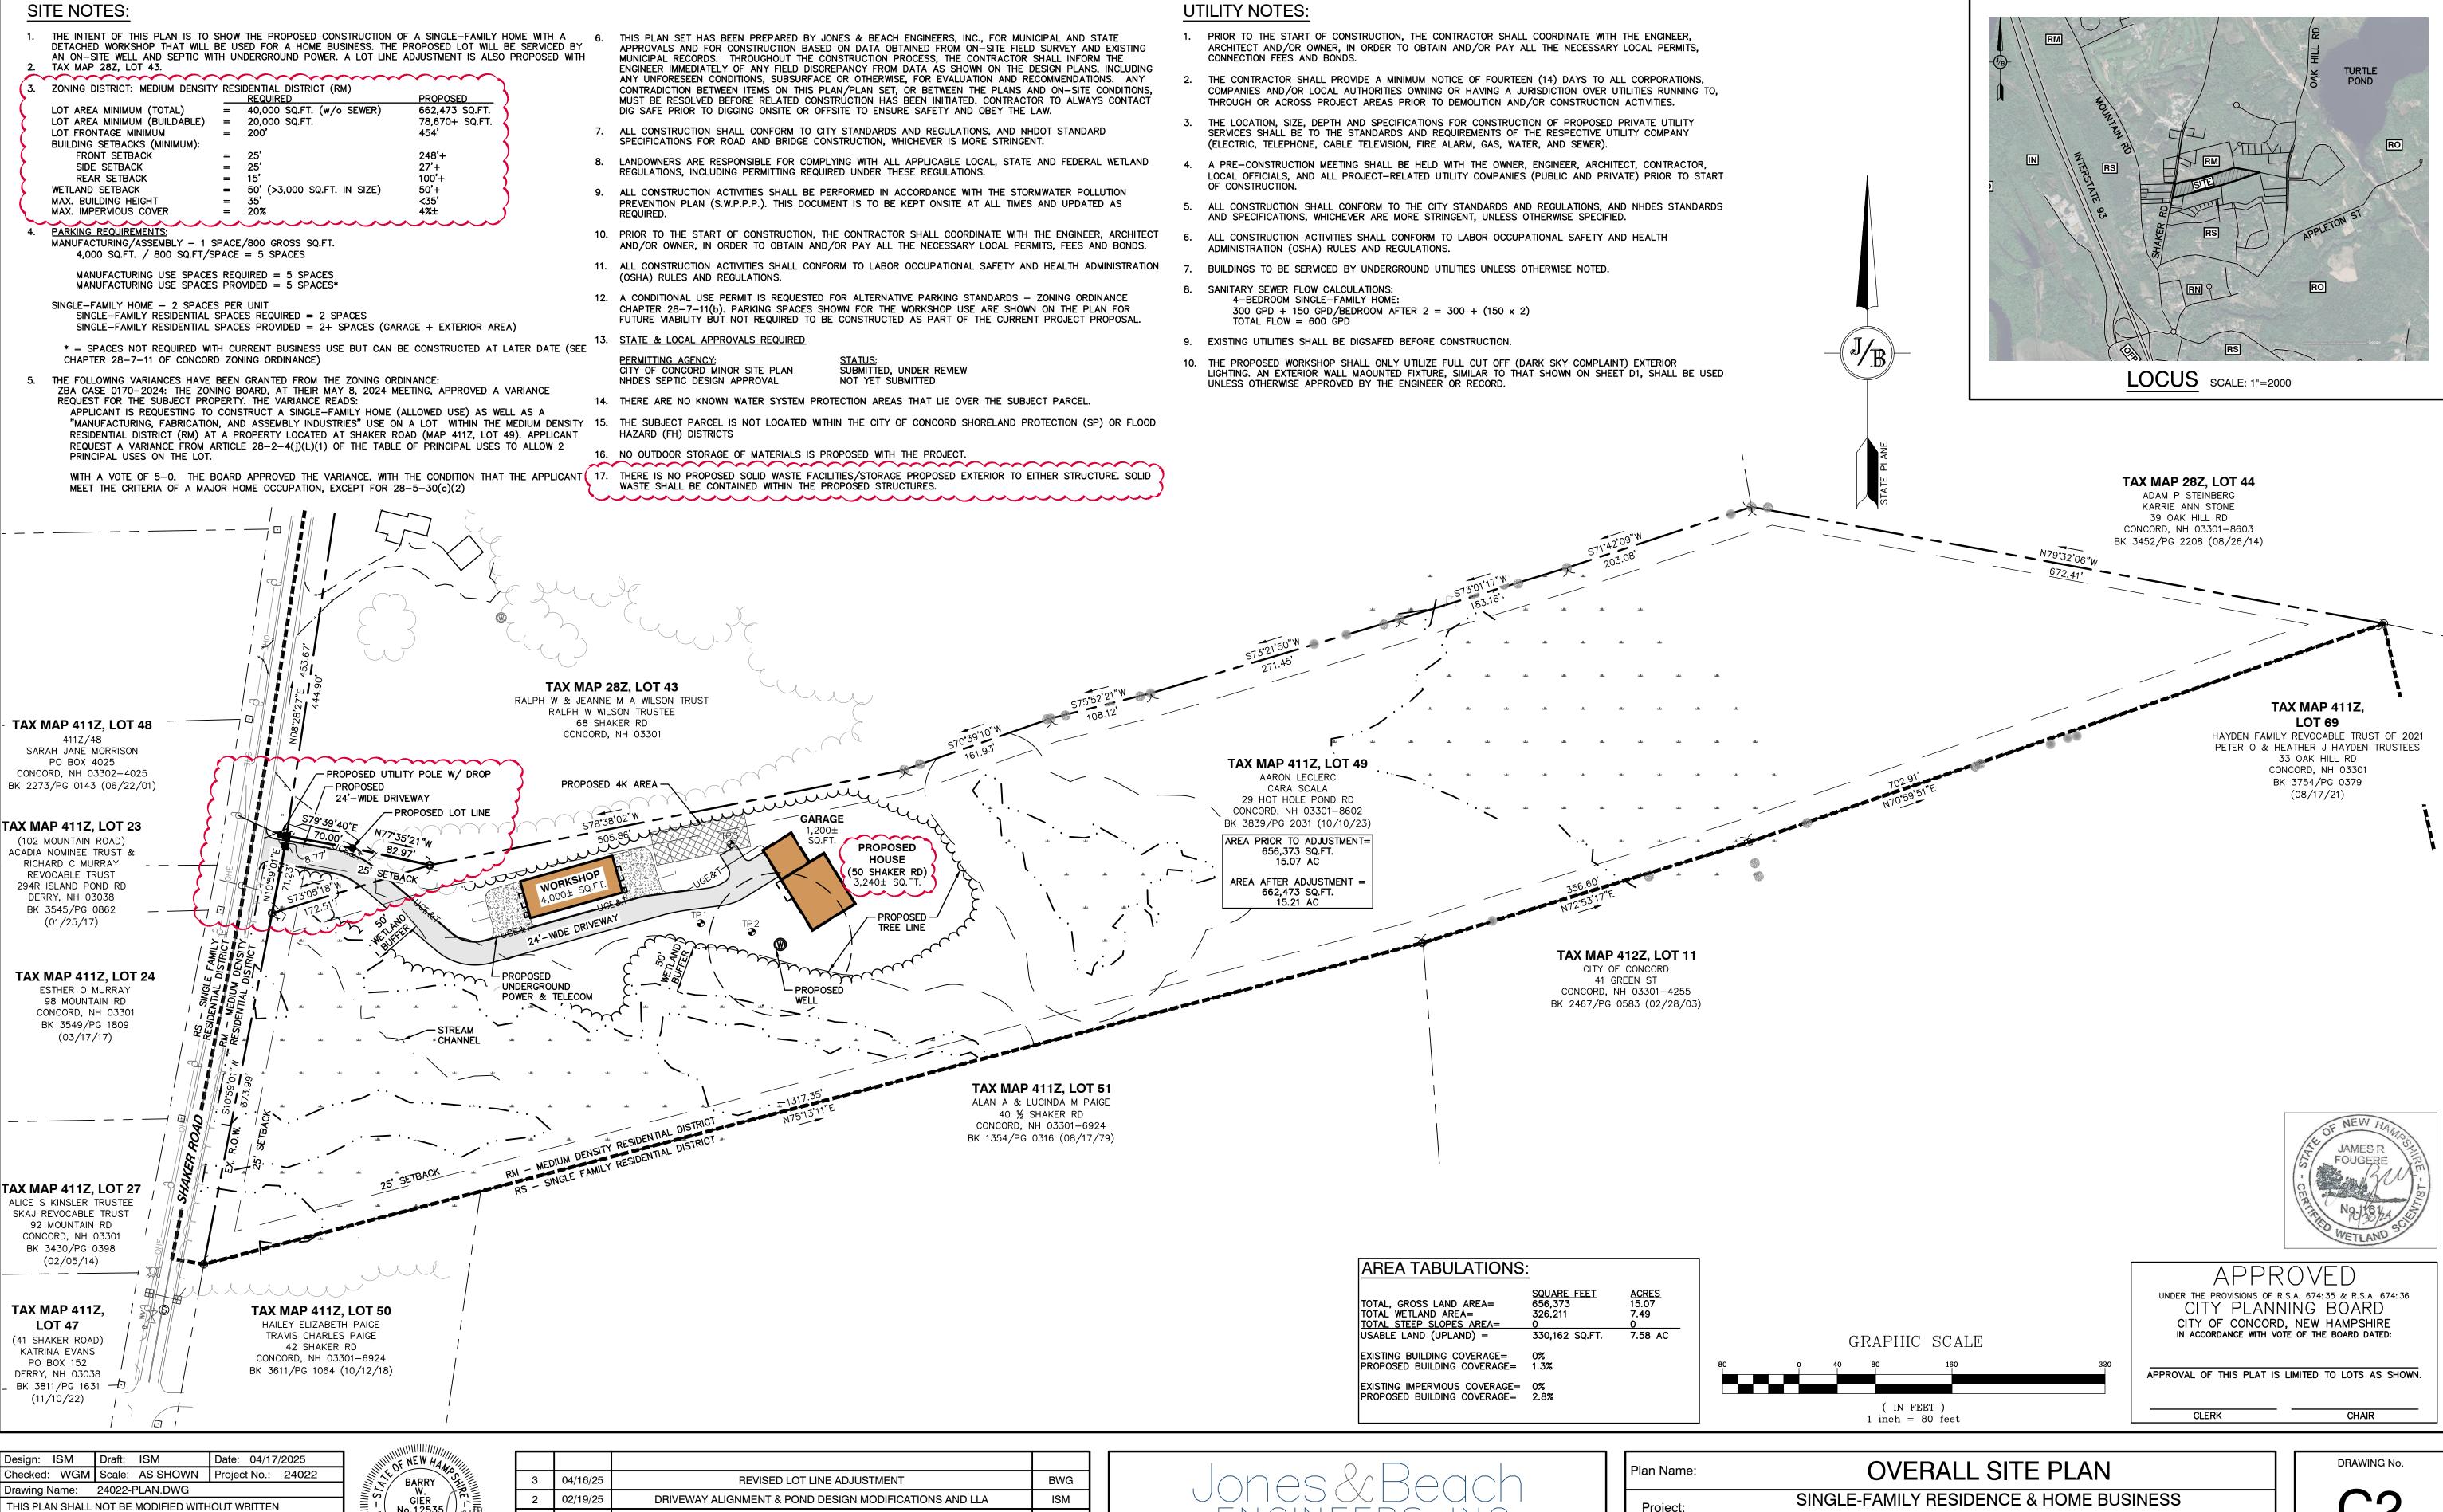
3	04/16/25	REVISED LOT LINE ADJUSTMENT	BWG
2	02/19/25	DRIVEWAY ALIGNMENT & POND DESIGN MODIFICATIONS AND LLA	ISM
1	12/18/24	REVISIONS PER PLANNING STAFF AND ENGINEERING COMMENTS	ISM
0	10/16/24	ISSUED FOR PLANNING BOARD REVIEW	ISM
REV.	DATE	REVISION	BY

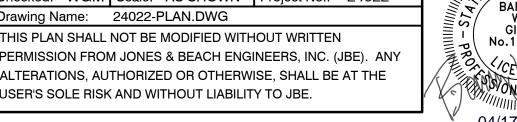


Plan Name:	COVER SHEET
Project:	SINGLE-FAMILY RESIDENCE & HOME BUSINESS 50 & 68 SHAKER ROAD, CONCORD, NH
Owner of Record:	AARON LECLERC & CARA SCALA 29 HOT HOLE ROAD, CONCORD, NH 03301









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No.12535 12/18/24 REVISIONS PER PLANNING STAFF AND ENGINEERING COMMENTS ISSUED FOR PLANNING BOARD REVIEW 10/16/24 REV. DATE **REVISION** 04/17/2025

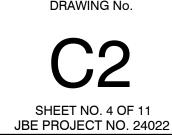
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ENGINEERS INC.
85 Portsmouth Avenue, PO Box 219, Stratham, NH 03885 603.772.4746 — JonesandBeach.com

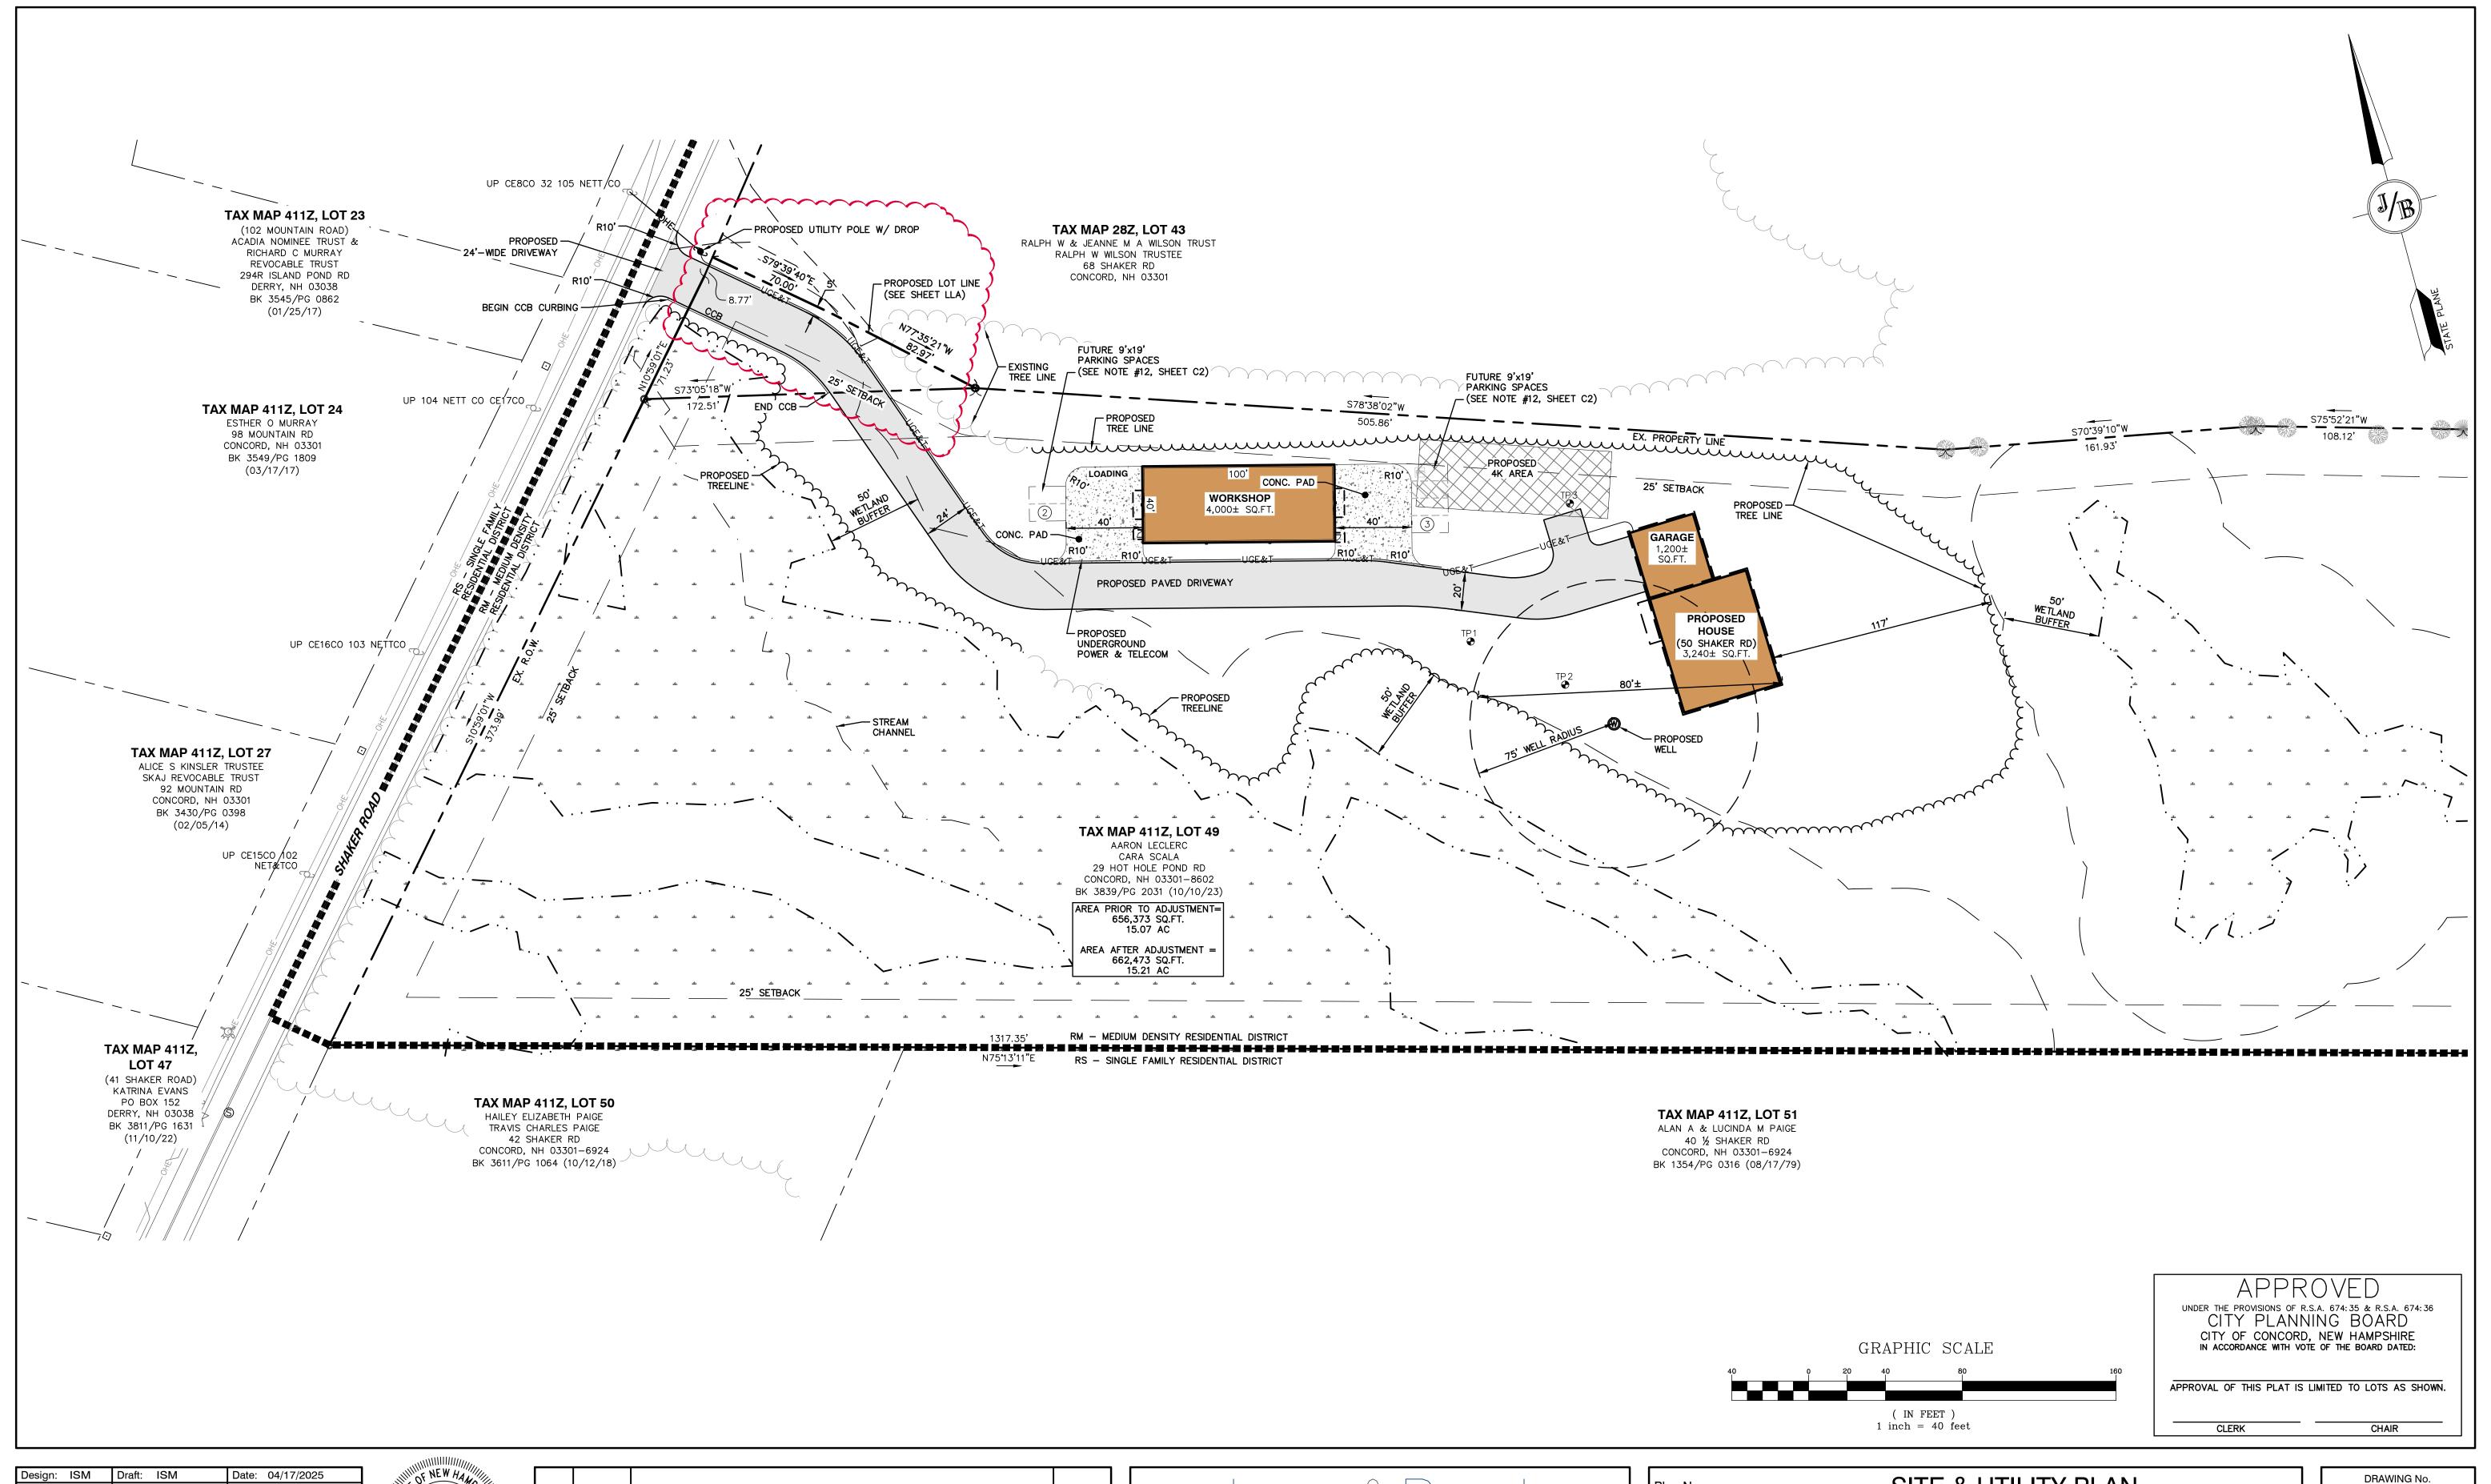
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Plan Name:	OVERALL SITE PLAN
Project:	SINGLE-FAMILY RESIDENCE & HOME BUSINESS 50 & 68 SHAKER ROAD, CONCORD, NH
Owner of Record:	AARON LECLERC & CARA SCALA 29 HOT HOLE ROAD, CONCORD, NH 03301





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BARRY W.
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04/17/2025

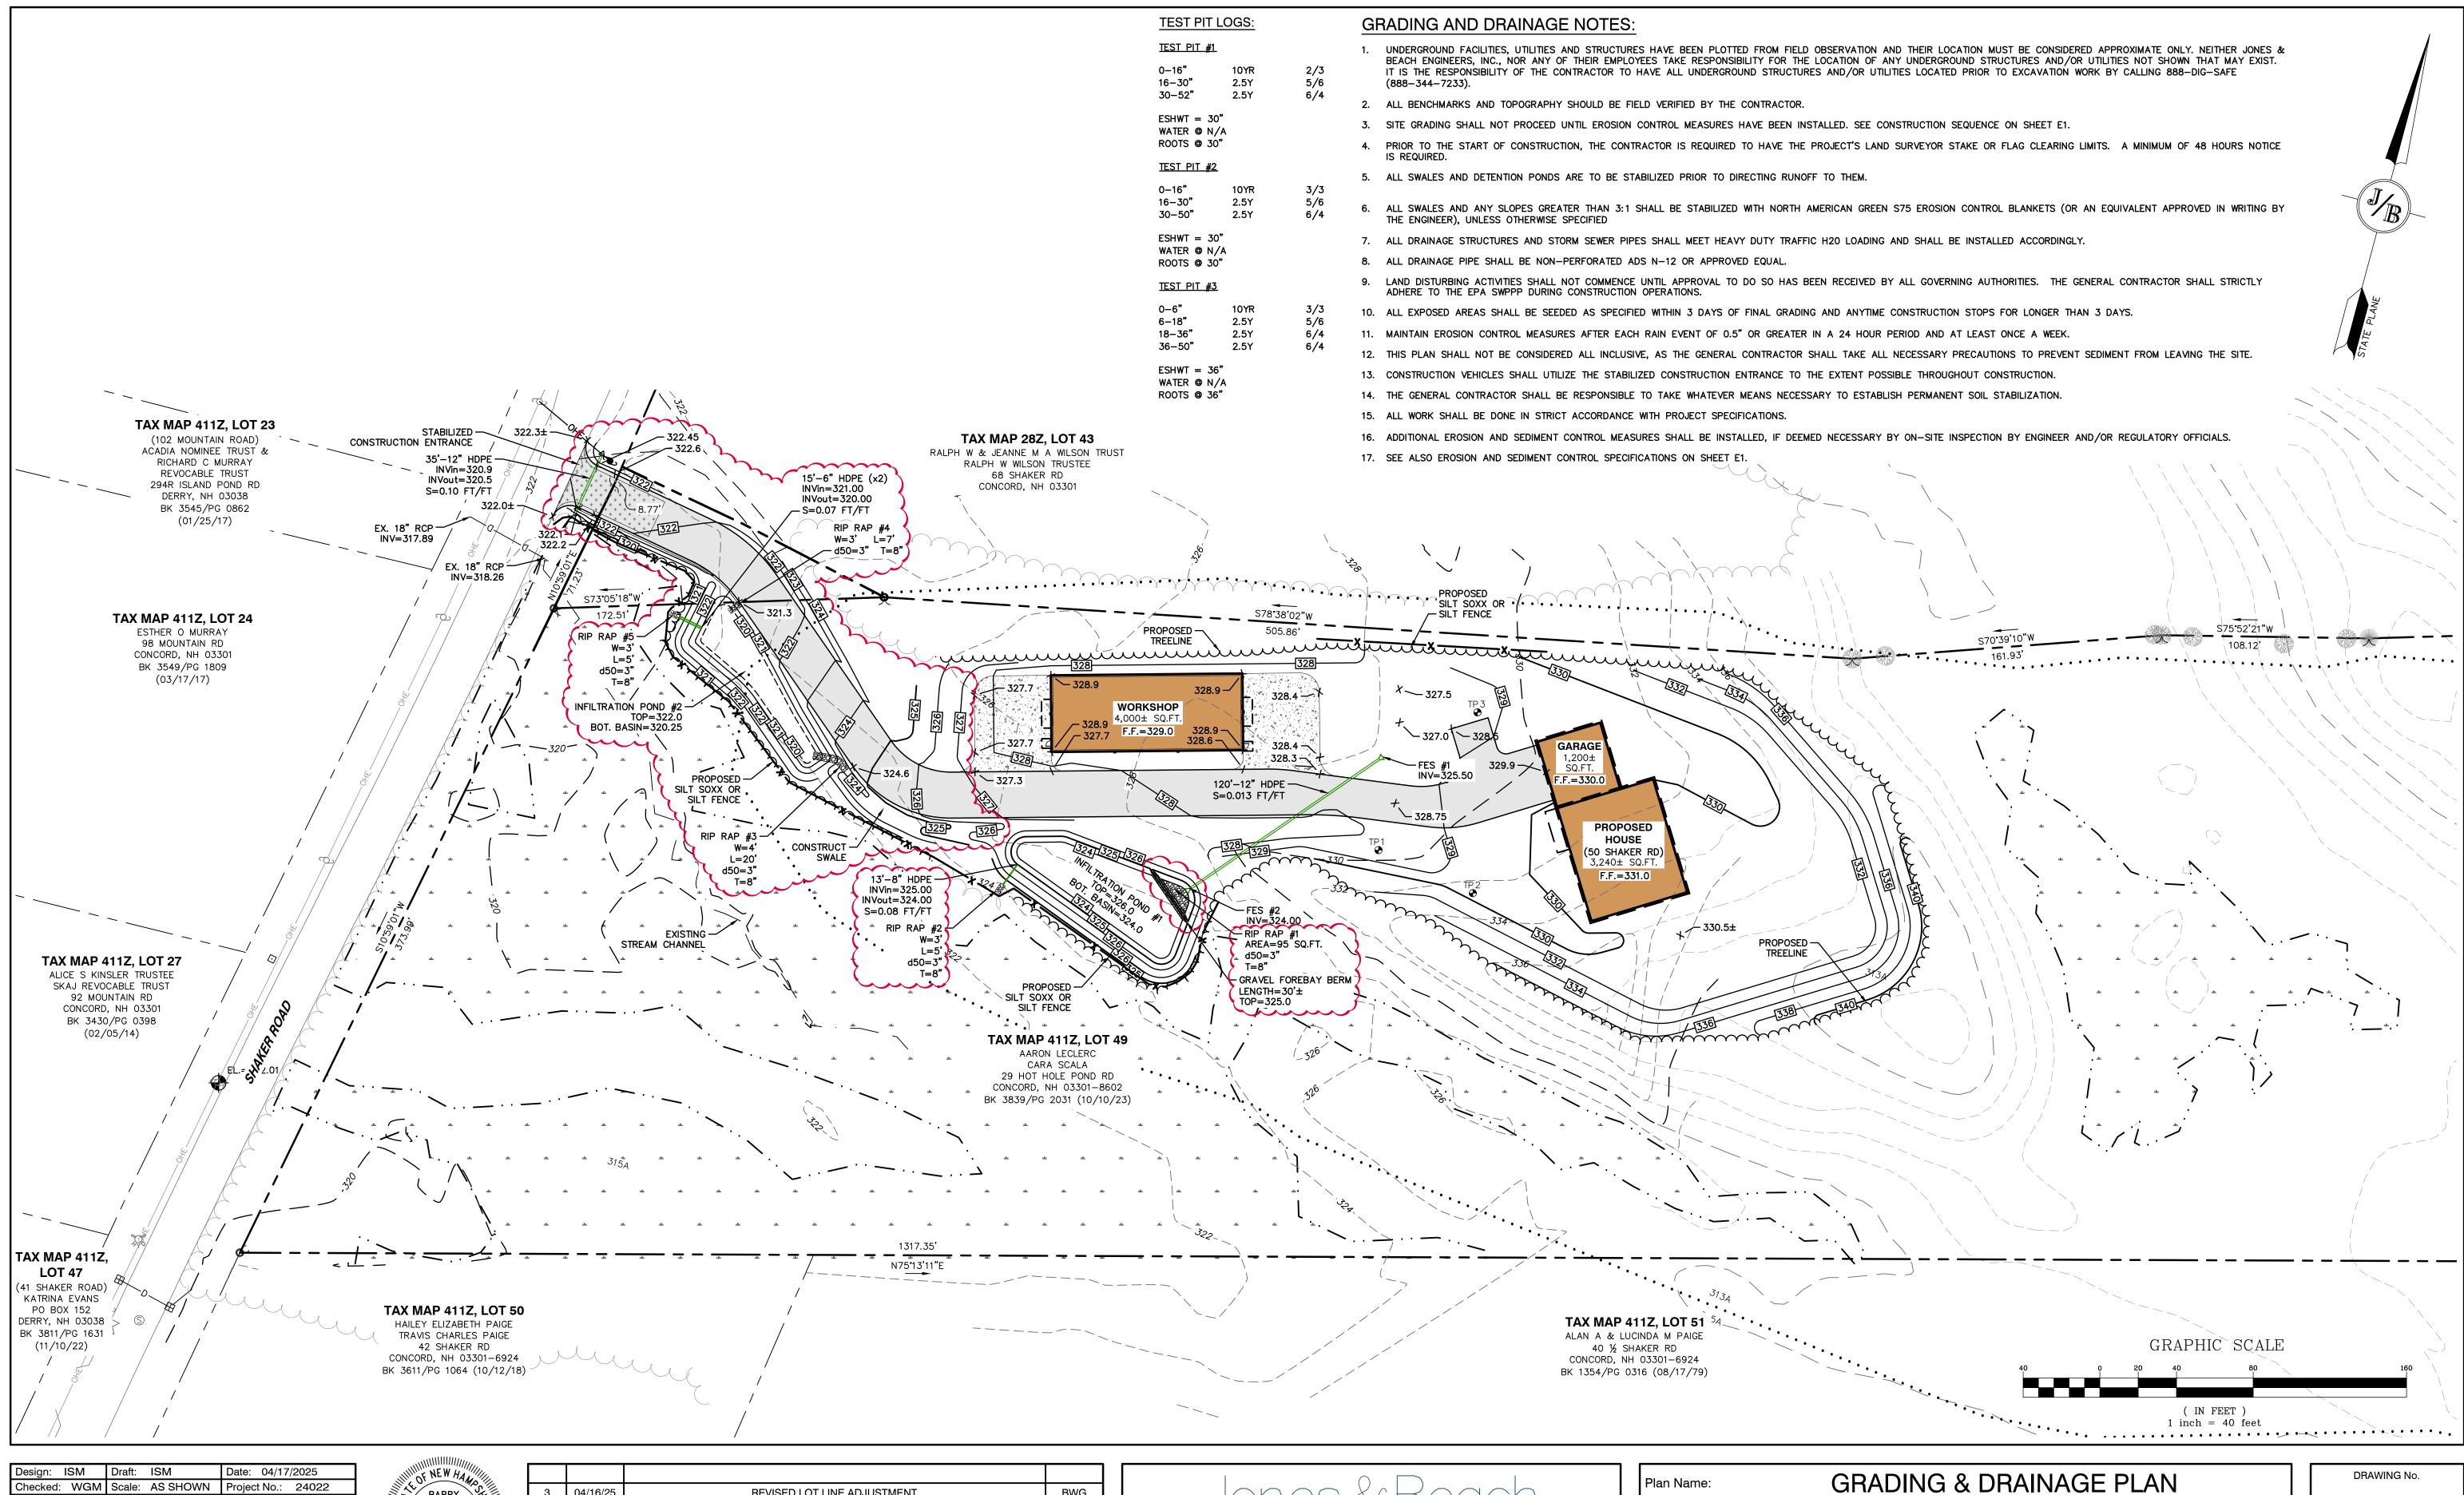
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Plan Name:	SITE & UTILITY PLAN
Project:	SINGLE-FAMILY RESIDENCE & HOME BUSINESS 50 & 68 SHAKER ROAD, CONCORD, NH
Owner of Record:	AARON LECLERC & CARA SCALA 29 HOT HOLE ROAD, CONCORD, NH 03301

C2.1

SHEET NO. 5 OF 11
JBE PROJECT NO. 24022



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Drawing Name: 24022-PLAN.DWG

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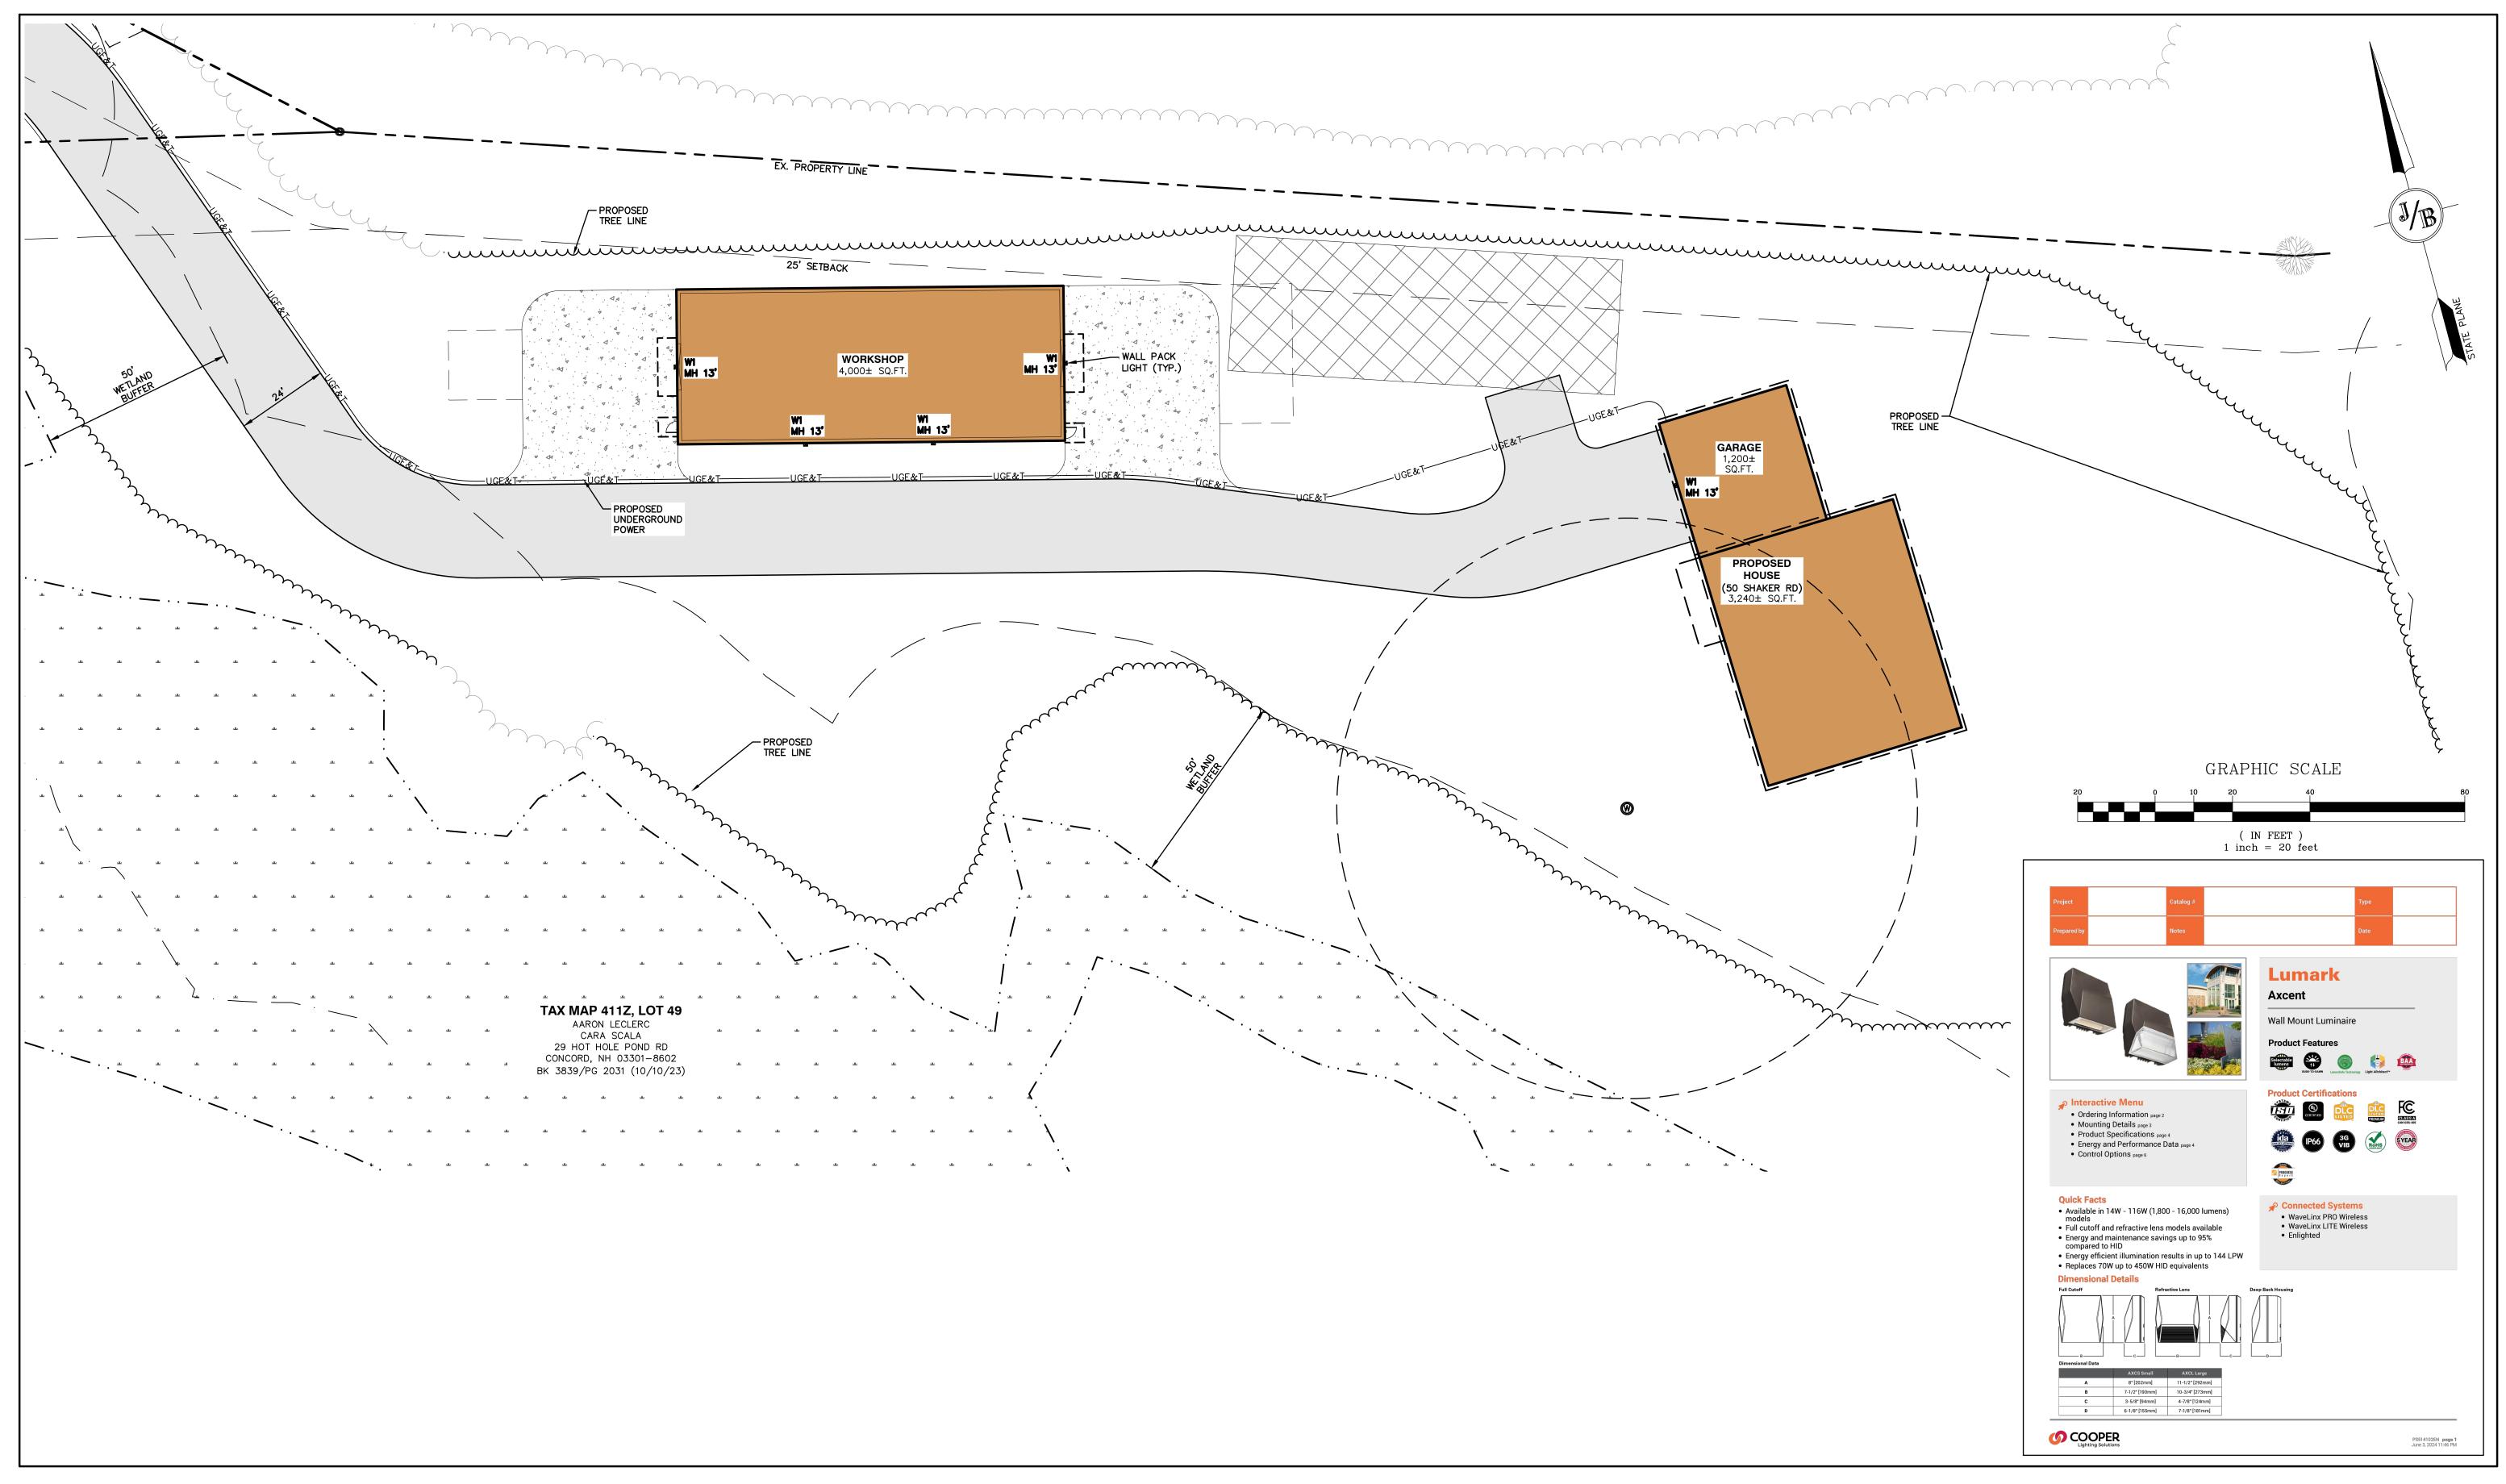
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	0	10/16/24	ISSUED FOR PLANNING BOARD REVIEW	ISM
	REV.	DATE	REVISION	BY



Plan Name:	GRADING & DRAINAGE PLAN
Project:	SINGLE-FAMILY RESIDENCE & HOME BUSINESS 50 & 68 SHAKER ROAD, CONCORD, NH
Owner of Record:	AARON LECLERC & CARA SCALA 29 HOT HOLE ROAD, CONCORD, NH 03301

C3.1

SHEET NO. 6 OF 11
JBE PROJECT NO. 24022



Design: ISM	Draft: ISM	Date: 04/17/2025
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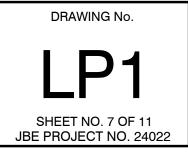
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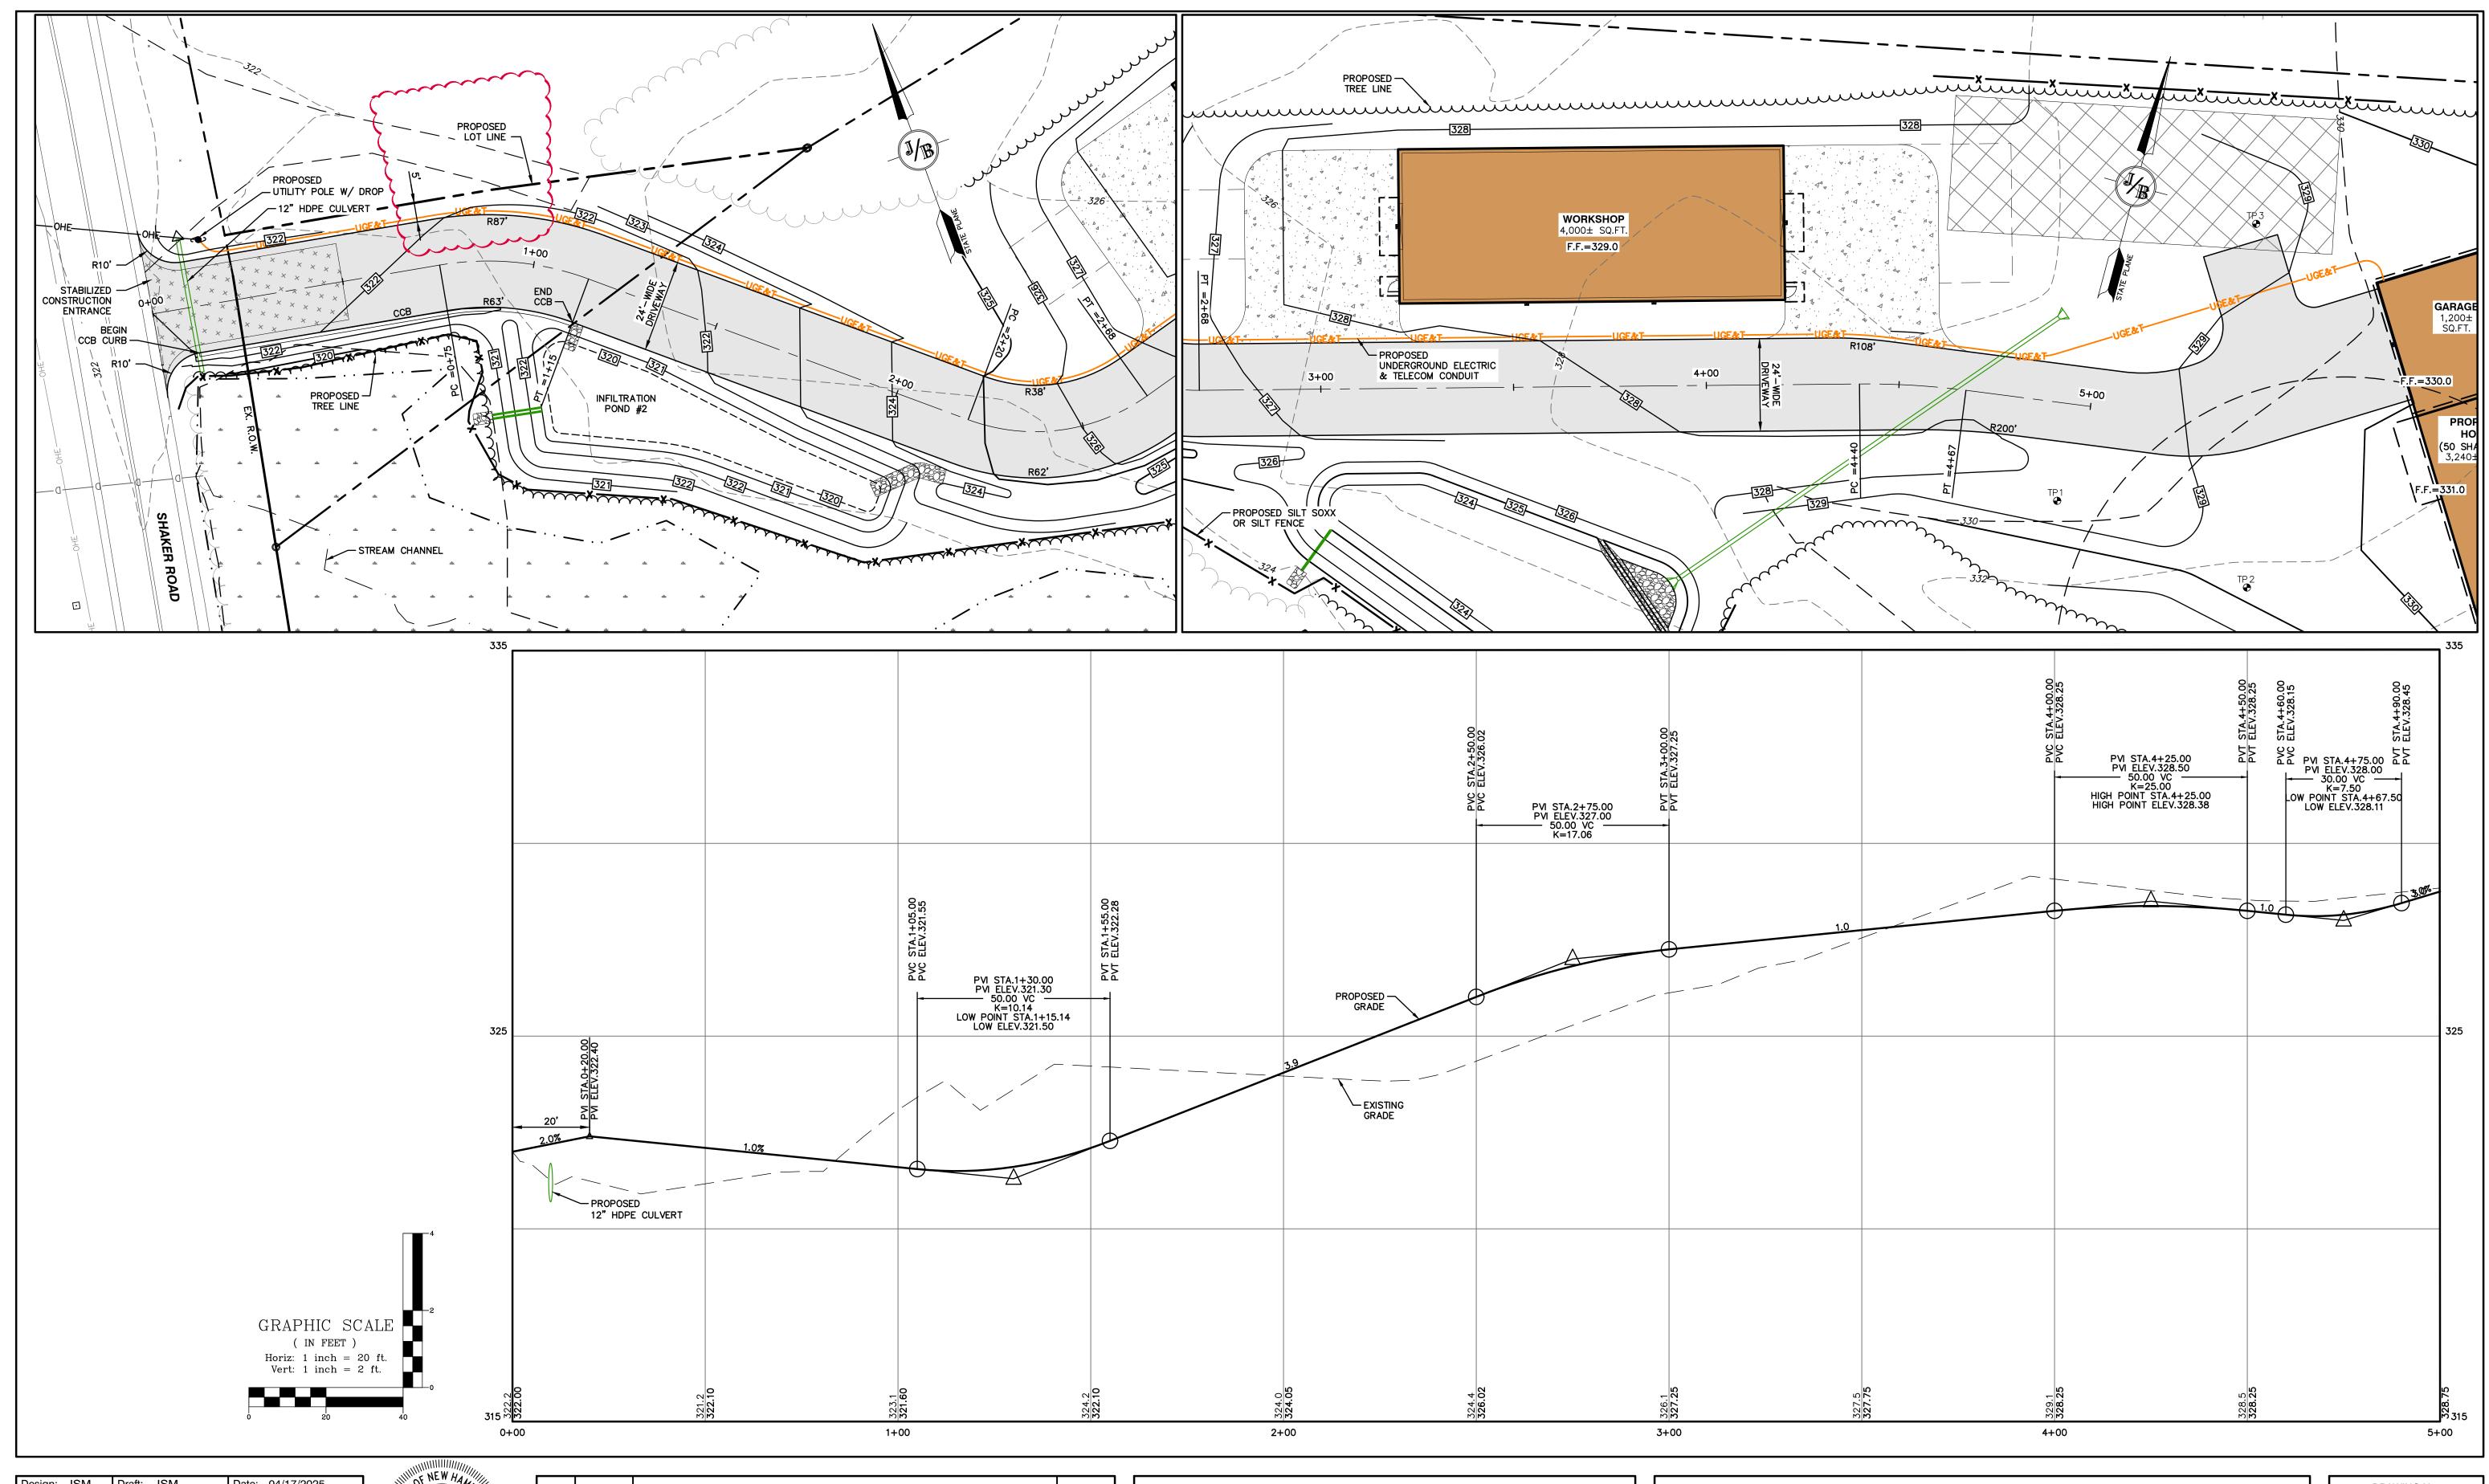
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Plan Name:	LIGHTING PLAN
Project:	SINGLE-FAMILY RESIDENCE & HOME BUSINESS 50 & 68 SHAKER ROAD, CONCORD, NH
Owner of Record:	AARON LECLERC & CARA SCALA 29 HOT HOLE ROAD, CONCORD, NH 03301





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GIER No.12535	2	02/19/25	DRIVEWAY ALIGNMENT & POND DESIGN MODIFICATIONS AND LLA
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04/17/2025	REV.	DATE	REVISION
04/17/2023			

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BWG

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Plan Name:	DRIVEWAY PLAN & PROFILE
Project:	SINGLE-FAMILY RESIDENCE & HOME BUSINESS 50 & 68 SHAKER ROAD, CONCORD, NH
Owner of Record:	AARON LECLERC & CARA SCALA 29 HOT HOLE ROAD, CONCORD, NH 03301

DRAWING No. SHEET NO. 8 OF 11 JBE PROJECT NO. 24022

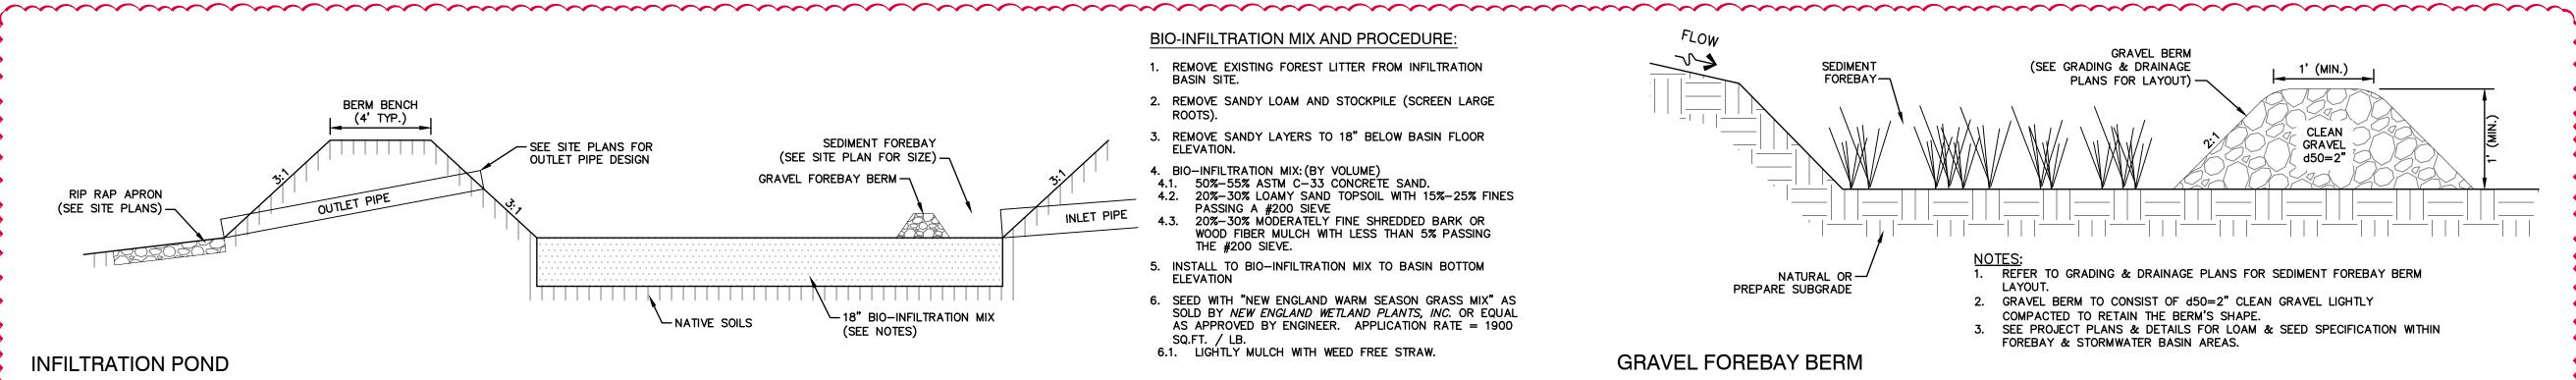
## BERM BENCH (4' TYP.) SEDIMENT FOREBAY - SEE SITE PLANS FOR (SEE SITE PLAN FOR SIZE) -OUTLET PIPE DESIGN GRAVEL FOREBAY BERM-RIP RAP APRON OUTLET PIPE (SEE SITE PLANS) **18"** BIO−INFILTRATION MIX - NATIVE SOILS (SEE NOTES) INFILTRATION POND

### **BIO-INFILTRATION MIX AND PROCEDURE:**

- 1. REMOVE EXISTING FOREST LITTER FROM INFILTRATION BASIN SITE.
- 2. REMOVE SANDY LOAM AND STOCKPILE (SCREEN LARGE
- 3. REMOVE SANDY LAYERS TO 18" BELOW BASIN FLOOR
- 4. BIO-INFILTRATION MIX: (BY VOLUME)

THE #200 SIEVE.

- 4.1. 50%-55% ASTM C-33 CONCRETE SAND. 4.2. 20%-30% LOAMY SAND TOPSOIL WITH 15%-25% FINES PASSING A #200 SIEVE 4.3. 20%-30% MÖDERATELY FINE SHREDDED BARK OR WOOD FIBER MULCH WITH LESS THAN 5% PASSING
- 5. INSTALL TO BIO-INFILTRATION MIX TO BASIN BOTTOM
- 6. SEED WITH "NEW ENGLAND WARM SEASON GRASS MIX" AS SOLD BY NEW ENGLAND WETLAND PLANTS, INC. OR EQUAL AS APPROVED BY ENGINEER. APPLICATION RATE = 1900 SQ.FT. / LB.
- 6.1. LIGHTLY MULCH WITH WEED FREE STRAW.



NOT TO SCALE

# – PE THREADED ROD WITH WING NUTS (SEE NOTE #1) TOP VIEW SIDE<u>VIEW</u>

NOT TO SCALE

### B (MAX) 6.5" 25" 29" 1210-NP 6.5" 1510-NP 15" 6.5" 6.5" 25" 29" 7.5" 18" 6.5" 32" 1810-NP 7.5" 24" 45" 2410-NP 6.5" 36"

N/A

N/A

7.0"

7.0"

53**"** 

53**"** 

68**"** 

FRONT VIEW

3010-NP

3610-NP

1. PE THREADED ROD WITH WING NUTS PROVIDED FOR END SECTIONS 12"-24". 30" AND 36" END SECTIONS TO BE WELDED PER MANUFACTURER'S RECOMMENDATIONS.

10.5**"** 

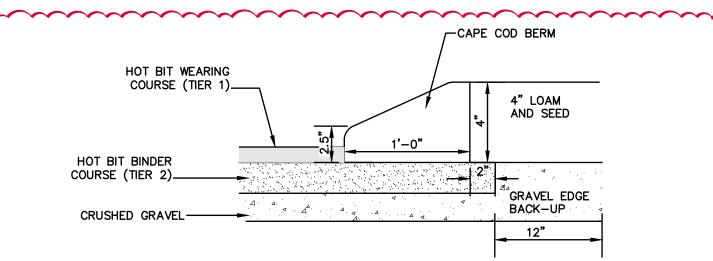
10.5**"** 

2. ALL DIMENSIONS ARE NOMINAL.

30**"** 

### ADS N-12 FLARED END SECTION

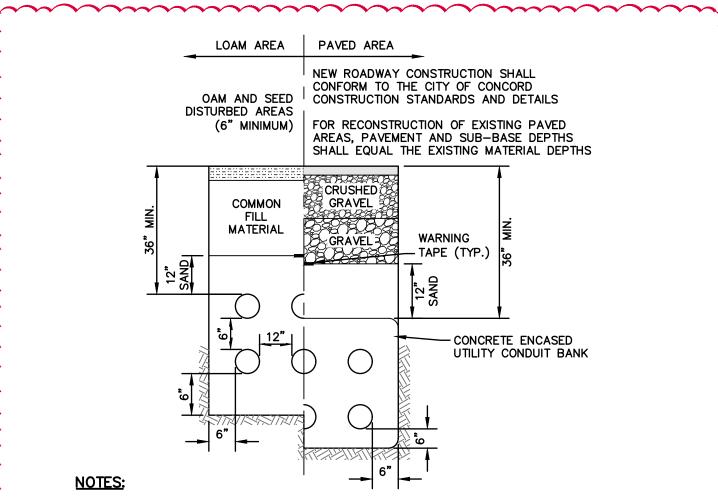
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THE CAPE COD BERM IS TO BE CONSTRUCTED OF A POLYFIBER CURB MIX CONTAINING 59.2% SAND, 27.6% 3/8" STONE, 9.2% 1/2" STONE, 0.3% FIBERS, AND 3.0% ASPHALT.

### CAPE COD BERM

NOT TO SCALE

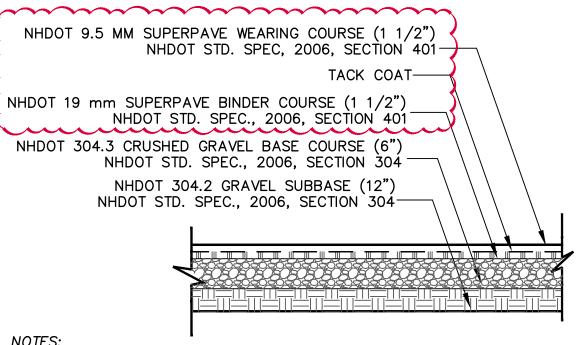


- 1. UNDERGROUND CONDUIT INSTALLATIONS SHALL BE COORDINATED WITH ALL LOCAL UTILITIES INCLUDING ELECTRIC, TELEPHONE, GAS, CABLE, STEAM, AND CITY OF CONCORD FIRE
- ALARM/SIGNAL AND ENGINEER SERVICES DIVISION. 2. CONDUIT CROSSINGS SHALL BE SWEEPS AT RIGHT ANGLES TO THE STREET. 90° BENDS ARE NOT ACCEPTABLE.

3. PROPOSED CONDUITS WITHIN PAVED SECTIONS OF STREETS SHALL BE RIGID METAL OR SCH 80 PVC CONDUIT. WHEN THE PROPER DEPTH CANNOT BE ACHIEVED, SCH 40 CONDUIT ENCASED IN CONCRETE SHALL BE USED.

### **UTILITY TRENCH**

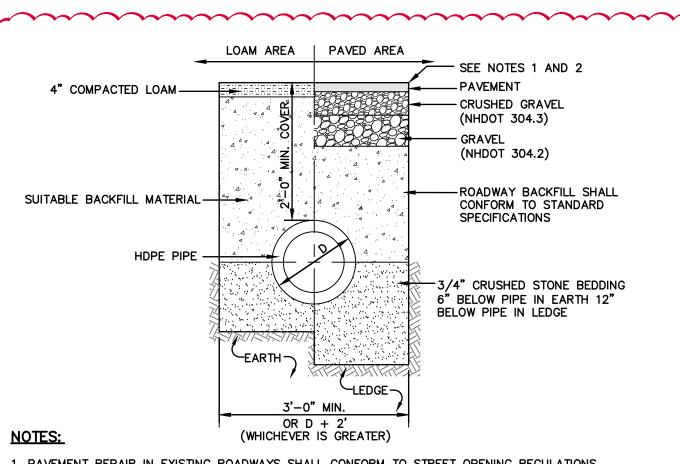
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- 1. PAVEMENT SUBGRADES SHOULD BE PROOF ROLLED IN ORDER TO DENSIFY THE SUBGRADES USING A MINIMUM OF 4 PASSES WITH A 10-TON VIBRATORY DRUM COMPACTOR. THE GRAVEL BORROW SUBGRADE COURSE AND CRUSHED GRAVEL BASE COURSE SHOULD BE COMPACTED TO A MINIMUM OF 95% RELATIVE COMPACTION OF THE MAXIMUM DRY DENSITY AS DETERMINED BY THE STANDARD PROCTOR TEST (ASTM-D698).
- 2. PAVEMENT SECTION SUBJECT TO CHANGE BASED ON GEOTECHNICAL INVESTIGATION.

### STANDARD DUTY ASPHALT PAVEMENT SECTION

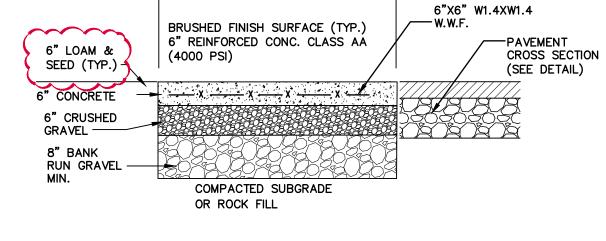
# NOT TO SCALE



- 1. PAVEMENT REPAIR IN EXISTING ROADWAYS SHALL CONFORM TO STREET OPENING REGULATIONS.
- 2. NEW ROADWAY CONSTRUCTION SHALL CONFORM WITH PROJECT AND TOWN SPECIFICATIONS.
- 3. ALL MATERIALS ARE TO BE COMPACTED TO 95% OF ASTM D-1557.

# DRAINAGE TRENCH

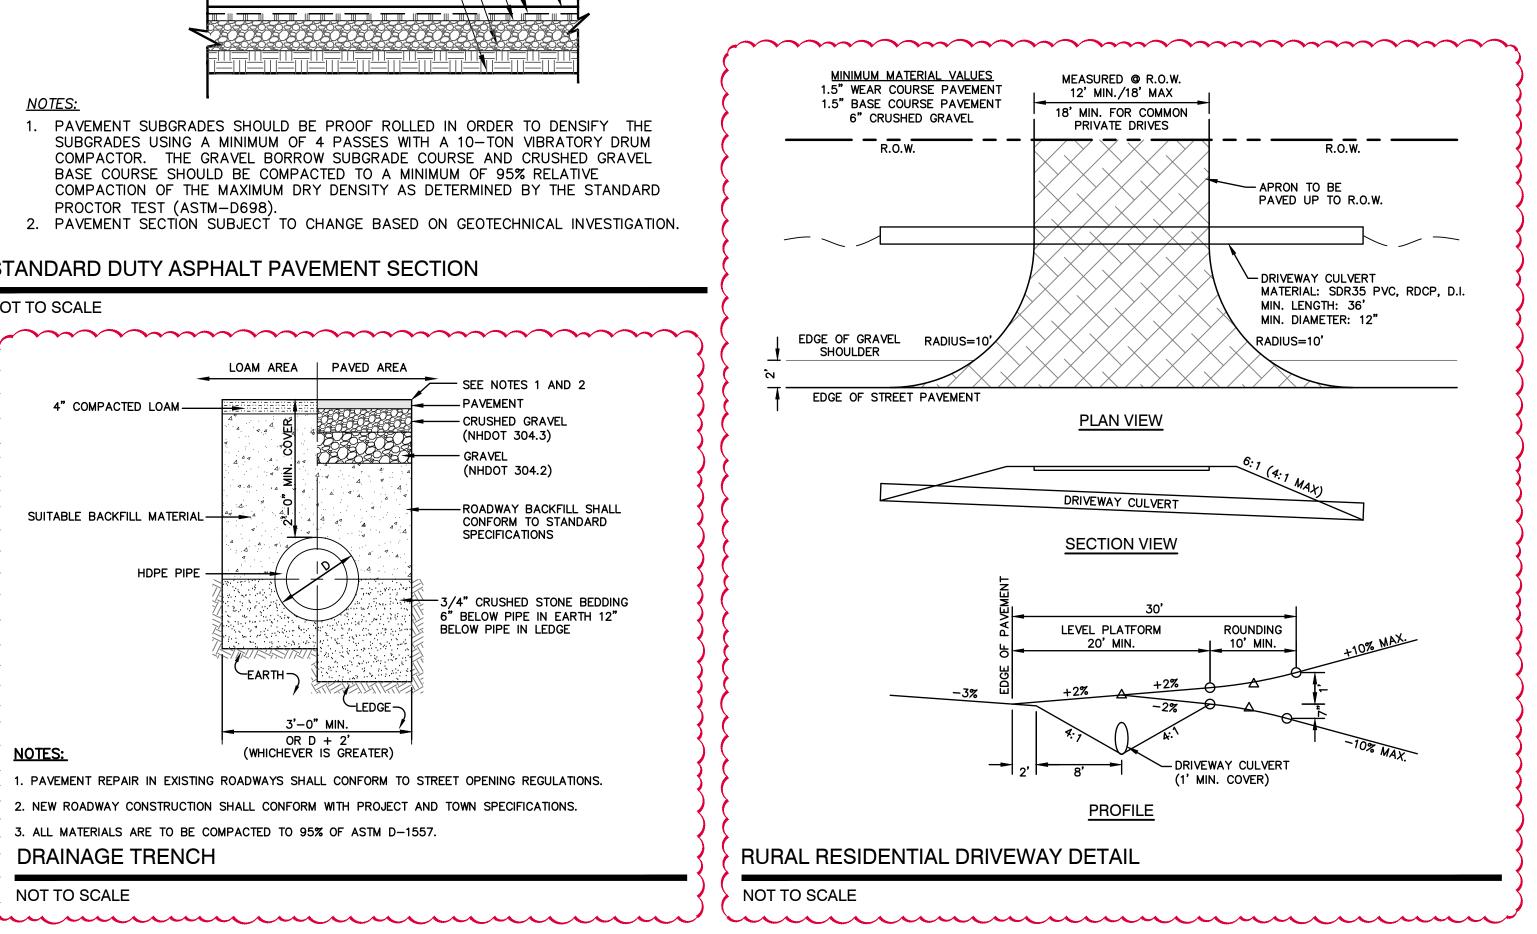
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LENGTH AND WIDTH VARIES

### CONCRETE PAD DETAIL

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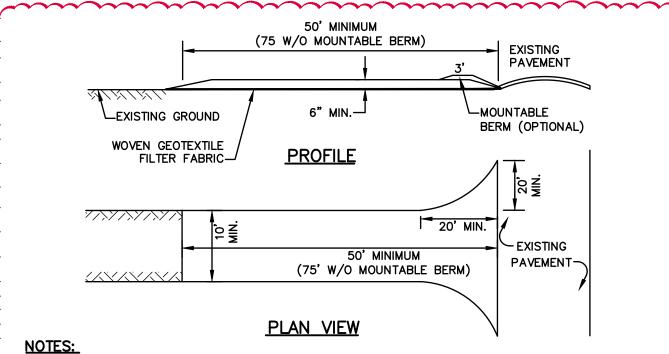


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<b>E</b> ≀	2	02/19/25	DRIVEWAY ALIGNMENT & POND DESIGN MODIFICATIONS AND LLA	ISM
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Plan Name:	DETAIL SHEET	
Project:	SINGLE-FAMILY RESIDENCE & HOME BUSINESS 50 & 68 SHAKER ROAD, CONCORD, NH	
Owner of Record:	AARON LECLERC & CARA SCALA 29 HOT HOLE ROAD, CONCORD, NH 03301	

DRAWING No. JBE PROJECT NO. 24022



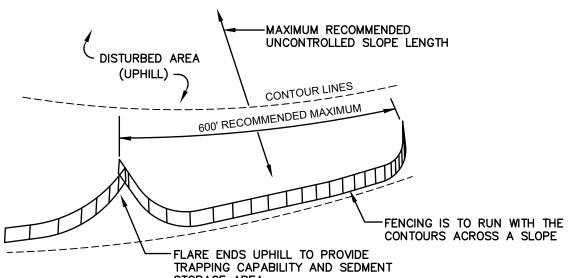
- 1. STONE FOR STABILIZED CONSTRUCTION ENTRANCE SHALL BE 3 INCH COURSE AGGREGATE 2. THE LENGTH OF THE STABILIZED ENTRANCE SHALL NOT BE LESS THAN 50 FEET, 75' WITHOUT A
- MOUNTABLE BERM, AND EXCEPT FOR A SINGLE RESIDENTIAL LOT WHERE A 30 FOOT MINIMUM LENGTH WOULD APPLY. THICKNESS OF THE STONE FOR THE STABILIZED ENTRANCE SHALL NOT BE LESS THAN 6 INCHES.
- 4. THE WIDTH OF THE ENTRANCE SHALL NOT BE LESS THAN THE FULL WIDTH OF THE ENTRANCE WHERE INGRESS OR EGRESS OCCURS, OR 10 FEET, WHICHEVER IS GREATER.
- 5. GEOTEXTILE FILTER FABRIC SHALL BE PLACED OVER THE ENTIRE AREA PRIOR TO PLACING THE
- 6. ALL SURFACE WATER THAT IS FLOWING TO OR DIVERTED TOWARD THE CONSTRUCTION ENTRANCE
- SHALL BE PIPED BENEATH THE ENTRANCE. IF PIPING IS IMPRACTICAL, A STONE BERM WITH 5:1 SLOPES THAT CAN BE CROSSED BY VEHICLES MAY BE SUBSTITUTED FOR THE PIPE. 7. THE ENTRANCE SHALL BE MAINTAINED IN A CONDITION THAT WILL PREVENT TRACKING OR FLOWING OF SEDIMENT ONTO THE PUBLIC RIGHT-OF-WAY. THIS MAY REQUIRE PERIODIC TOP DRESSING WITH ADDITIONAL STONE AS CONDITIONS DEMAND AND REPAIR AND/OR CLEAN OUT OF ANY MEASURES

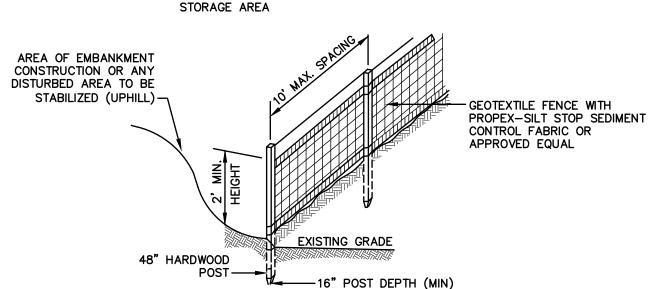
USED TO TRAP SEDIMENT. ALL SEDIMENT SPILLED, WASHED, OR TRACKED ONTO THE PUBLIC

RIGHT-OF-WAY MUST BE REMOVED PROMPTLY. 8. PERIODIC INSPECTION AND NEEDED MAINTENANCE SHALL BE PROVIDED AFTER EACH RAIN.

### STABILIZED CONSTRUCTION ENTRANCE

NOT TO SCALE





# **CONSTRUCTION SPECIFICATIONS:**

- 1. WOVEN FABRIC FENCE TO BE FASTENED SECURELY TO FENCE POSTS WITH WIRE TIES OR STAPLES. FILTER CLOTH SHALL BE FASTENED TO WOVEN WIRE EVERY 24" AT TOP, MID AND BOTTOM AND EMBEDDED IN THE GROUND A MINIMUM OF 8" AND THEN COVERED WITH SOIL.
- 2. THE FENCE POSTS SHALL BE A MINIMUM OF 48" LONG, SPACED A MAXIMUM 10' APART, AND DRIVEN A MINIMUM OF 16" INTO THE GROUND.
- 3. WHEN TWO SECTIONS OF FILTER CLOTH ADJOIN EACH OTHER, THE ENDS OF THE FABRIC SHALL BE OVERLAPPED 6". FOLDED AND STAPLED TO PREVENT SEDIMENT FROM BY-PASSING.
- 4. MAINTENANCE SHALL BE PERFORMED AS NEEDED AND SEDIMENT REMOVED AND PROPERLY DISPOSED OF WHEN IT IS 6" DEEP OR VISIBLE 'BULGES' DEVELOP IN THE SILT FENCE.
- 5. PLACE THE ENDS OF THE SILT FENCE UP CONTOUR TO PROVIDE FOR SEDIMENT STORAGE.
- 6. SILT FENCES SHALL BE REMOVED WHEN NO LONGER NEEDED AND THE SEDIMENT COLLECTED SHALL BE DISPOSED AS DIRECTED BY THE ENGINEER. THE AREA DISTURBED BY THE REMOVAL SHALL BE

### MAINTENANCE:

- 1. SILT FENCES SHALL BE INSPECTED IMMEDIATELY AFTER EACH RAINFALL AND AT LEAST DAILY DURING PROLONGED RAINFALL. ANY REPAIRS THAT ARE REQUIRED SHALL BE DONE IMMEDIATELY.
- 2. IF THE FABRIC ON A SILT FENCE SHOULD DECOMPOSE OR BECOME INEFFECTIVE DURING THE EXPECTED LIFE OF THE FENCE, THE FABRIC SHALL BE REPLACED PROMPTLY.
- 3. SEDIMENT DEPOSITS SHOULD BE INSPECTED AFTER EVERY STORM EVENT. THE DEPOSITS SHOULD BE REMOVED WHEN THEY REACH APPROXIMATELY ONE HALF THE HEIGHT OF THE BARRIER.
- 4. SEDIMENT DEPOSITS THAT ARE REMOVED, OR LEFT IN PLACE AFTER THE FABRIC HAS BEEN REMOVED. SHALL BE GRADED TO CONFORM WITH THE EXISTING TOPOGRAPHY AND VEGETATED.

### SILT FENCE

NOT TO SCALE

### TEMPORARY EROSION CONTROL NOTES

- 1. THE SMALLEST PRACTICAL AREA OF LAND SHALL BE EXPOSED AT ANY ONE TIME. AT NO TIME SHALL AN AREA IN EXCESS OF 5 ACRES BE EXPOSED AT ANY ONE TIME BEFORE DISTURBED AREAS ARE STABILIZED.
- 2. EROSION, SEDIMENT AND DETENTION MEASURES SHALL BE INSTALLED AS SHOWN ON THE PLANS AND AT LOCATIONS AS REQUIRED, DIRECTED BY THE ENGINEER.
- ALL DISTURBED AREAS (INCLUDING POND AREAS BELOW THE PROPOSED WATERLINE) SHALL BE RETURNED TO PROPOSED GRADES AND ELEVATIONS. DISTURBED AREAS SHALL BE LOAMED WITH A MINIMUM OF 6" OF SCREENED ORGANIC LOAM AND SEEDED WITH SEED MIXTURE 'C' AT A RATE NOT LESS THAN 1.10 POUNDS OF SEED PER 1,000 S.F. OF AREA (48 LBS. / ACRE).
- 4. SILT FENCES AND OTHER BARRIERS SHALL BE INSPECTED EVERY SEVEN CALENDAR DAYS AND WITHIN 24 HOURS OF A RAINFALL OF 0.5" OR GREATER. ALL DAMAGED AREAS SHALL BE REPAIRED, AND SEDIMENT DEPOSITS SHALL PERIODICALLY BE REMOVED AND DISPOSED OF.
- 5. AFTER ALL DISTURBED AREAS HAVE BEEN STABILIZED, THE TEMPORARY EROSION CONTROL MEASURES SHALL BE REMOVED AND THE AREA DISTURBED BY THE REMOVAL SMOOTHED AND RE-VEGETATED.
- AREAS MUST BE SEEDED AND MULCHED OR OTHERWISE PERMANENTLY STABILIZED WITHIN 3 DAYS OF FINAL GRADING, OR TEMPORARILY STABILIZED WITHIN 14 DAYS OF THE INITIAL DISTURBANCE OF SOIL. ALL AREAS SHALL BE STABILIZED WITHIN 45 DAYS OF INITIAL DISTURBANCE.
- ALL PROPOSED VEGETATED AREAS THAT DO NOT EXHIBIT A MINIMUM OF 85 PERCENT VEGETATIVE GROWTH BY OCTOBER 15, OR WHICH ARE DISTURBED AFTER OCTOBER 15, SHALL BE STABILIZED BY SEEDING AND INSTALLING NORTH AMERICAN GREEN S75 EROSION CONTROL BLANKETS (OR AN EQUIVALENT APPROVED IN WRITING BY THE ENGINEER) ON SLOPES GREATER THAN 3:1, AND SEEDING AND PLACING 3 TO 4 TONS OF MULCH PER ACRE, SECURED WITH ANCHORED NETTING, ELSEWHERE. THE INSTALLATION OF EROSION CONTROL BLANKETS OR MULCH AND NETTING SHALL NOT OCCUR OVER ACCUMULATED SNOW OR ON FROZEN GROUND AND SHALL BE COMPLETED IN
- ALL DITCHES OR SWALES WHICH DO NOT EXHIBIT A MINIMUM OF 85 PERCENT VEGETATIVE GROWTH BY OCTOBER 15, OR WHICH ARE DISTURBED AFTER OCTOBER 15, SHALL BE STABILIZED TEMPORARILY WITH STONE OR EROSION CONTROL BLANKETS APPROPRIATE FOR THE DESIGN FLOW CONDITIONS.
- AFTER OCTOBER 15th, INCOMPLETE ROAD OR PARKING SURFACES, WHERE WORK HAS STOPPED FOR THE WINTER SEASON, SHALL BE PROTECTED WITH A MINIMUM OF 3" OF CRUSHED GRAVEL PER NHDOT ITEM 304.3.
- 10. AN AREA SHALL BE CONSIDERED STABLE IF ONE OF THE FOLLOWING HAS OCCURRED:
  - BASE COURSE GRAVELS HAVE BEEN INSTALLED IN AREAS TO BE PAVED;
  - b. A MINIMUM OF 85% VEGETATED GROWTH HAS BEEN ESTABLISHED;
  - c. A MINIMUM OF 3" OF NON-EROSIVE MATERIAL SUCH STONE OR RIPRAP HAS BEEN INSTALLED; OR
  - d. EROSION CONTROL BLANKETS HAVE BEEN PROPERLY INSTALLED.

BLOWN /PLACED FILTER MEDIA ™-

WATER FLOW

FILTREXX® SILT SOXX™

NOT TO SCALE

WORK AREA

- 11. FUGITIVE DUST CONTROL IS REQUIRED TO BE CONTROLLED IN ACCORDANCE WITH ENV-A 1000, AND THE PROJECT IS TO MEET THE REQUIREMENTS AND INTENT OF RSA 430:53 AND AGR 3800 RELATIVE TO INVASIVE SPECIES.
- 12. PRIOR TO BEGINNING CONSTRUCTION, THE CONTRACTOR'S NAME, ADDRESS, AND PHONE NUMBER SHALL BE SUBMITTED TO DES VIA EMAIL (SEE BELOW).
- 13. PRIOR TO CONSTRUCTION, A PHASING PLAN THAT DELINEATES EACH PHASE OF THE PROJECT SHALL BE SUBMITTED. ALL TEMPORARY SEDIMENT BASINS THAT WILL BE NEEDED FOR DEWATERING WORK AREAS SHALL BE LOCATED AND IDENTIFIED ON THIS PLAN.
- 14. IN ORDER TO ENSURE THE STABILITY OF THE SITE AND EFFECTIVE IMPLEMENTATION OF THE SEDIMENT AND EROSION CONTROL MEASURES SPECIFIED IN THE PLANS FOR THE DURATION OF CONSTRUCTION, THE CONTRACTOR SHALL BE IN STRICT COMPLIANCE WITH THE FOLLOWING INSPECTION AND MAINTENANCE REQUIREMENTS IN ADDITION TO THOSE CALLED FOR IN THE SWPPP:
  - a. A CERTIFIED PROFESSIONAL IN EROSION AND SEDIMENT CONTROL OR A PROFESSIONAL ENGINEER LICENSED IN THE STATE OF NEW HAMPSHIRE ("MONITOR") SHALL BE EMPLOYED TO INSPECT THE SITE FROM THE START OF ALTERATION OF TERRAIN ACTIVITIES UNTIL THE SITE IS IN FULL COMPLIANCE WITH THE SITE SPECIFIC PERMIT ("PERMIT").
  - b. DURING THIS PERIOD, THE MONITOR SHALL INSPECT THE SUBJECT SITE AT LEAST ONCE A WEEK, AND IF POSSIBLE, DURING ANY ½ INCH OR GREATER RAIN EVENT (I.E. ½ INCH OF PRECIPITATION OR MORE WITHIN A 24 HOUR PERIOD). IF UNABLE TO BE PRESENT DURING SUCH A STORM, THE MONITOR SHALL INSPECT THE SITE WITHIN 24 HOURS OF THIS EVENT.
  - c. THE MONITOR SHALL PROVIDE TECHNICAL ASSISTANCE AND RECOMMENDATIONS TO THE CONTRACTOR ON THE APPROPRIATE BEST MANAGEMENT PRACTICES FOR EROSION AND SEDIMENT CONTROLS REQUIRED TO MEET THE REQUIREMENTS OF RSA 485 A:17 AND ALL APPLICABLE DES PERMIT CONDITIONS.
  - d. WITHIN 24 HOURS OF EACH INSPECTION, THE MONITOR SHALL SUBMIT A REPORT TO DES VIA EMAIL (RIDGELY MAUCK AT: RIDGELY.MAUCK@DES.NH.GOV).

-1" X 1" X 36" WOODEN STAKES PLACED 6' O.C.

FILTREXX® SILT SOXX™ (12" TYPICAL) AREA TO BE PROTECTED

— FILTREXX® SILT SOXX™ (12" TYPICAL)

SPECIFICATIONS.

. ALL MATERIAL TO MEET FILTREXX®

AS DETERMINED BY ENGINEER.

FILL TO MEET APPLICATION REQUIREMENTS.

3. COMPOST MATERIAL TO BE DISPERSED ON SITE,

-2" X 2" X 36" WOODEN STAKES PLACED 6' O.C.

PROTECTED

e. THE MONITOR SHALL MEET WITH DES TO DECIDE UPON A REPORT FORMAT. THE REPORT FORMAT SHALL BE REVIEWED AND APPROVED BY DES PRIOR TO THE START OF CONSTRUCTION.

USE_	SEEDING MIXTURE 1/	DROUGHTY	WELL DRAINED	MODERATELY WELL DRAINED	POORLY DRAINED
STEEP CUTS AND FILLS, BORROW AND DISPOSAL AREAS	A B C	FAIR POOR POOR	GOOD GOOD GOOD	GOOD FAIR EXCELLENT	FAIR FAIR GOOD
71112713	D	FAIR	EXCELLENT	EXCELLENT	POOR
WATERWAYS, EMERGENC'S SPILLWAYS, AND OTHER CHANNELS WITH FLOWING WATER.	Y A C	GOOD GOOD	GOOD EXCELLENT	GOOD EXCELLENT	FAIR FAIR
LIGHTLY USED PARKING LOTS, ODD AREAS, UNUSED LANDS, AND LOW INTENSITY USE RECREATION SITES.	A B C	GOOD GOOD GOOD	GOOD GOOD EXCELLENT	GOOD FAIR EXCELLENT	FAIR POOR FAIR
PLAY AREAS AND ATHLETIC FIELDS. (TOPSOIL IS ESSENTIAL FOR GOOD TURF.)	E F	FAIR FAIR	EXCELLENT EXCELLENT	EXCELLENT EXCELLENT	<u>2/</u> 2/

GRAVEL PIT, SEE NH-PM-24 IN APPENDIX FOR RECOMMENDATION REGARDING RECLAMATION OF SAND AND GRAVEL PITS.

27 POORLY DRAINED SOILS ARE NOT DESIRABLE FOR USE AS PLAYING AREA AND ATHLETIC FIELDS.

1/ REFER TO SEEDING MIXTURES AND RATES IN TABLE BELOW.

NOTE: TEMPORARY SEED MIX FOR STABILIZATION OF TURF SHALL BE WINTER RYE OR OATS AT A RATE OF 2.5 LBS. PER 1000 S.F. AND SHALL BE PLACED PRIOR TO OCTOBER 15th, IF PERMANENT SEEDING NOT YET COMPLETE. SEEDING GUIDE

MIXTURE	POUNDS PER ACRE	POUNDS PER 1.000 Sq. Ft
A. TALL FESCUE CREEPING RED FESCUE RED TOP TOTAL	20 20 <u>2</u> 42	0.45 0.45 <u>0.05</u> 0.95
B. TALL FESCUE CREEPING RED FESCUE CROWN VETCH OR	15 10 15	0.35 0.25 0.35
FLAT PEA TOTAL	30 40 OR 55	0.75 0.95 OR 1.35
C. TALL FESCUE CREEPING RED FESCUE BIRDS FOOT TREFOIL TOTAL	20 20 <u>8</u> 48	0.45 0.45 <u>0.20</u> 1.10
D. TALL FESCUE FLAT PEA TOTAL	20 30 50	0.45 <u>0.75</u> 1.20
E. CREEPING RED FESCUE 1/ KENTUCKY BLUEGRASS 1/ TOTAL	50 50 100	1.15 1.15 2.30
F. TALL FESCUE 1	150	3.60
1/FOR HEAVY USE ATHLETIC FIELD NEW HAMPSHIRE COOPERATIVE EXT CURRENT VARIETIES AND SEEDING	ENSION TURF SPE	

SEEDING RATES

Owner of

Record:

### CONSTRUCTION SEQUENCE

- PRIOR TO THE START OF ANY ACTIVITY, IT IS THE RESPONSIBILITY OF THE SITE'S SITE DEVELOPER (OR OWNER) TO FILE A NOTICE OF INTENT (NOI) FORM WITH THE ENVIRONMENTAL PROTECTION AGENCY (EPA) IN ORDER TO GAIN COVERAGE UNDER THE NPDES GENERAL PERMIT FOR STORM WATER DISCHARGES FROM CONSTRUCTION ACTIVITIES. A PRE CONSTRUCTION MEETING IS TO BE HELD WITH ALL DEPARTMENT HEADS PRIOR TO THE START OF CONSTRUCTION.
- WETLAND BOUNDARIES ARE TO BE CLEARLY MARKED PRIOR TO THE START OF CONSTRUCTION. AT LEAST A TEMPORARY CULVERT OR ROADBED TO BE IN PLACE PRIOR TO THE START OF
- 3. CUT AND REMOVE TREES IN CONSTRUCTION AREA AS REQUIRED OR DIRECTED.
- 4. INSTALL SILT FENCING, HAY BALES AND CONSTRUCTION ENTRANCES PRIOR TO THE START OF CONSTRUCTION. THESE ARE TO BE MAINTAINED UNTIL THE FINAL PAVEMENT SURFACING AND LANDSCAPING AREAS ARE ESTABLISHED.
- 5. CLEAR, CUT, GRUB AND DISPOSE OF DEBRIS IN APPROVED FACILITIES. THIS INCLUDES ANY REQUIRED DEMOLITION OF EXISTING STRUCTURES, UTILITIES, ETC.
- 6. CONSTRUCT AND/OR INSTALL TEMPORARY OR PERMANENT SEDIMENT AND/OR DETENTION BASIN(S) AS REQUIRED. THESE FACILITIES SHALL BE INSTALLED AND STABILIZED PRIOR TO DIRECTING
- 7. STRIP LOAM AND PAVEMENT, OR RECLAIM EXISTING PAVEMENT WITHIN LIMITS OF WORK PER THE RECOMMENDATIONS OF THE PROJECT ENGINEER AND STOCKPILE EXCESS MATERIAL. STABILIZE
- 8. PERFORM PRELIMINARY SITE GRADING IN ACCORDANCE WITH THE PLANS, INCLUDING THE CONSTRUCTION OF ANY RETAINING WALLS AND SOUND WALLS.
- 9. PREPARE BUILDING PAD(S) TO ENABLE BUILDING CONSTRUCTION TO BEGIN.
- 10. INSTALL THE SEWER AND DRAINAGE SYSTEMS FIRST, THEN ANY OTHER UTILITIES IN ACCORDANCE WITH THE PLAN AND DETAILS. ANY CONFLICTS BETWEEN UTILITIES ARE TO BE RESOLVED WITH THE INVOLVEMENT AND APPROVAL OF THE ENGINEER.
- 11. INSTALL INLET PROTECTION AT ALL CATCH BASINS AS THEY ARE CONSTRUCTED IN ACCORDANCE
- 12. ALL SWALES AND DRAINAGE STRUCTURES ARE TO BE CONSTRUCTED AND STABILIZED PRIOR TO HAVING RUN-OFF DIRECTED TO THEM.
- 13. DAILY, OR AS REQUIRED, CONSTRUCT TEMPORARY BERMS, DRAINAGE DITCHES, CHECK DAMS, SEDIMENT TRAPS, ETC., TO PREVENT EROSION ON THE SITE AND PREVENT ANY SILTATION OF
- 14. PERFORM FINAL FINE GRADING, INCLUDING PLACEMENT OF 'SELECT' SUBGRADE MATERIALS.
- 15. PAVE ALL PARKING LOTS AND ROADWAYS WITH INITIAL 'BASE COURSE'.
- 16. PERFORM ALL REMAINING SITE CONSTRUCTION (i.e. BUILDING, CURBING, UTILITY CONNECTIONS,
- 17. LOAM AND SEED ALL DISTURBED AREAS AND INSTALL ANY REQUIRED SEDIMENT AND EROSION CONTROL FACILITIES (i.e. RIP RAP, EROSION CONTROL BLANKETS, ETC.).
- 18. FINISH PAVING ALL ROADWAYS AND PARKING AREAS WITH 'FINISH' COURSE.
- 19. ALL ROADWAYS AND PARKING LOTS SHALL BE STABILIZED WITHIN 72 HOURS OF ACHIEVING
- 20. ALL CUT AND FILL SLOPES SHALL BE SEEDED/LOAMED WITHIN 72 HOURS OF ACHIEVING FINISHED
- 21. COMPLETE PERMANENT SEEDING AND LANDSCAPING.

ABUTTING WATERS AND/OR PROPERTY.

- 22. REMOVE TEMPORARY EROSION CONTROL MEASURES AFTER SEEDING AREAS HAVE BEEN 75%-85% ESTABLISHED AND SITE IMPROVEMENTS ARE COMPLETE. SMOOTH AND RE-VEGETATE ALL DISTURBED
- 23. CLEAN SITE AND ALL DRAINAGE STRUCTURES, PIPES AND SUMPS OF ALL SILT AND DEBRIS.
- 24. INSTALL ALL PAINTED PAVEMENT MARKINGS AND SIGNAGE PER THE PLANS AND DETAILS.
- 25. ALL EROSION CONTROLS SHALL BE INSPECTED WEEKLY AND AFTER EVERY HALF-INCH OF RAINFALL.
- 26. UPON COMPLETION OF CONSTRUCTION, IT IS THE RESPONSIBILITY OF THE CONTRACTOR TO NOTIFY ANY RELEVANT PERMITTING AGENCIES THAT THE CONSTRUCTION HAS BEEN FINISHED IN A SATISFACTORY MANNER.

### SEEDING SPECIFICATIONS

- 1. <u>GRADING AND SHAPING</u>
  A. SLOPES SHALL NOT BE STEEPER THAN 2:1 WITHOUT APPROPRIATE EROSION CONTROL MEASURES AS SPECIFIED ON THE PLANS (3:1 SLOPES OR FLATTER ARE PREFERRED). WHERE MOWING WILL BE DONE, 3:1 SLOPES OR FLATTER ARE RECOMMENDED.
- 2. <u>SEEDBED PREPARATION</u> A. SURFACE AND SEEPAGE WATER SHOULD BE DRAINED OR DIVERTED FROM THE SITE TO PREVENT
- DROWNING OR WINTER KILLING OF THE PLANTS. B. STONES LARGER THAN 4 INCHES AND TRASH SHOULD BE REMOVED BECAUSE THEY INTERFERE WITH SEEDING AND FUTURE MAINTENANCE OF THE AREA. WHERE FEASIBLE, THE SOIL SHOULD BE TILLED TO A DEPTH OF ABOUT 4 INCHES TO PREPARE A SEEDBED AND FERTILIZER AND LIME MIXED INTO THE SOIL. THE SEEDBED SHOULD BE LEFT IN A REASONABLY FIRM AND SMOOTH CONDITION. THE LAST TILLAGE OPERATION SHOULD BE PERFORMED ACROSS THE SLOPE

- 3. <u>ESTABLISHING A STAND</u>
  A. LIME AND FERTILIZER SHOULD BE APPLIED PRIOR TO OR AT THE TIME OF SEEDING AND INCORPORATED INTO THE SOIL. TYPES AND AMOUNTS OF LIME AND FERTILIZER SHOULD BE BASED ON AN EVALUATION OF SOIL TESTS. WHEN A SOIL TEST IS NOT AVAILABLE, THE FOLLOWING MINIMUM AMOUNTS SHOULD BE APPLIED:
  - AGRICULTURAL LIMESTONE, 2 TONS PER ACRE OR 100 LBS. PER 1,000 SQ.FT. NITROGEN(N). 50 LBS. PER ACRE OR 1.1 LBS. PER 1.000 SQ.FT. PHOSPHATE(P205), 100 LBS. PER ACRE OR 2.2 LBS. PER 1,000 SQ.FT. POTASH(K2O), 100 LBS. PER ACRE OR 2.2 LBS. PER 1,000 SQ.FT.
- (NOTE: THIS IS THE EQUIVALENT OF 500 LBS. PER ACRE OF 10-20-20 FERTILIZER OR 1,000 LBS. PER ACRE OF 5-10-10.) B. SEED SHOULD BE SPREAD UNIFORMLY BY THE METHOD MOST APPROPRIATE FOR THE SITE.
- METHODS INCLUDE BROADCASTING, DRILLING AND HYDROSEEDING. WHERE BROADCASTING IS USED, COVER SEED WITH .25 INCH OF SOIL OR LESS, BY CULTIPACKING OR RAKING. C. REFER TO THE 'SEEDING GUIDE' AND 'SEEDING RATES' TABLES ON THIS SHEET FOR APPROPRIATE SEED MIXTURES AND RATES OF SEEDING. ALL LEGUMES (CROWNVETCH,
- BIRDSFOOT, TREFOIL AND FLATPEA) MUST BE INOCULATED WITH THEIR SPECIFIC INOCULANT PRIOR TO THEIR INTRODUCTION TO THE SITE. D. WHEN SEEDED AREAS ARE MULCHED, PLANTINGS MAY BE MADE FROM EARLY SPRING TO EARLY OCTOBER. WHEN SEEDED AREAS ARE NOT MULCHED, PLANTINGS SHOULD BE MADE FROM

# 4. MULCH A. HAY, STRAW, OR OTHER MULCH, WHEN NEEDED, SHOULD BE APPLIED IMMEDIATELY AFTER

EARLY SPRING TO MAY 20th OR FROM AUGUST 10th TO SEPTEMBER 1st.

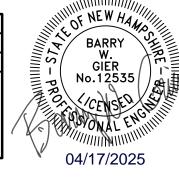
- B. MULCH WILL BE HELD IN PLACE USING APPROPRIATE TECHNIQUES FROM THE BEST MANAGEMENT PRACTICE FOR MULCHING. HAY OR STRAW MULCH SHALL BE PLACED AT A RATE OF 90 LBS PER 1000 S.F
- 5. <u>MAINTENANCE TO ESTABLISH A STAND</u>
  A. PLANTED AREAS SHOULD BE PROTECTED FROM DAMAGE BY FIRE, GRAZING, TRAFFIC, AND DENSE
- WFFD GROWTH. B. FERTILIZATION NEEDS SHOULD BE DETERMINED BY ONSITE INSPECTIONS. SUPPLEMENTAL FERTILIZER IS USUALLY THE KEY TO FULLY COMPLETE THE ESTABLISHMENT OF THE STAND
- BECAUSE MOST PERENNIALS TAKE 2 TO 3 YEARS TO BECOME FULLY ESTABLISHED. C. IN WATERWAYS, CHANNELS, OR SWALES WHERE UNIFORM FLOW CONDITIONS ARE ANTICIPATED. ANNUAL MOWING MAY BE NECESSARY TO CONTROL GROWTH OF WOODY VEGETATION.

Plan Name: EROSION & SEDIMENT CONTROL NOTES & DETAILS SINGLE-FAMILY RESIDENCE & HOME BUSINESS 50 & 68 SHAKER ROAD, CONCORD, NH

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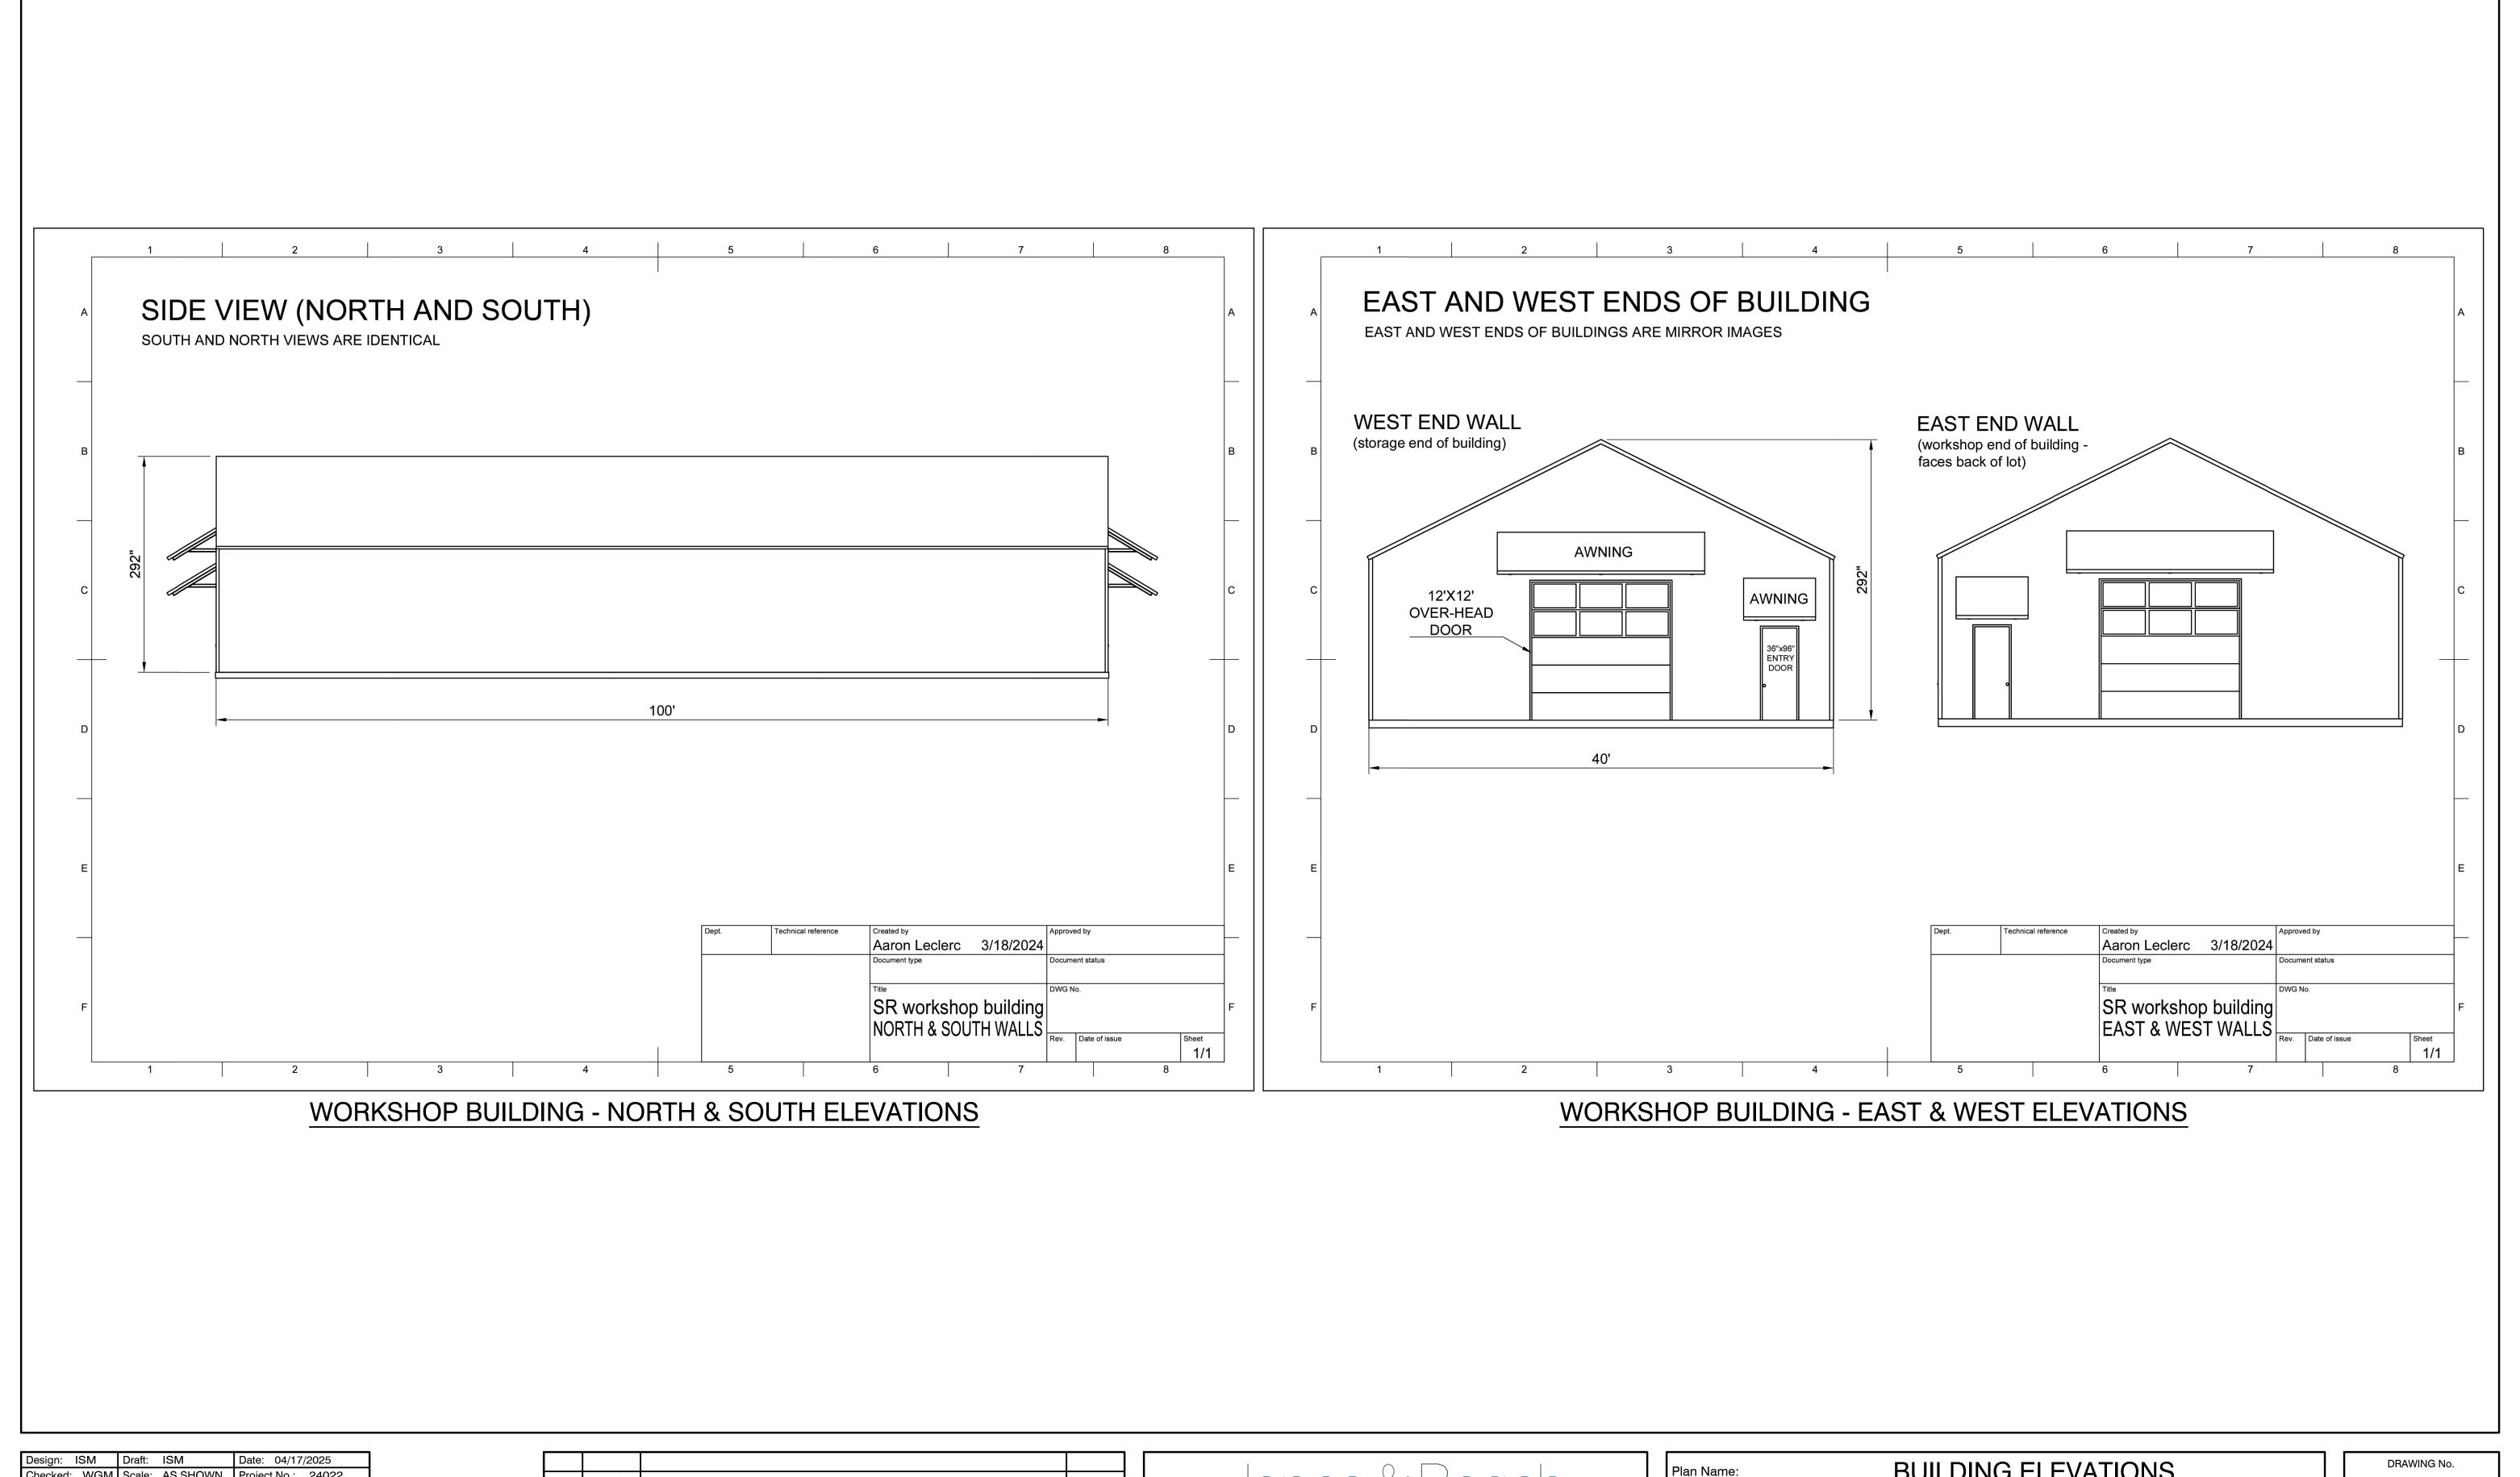
	3	04/16/25	REVISED LOT LINE ADJUSTMENT	BWG
4	2	02/19/25	DRIVEWAY ALIGNMENT & POND DESIGN MODIFICATIONS AND LLA	ISM
	1	12/18/24	REVISIONS PER PLANNING STAFF AND ENGINEERING COMMENTS	ISM
	0	10/16/24	ISSUED FOR PLANNING BOARD REVIEW	ISM
	REV.	DATE	REVISION	BY



AARON LECLERC & CARA SCALA 29 HOT HOLE ROAD, CONCORD, NH 03301

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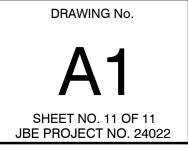


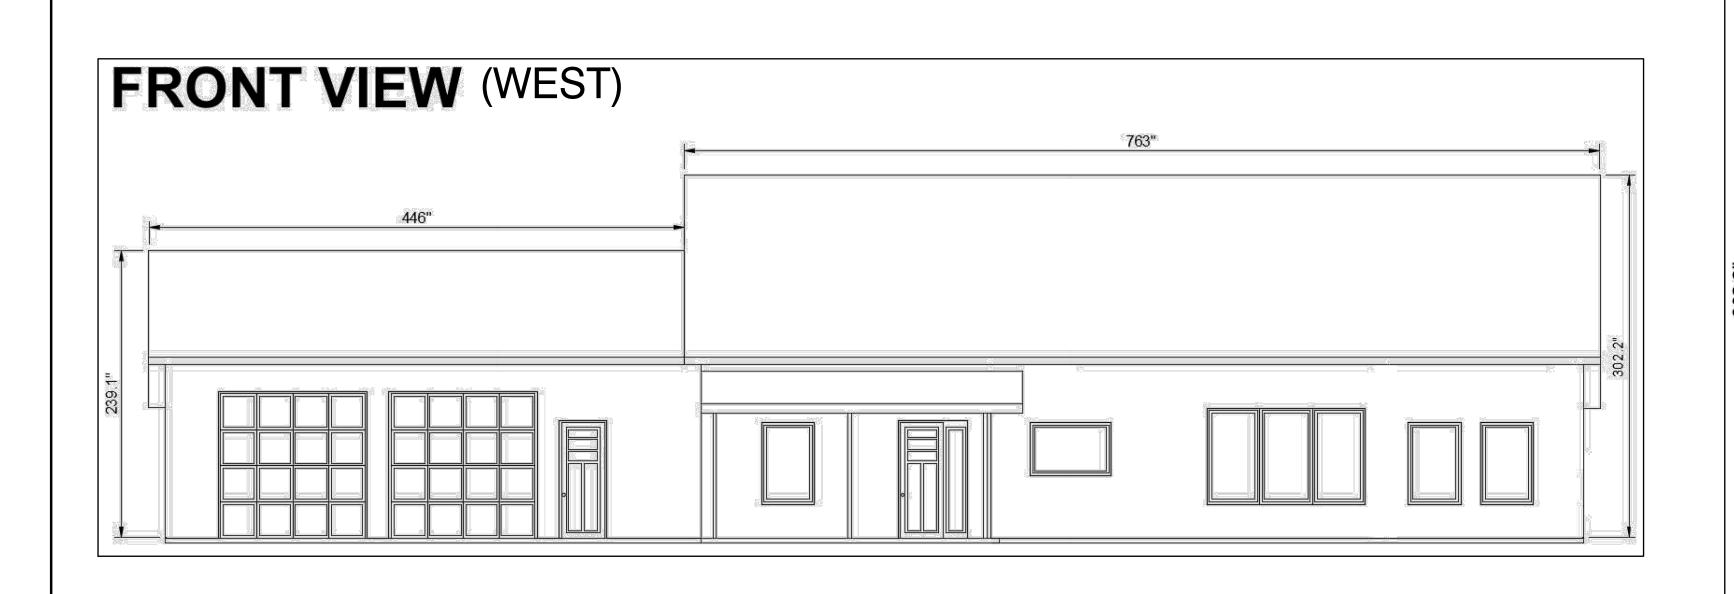
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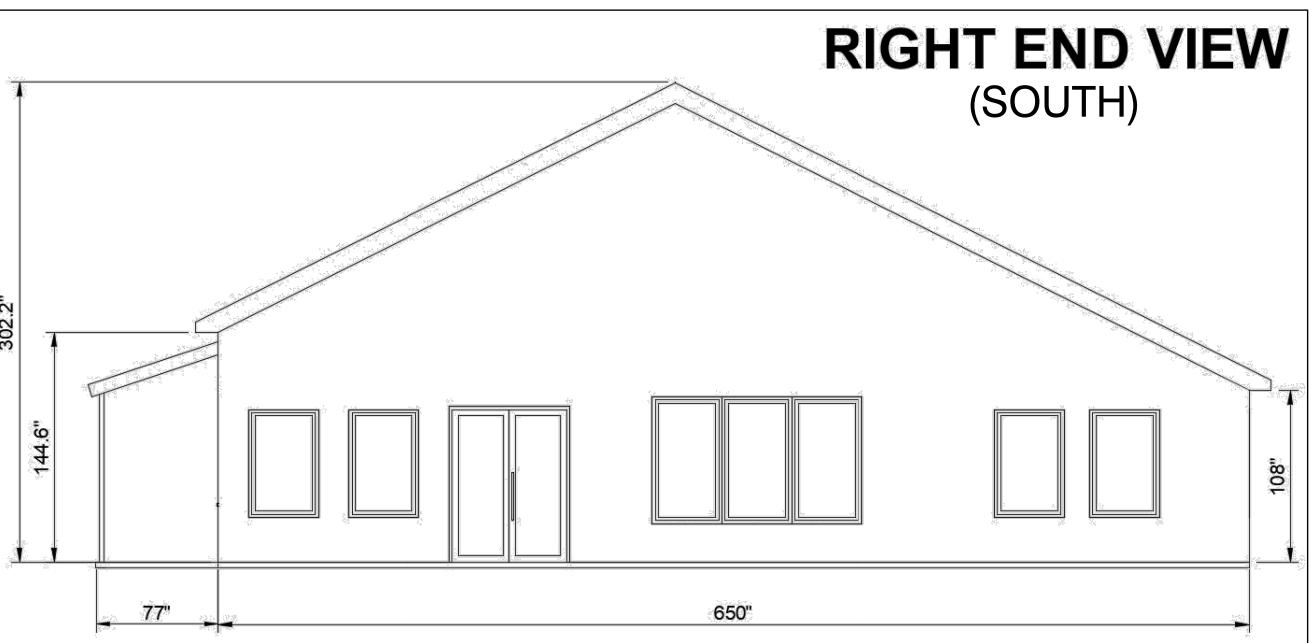
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2	02/19/25	DRIVEWAY ALIGNMENT & POND DESIGN MODIFICATIONS AND LLA	ISM
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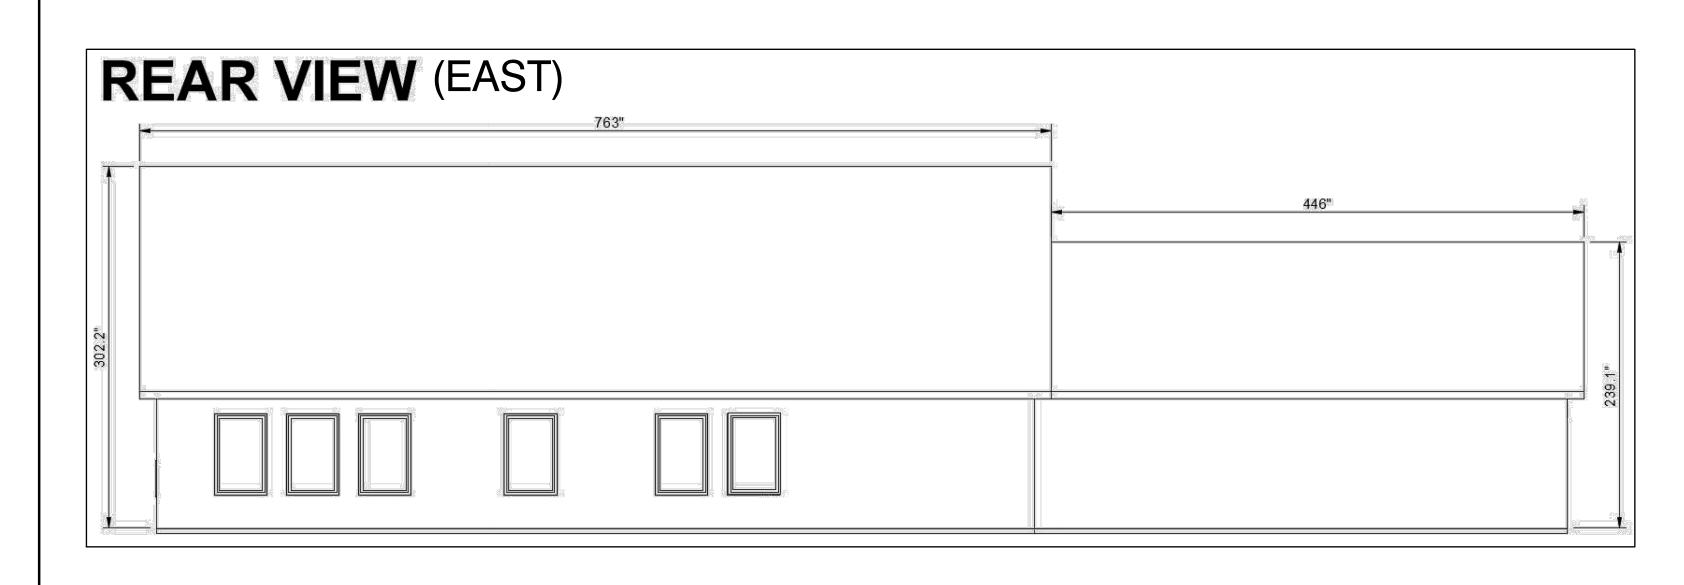


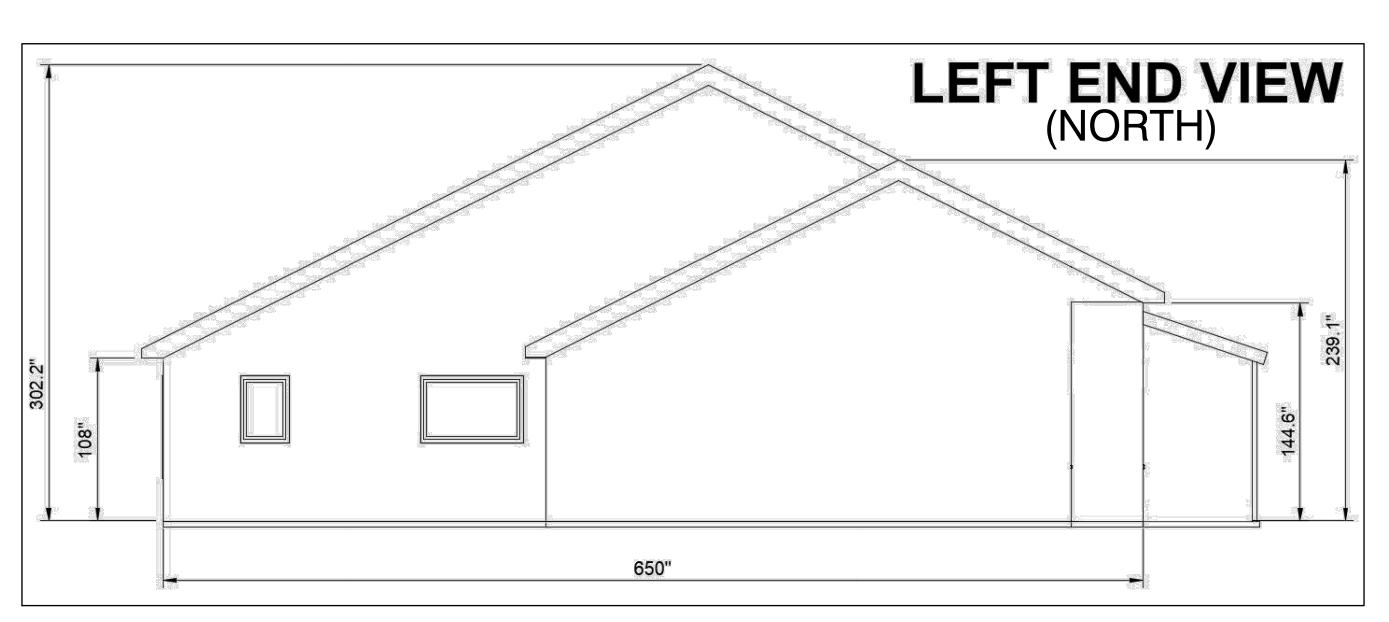
Plan Name:	BUILDING ELEVATIONS
Project:	SINGLE-FAMILY RESIDENCE & HOME BUSINESS 50 & 68 SHAKER ROAD, CONCORD, NH
Owner of Record:	AARON LECLERC & CARA SCALA 29 HOT HOLE ROAD, CONCORD, NH 03301











SINGLE-FAMILY HOME ELEVATIONS

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