MAP 6442Z LOTS 12 & 12-2 SITE PLAN



5, 7, 9, 11 & 13 STICKNEY AVENUE
CONCORD, NEW HAMPSHIRE

PREPARED FOR



670 N. COMMERCIAL STREET, SUITE 303 MANCHESTER, NEW HAMPSHIRE 03101

RECORD OWNER

STICKNEY A VENUE, LLC

670 N. COMMERCIAL STREET, SUITE 303 MANCHESTER, NEW HAMPSHIRE 03101

20 JULY 2022

9	3/14/25	MINOR SITE REVISIONS FOR ADMINISTRATIVE APPROVAL	TEZ
8	9/11/24	ADDRESS STAFF COMMENTS, ADD CIPP LINING SCOPE & REVISE EASEMENTS	TEZ
7	4/16/24	ADDRESS STAFF & NHDES COMMENTS	TEZ
6	1/31/24	ADDRESS STAFF COMMENTS	TEZ
1-5	-	SEE PREVIOUS PLAN REVISIONS ON FILE	TEZ
νο.	DATE	REVISION	BY

Hayner/Swanson, Inc.

Civil Engineers/Land Surveyors
3 Congress Street
Nashua, NH 03062
(603) 883-2057

Civil Engineers/Land Surveyors
131 Middlesex Turnpike
Burlington, MA 01803
(781) 203-1501

www.hayner-swanson.com


SUBMITTED FOR AN AMENDMENT TO AN APPROVED MAJOR SITE PLAN FOR THE FOLLOWING CHANGES:

1) REPLACE PORTIONS OF GRANITE CURBING WITH MONOLITHIC CONCRETE CURB AND SIDEWALK


2) REPLACE PORTIONS OF GRANITE CURBING WITH CAPE COD BERM (SHEETS 6, 7 & 17)

3) ADDED ALTERNATIVE TYPICAL PAVEMENT SECTION TO
 INCLUDE RECLAIMED BASE MATERIAL (SHEET 17)

4) REVISED LANDSCAPE PLAN TO ADDRESS COMMENTS NH
DIVISION OF HISTORICAL RESOURCES (NHDHR) (BY PROJECT'S
LANDSCAPE ARCHITECT)

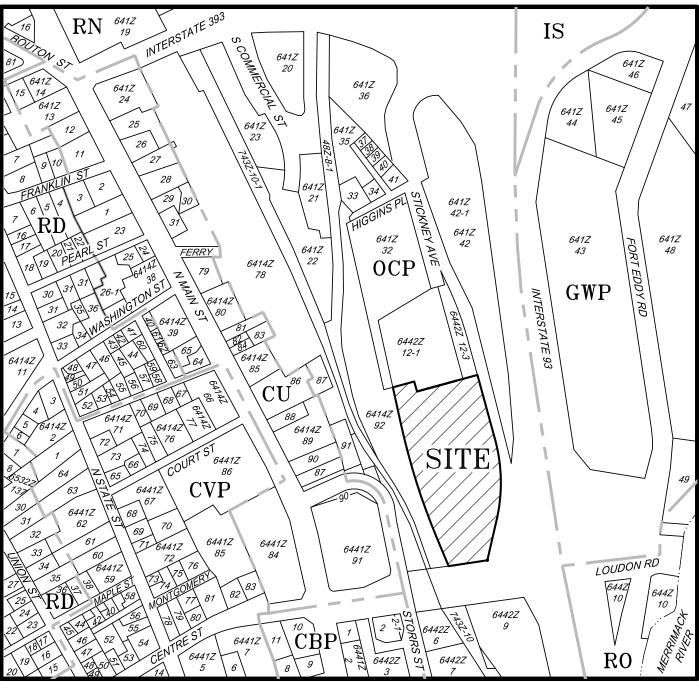

LOCATION PLAN
SCALE: 1" · 400'

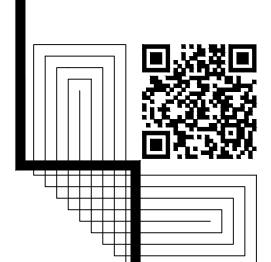

CITY OF CONCORD PLANNING BOARD CONDITIONS OF APPROVAL:


THE CITY OF CONCORD PLANNING BOARD, AT ITS MEETING ON MARCH 15, 2023, VOTED TO GRANT ARCHITECTURAL DESIGN REVIEW (ADR) APPROVAL TO REDEVELOP FIVE VACANT DOT HIGHWAY GARAGE STRUCTURES INTO (80) MULTIFAMILY RESIDENTIAL UNITS AT 1 1 STICKNEY AVE IN THE OPPORTUNITY CORRIDOR PERFORMANCE (OCP).


THE BOARD ALSO VOTED TO GRANT THE CONDITIONAL USE PERMIT TO ARTICLE 28-4-5(e)L MIXED USE COMPONENT REQUIRED TO NOT PROVIDE A COMMERCIAL COMPONENT IN THIS DEVELOPMENT.

FINALLY, THE BOARD VOTED TO GRANT MAJOR SITE PLAN APPROVAL SUBJECT TO THE FOLLOWING SUBSEQUENT CONDITIONS — TO BE FULFILLED AS SPECIFIED:

- 1. THE APPLICANT OR DESIGNATED AGENT SHALL CONTACT THE ENGINEERING SERVICES DIVISION TO SCHEDULE A PRE-CONSTRUCTION MEETING PRIOR TO THE START OF ANY CONSTRUCTION ACTIVITIES ONSITE. SEE ENGINEERING MEMO FOR ADDITIONAL PRE-CONSTRUCTION ITEMS TO BE ADDRESSED.
- 2. PRIOR TO THE ISSUANCE OF THE FIRST BUILDING PERMIT, THE APPLICANT WILL PROVIDE TO THE CITY SOLICITOR A FINANCIAL GUARANTEE FOR ALL PUBLIC IMPROVEMENTS ON AND OFF SITE AND A GUARANTEE FOR THE SITE STABILIZATION IN AN AMOUNT APPROVED BY THE CITY ENGINEER, AND IN A FORM ACCEPTABLE TO THE CITY SOLICITOR.
- 3. THE APPLICANT SHALL COORDINATE ANY SIDEWALK CONSTRUCTION WITH THE CITY OF CONCORD GENERAL SERVICES DEPARTMENT
- 5. TRAFFIC AND RECREATION IMPACT FEES SHALL BE ASSESSED FOR ANY RESIDENTIAL CONSTRUCTION CONTAINED WITHIN THE LIMITS OF THE APPROVED SITE PLAN. THE IMPACT FEES AND PROCEDURES SHALL BE THOSE IN EFFECT AT THE TIME OF THE ISSUANCE OF A BUILDING PERMIT AS SET FORTH IN THE CITY OF CONCORD CODE OF ORDINANCES, TITLE IV, SUBDIVISION CODE: CHAPTER 29.2, PUBLIC CAPITAL FACILITIES IMPACT FEE ORDINANCE. THE SPECIFIC FEES ASSESSED ARE THOSE CONTAINED IN SECTION 29.2.1-1 ASSESSMENT AND COLLECTION; SUBSECTION (b) COMPUTATION OF THE AMOUNT OF IMPACT FEES; TABLE 2, RECREATIONAL FACILITIES IMPACT FEE PER VARIABLE UNIT; AND TABLE 3, TRANSPORTATION FACILITIES IMPACT FEE PER VARIABLE UNIT;
- A. RECREATIONAL FACILITIES MULTI-UNIT/APARTMENT
- B. TRANSPORTATION FACILITIES MULTI-UNIT/APARTMENT

	INDEX OF PLANS				
SHEET No.	TITLE				
1 OF 24 2-3 OF 24 4-5 OF 24 6-7 OF 24 8-9 OF 24 10-11 OF 24 12-14 OF 24	MASTER SITE PLAN EXISTING CONDITIONS PLANS SITE DEMOLITION PLANS SITE LAYOUT PLANS SITE GRADING & DRAINAGE PLANS SITE UTILITY PLANS UTILITY PROFILES	1"= 40' 1"= 20' 1"= 20' 1" = 20' 1" = 20' 1" = 20' 1"= 40' H 1"= 4' V			
15 OF 24 16 OF 24 17-20 OF 24 21 OF 24 22 OF 24 23 OF 24 24 OF 24	EROSION CONTROL PLAN DETAIL SHEET - EROSION CONTROL DETAIL SHEET - GENERAL SITE DETAIL SHEET - SEWER DETAIL SHEET - WATER PHOTOMETRIC SITE LIGHTING PLAN FIRE TRUCK TURNING PLAN	1" = 40' 1" = 40' 1" = 40'			
	LANDSCAPE PLANS, NOTES & DETAILS (ARCHITECTURAL FLOOR PLANS & ELEV				

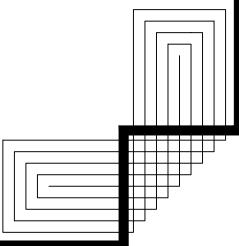

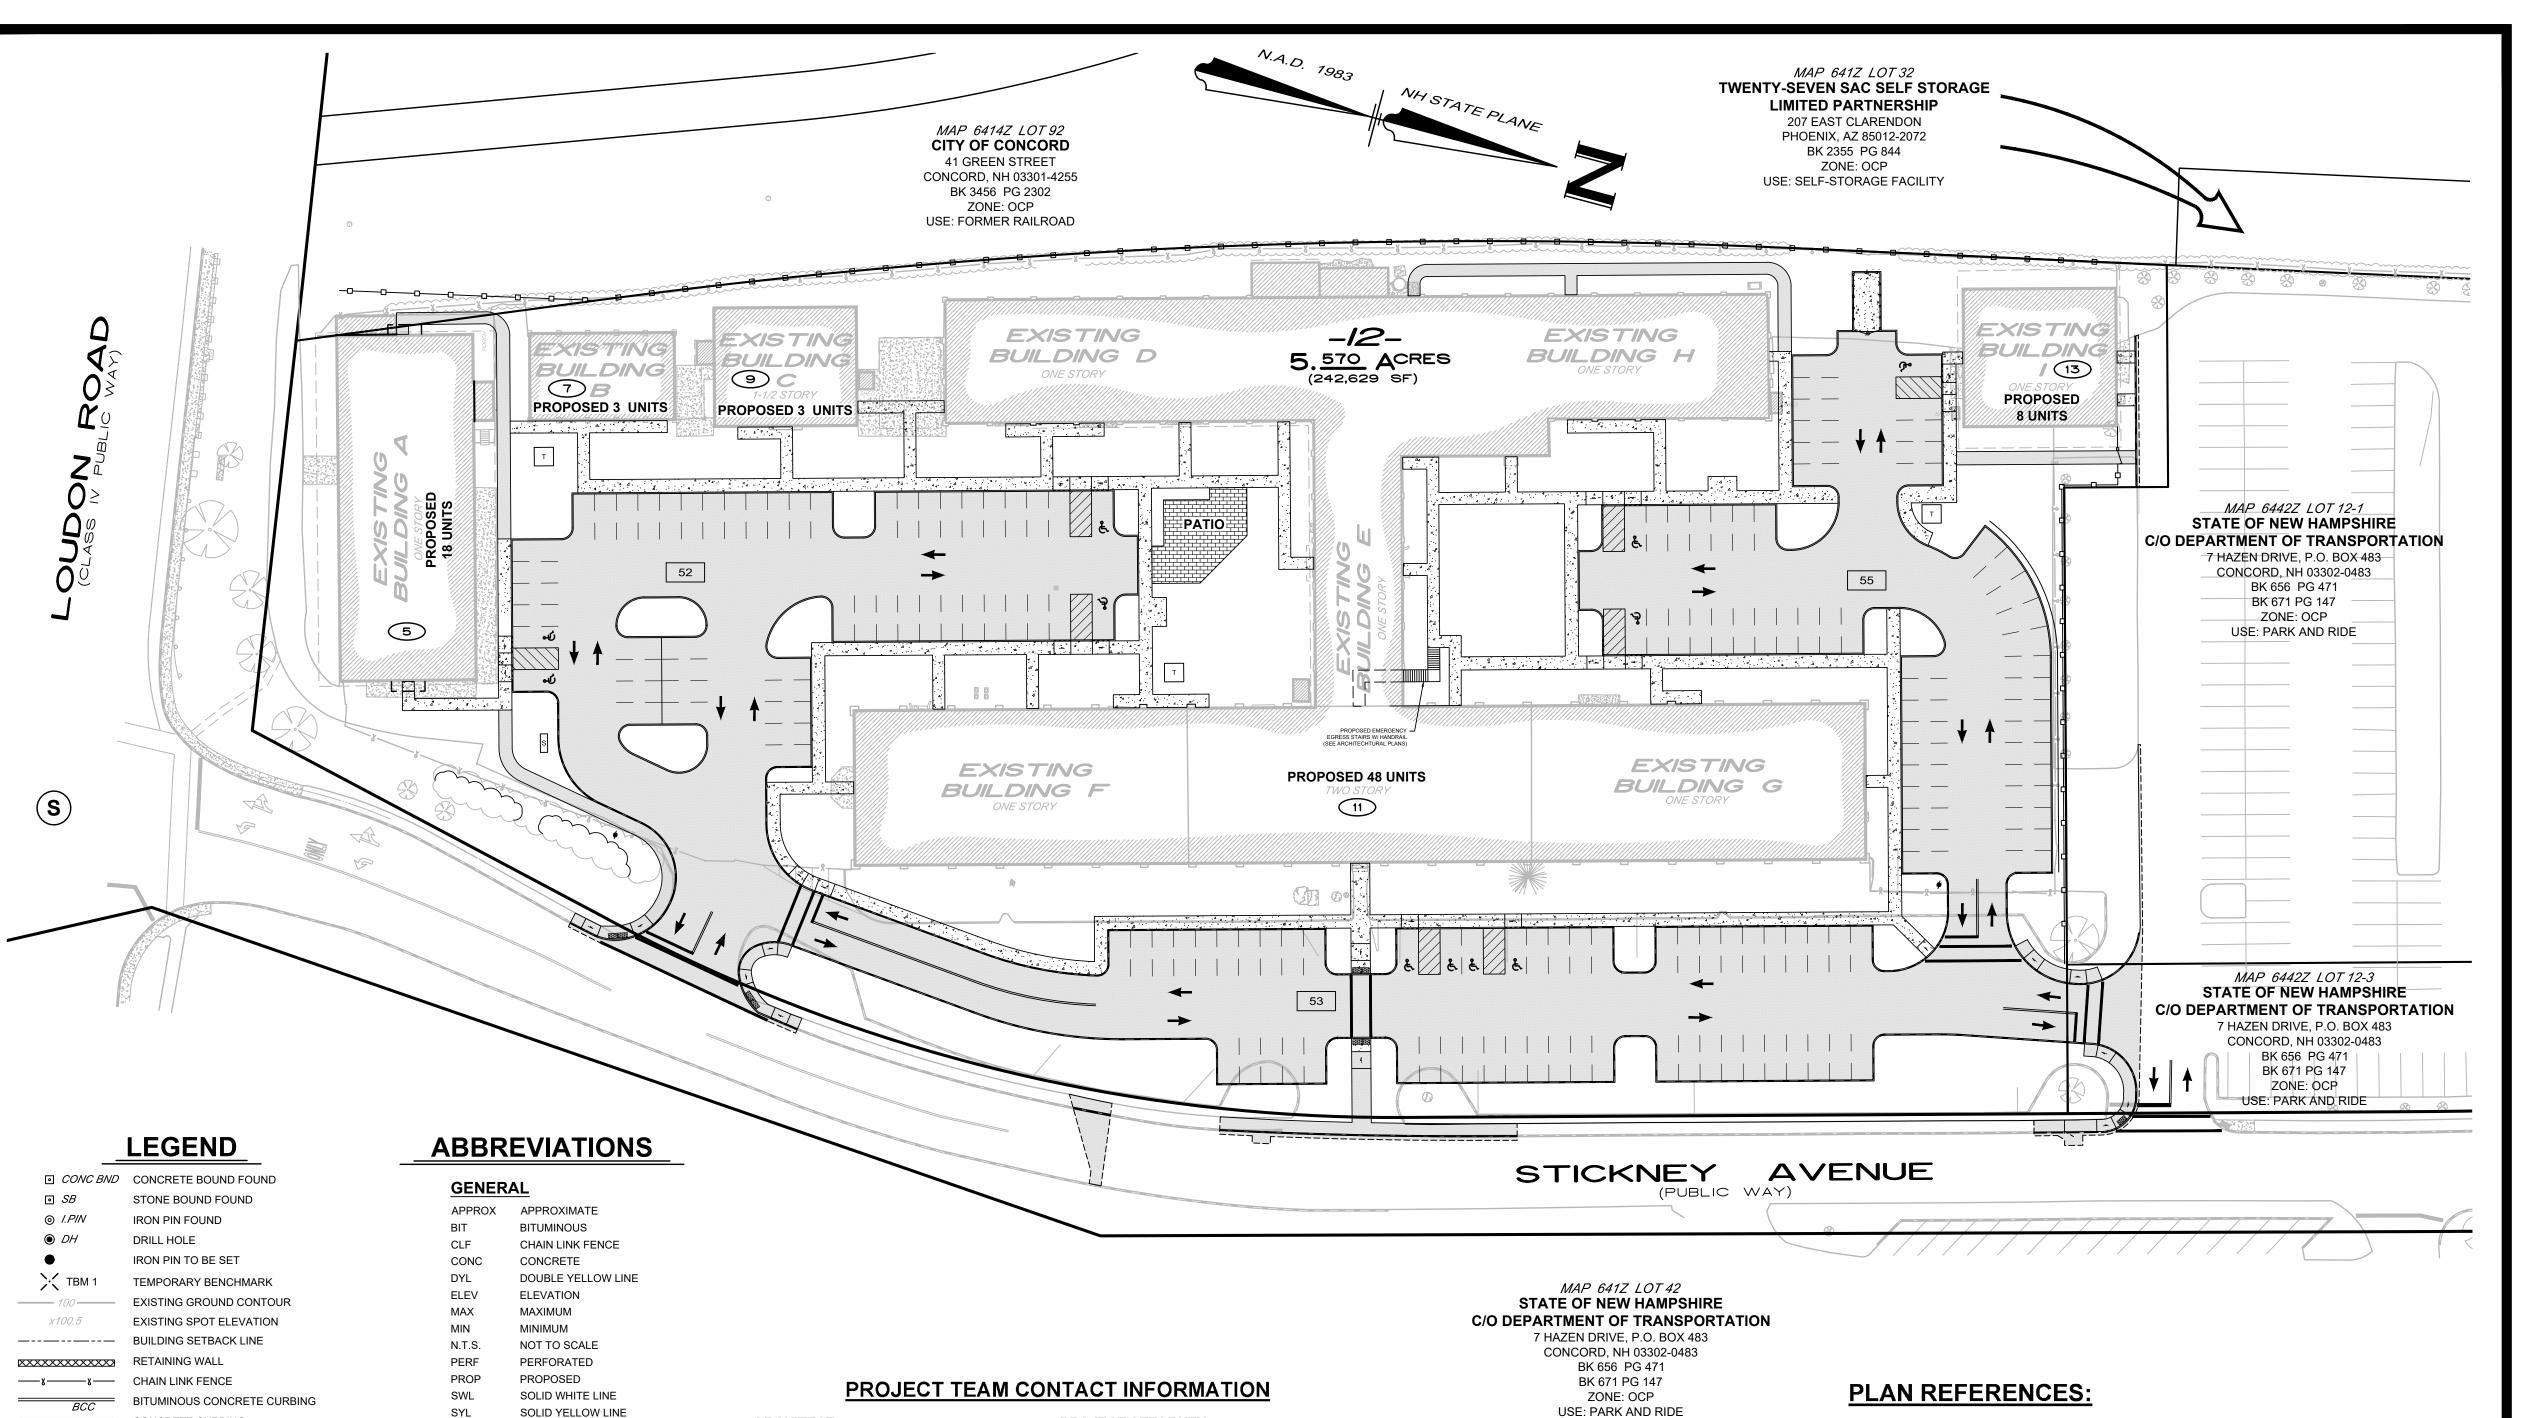

THRESHOLD ELEVATION

UTILITY

C.I.

C.O.

RCP

CATCH BASIN

CAST IRON PIPE

SEWER MANHOLE

VITRIFIED CLAY PIPE

MA.ME.NH.RI.VT

CONTACT DIG SAFE 72 HOURS

PRIOR TO CONSTRUCTION

digsafe.com

DIAL 811 or

1-888-DIG-SAFE

UNDERGROUND

CORRUGATED METAL PIPE

CHRIS LEWIS, NCARB BRADY SULLIVAN PROPERTIES, INC. 670 N. COMMERCIAL STREET, SUITE 303 MANCHESTER, NH 03101 (603) 622-6223 clewis@bradysullivan.com

CIVIL ENGINEER

<u>ARCHITECT</u>

CLEANOUT THOMAS E. ZAJAC, JR., P.E. COPPER PIPE HAYNER/SWANSON, INC. DUCTILE IRON PIPE 3 Congress Street Nashua, NH 03062 DRAIN MANHOLE (603) 882-2057 EXT. 145 YARD DRAIN MANHOLE tzajac@hayner-swanson.com HIGH DENSITY POLYETHYLENE PIPE

LAND SURVEYOR

HYDRANT INVERT PAUL LIVERSIDGE, LLS, PLS POST INDICATOR VALVE HAYNER/SWANSON, INC. 3 Congress Street PLASTIC PIPE Nashua, NH 03062 POLYVINYL CHLORIDE PIPE (603) 882-2057 EXT. 153 REINFORCED CONCRETE PIPE pliversidge@hayner-swanson.com RIM ELEVATION

LANDSCAPE ARCHITECT

LEO F. URBAN, PLA **URBAN ASSOCIATES. INC.** 96 Westchester Way MANCHESTER, NH 03104 (561) 715-9747 EXT. 153 uainc@bellsouth.net

TOTALS

94,867

PROJECT ATTORNEY JOHN G. CRONIN, ESQ. CRONIN, BISSON & ZALINSKY, P.C. 722 CHESTNUT STREET MANCHESTER, NH 03104 (603) 624-4333 jcronin@cbzlaw.com

TRAFFIC ENGINEER

STEPHEN G. PERNAW, P.E., PTOE STEPHEN G. PERNAW & COMPANY, INC. PO Box 1721 CONCORD, NH 03302 (603) 731-8500 sgp@pernaw.com

ENVIRONMENTAL/GEOTECHNICAL ENGINEER

49

22

CLARENCE 'TIM' ANDREWS, PG ALFRED JONES, P.E. Nobis Group 18 CHENELL DRIVE CONCORD. NH 03301 (603) 724-6226 tandrews@nobis-group.com ajones@nobis-group.com

BUILDING TABLE GROSS TWO-THREE-ONE-BEDROOM BUILDING BUILDING TOTAL UNITS BEDROOM BEDROOM UNITS AREA (SF) UNITS UNITS BUILDING 'A' 20,086 18 2,253 **BUILDING 'B'** 3,080 BUILDING 'C 60,318 BUILDING 'D'-'H' 48 23 BUILDING 'I' 9,130

80

ABUTTERS ACROSS LOUDON ROAD

MAP 6442Z LOT 5

CITY OF CONCORD

41 GREEN STREET

ZONE: OCP

USE: RECREATION

MAP 6442Z LOT 6

GRANITE CENTER LLC

P.O. BOX 1438

CONCORD, NH 03302-1438

BK 3603 PG 1190

ZONE: OCP

USE: PARKING LOT

MAP 6442Z LOT 9

PFP ASSOCIATES LTD PARTNERSHIP

56 KEARNEY ROAD, FLOOR 1

NEEDHAM HEIGHTS, MA 02494-2507

BK 1615 PG 894

ZONE: OCP

USE: SHOPPING MALL

MAP 743Z LOT 10

NORTHERN RAILROAD

C/O PAN AM RAILWAYS, INC.

N1700 IRON HORSE PARK

NORTH BILLERICA, MA 01862-1681

ZONE: OCP

USE: RAILROAD

► ZONING NOTE ◀

THE ZONING/BUILDING SETBACKS DEPICTED ON THIS PLAN ARE THOSE

WE HAVE INTERPRETED FROM THE LATEST ZONING ORDINANCE OF

THE MUNICIPALITY AND, AS SUCH, ARE ONLY OPINIONS EXPRESSED BY

ORDINANCE CAN ONLY BE MADE BY THE APPROPRIATE ZONING

AUTHORITY. SINCE BUILDING ORIENTATION, PROPOSED USES, AND

OTHER FACTORS CAN AFFECT THE SETBACKS, PRIOR TO ANY

DEVELOPMENT OF THIS PROPERTY, THE BUILDER/OWNER MUST

CONSULT WITH THE TOWN/CITY TO INSURE THE CORRECT

APPLICATION OF THE ZONING ORDINANCE.

HAYNER/SWANSON, INC. THE FINAL INTERPRETATION OF THE


CONCORD, NH 03301-4255


- 1. STREET DISCONTINUANCE PLAN, STICKNEY AVENUE, CONCORD, NEW HAMPSHIRE, PREPARED FOR BRADY SULLIVAN PROPERTIES, LLC, RECORD OWNER: STATE OF NEW HAMPSHIRE, DATED 12 OCTOBER 2021 AND REVISED 11/1/21 BY HAYNER-SWANSON, INC. RECORDED MCRD PLAN No. 202400003255.
- 2. SUBDIVISION PLAN, MAP 46A BLOCK 2 LOT 1, 11 STICKNEY AVENUE, CONCORD, NEW HAMPSHIRE, PREPARED FOR BRADY SULLIVAN PROPERTIES, LLC, DATED 14 SEPTEMBER 2021 AND REVISED THROUGH 4/20/22 BY HAYNER-SWANSON, INC. RECORDED MCRD PLAN No. 202200012927.
- 3. BOUNDARY PLAN, TAX MAP 46A-BLOCK 2-LOT1, STICKNEY AVE., CONCORD, NH DATED AUGUST 14, 2001, REVISED 9/17/01 BY BURD ENGINEERING AND ON FILE AT THE CITY OF CONCORD PLANNING DEPARTMENT AND NHDOT.
- 4. BOUNDARY, TOPOGRAPHY & UTILITY SURVEY FOR U-HAUL REAL ESTATE DEPT. DATED JUNE 13, 1980 BY RICHARD D. BARTLETT R.L.S. RECORDED: MCRD PLAN No. 6343.
- 5. LAND IN CONCORD, N.H., BOSTON AND MAINE RAILROAD TO TENNEY FUELS, INC. DATED JULY 1962 BY BOSTON AND MAINE RAILROAD. RECORDED: MCRD PLAN No. 1828.
- 6. LAND IN CONCORD, NH, BOSTON & MAINE CORPORATION TO TSUNIS HOLDING, INC., DATED MAY 24, 1988, LAST REVISED 10/7/88 BY HOLDEN ENGINEERING & SURVEYING. RECORDED: MCRD PLAN No. 11145.
- 7. STATE OF NH DOT PLANS OF PROPOSED FEDERAL AID PROJECT I-93-2(56)39, NH PROJECT NO. P-7002-A, INTERSTATE ROUTE 93, ON FILE AT NH DOT.
- 8. STATE OF NH DOT R.O.W. PLANS OF PROPOSED FEDERAL AND URBAN PROJECT U 012-2(8), NH PROJECT NO. C-7632A, BRIDGE STREET OVER STORRS STREET & B&M RAILROAD, ON FILE AT NH

Clerk

APPROVED UNDER THE PROVISIONS OF R.S.A. 674:43 & R.S.A. 674:44 CITY PLANNING BOARD CITY OF CONCORD, NEW HAMPSHIRE In accordance with vote of the board dated: Approval of this plan is limited to lots as shown.

Chair

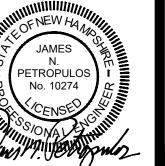

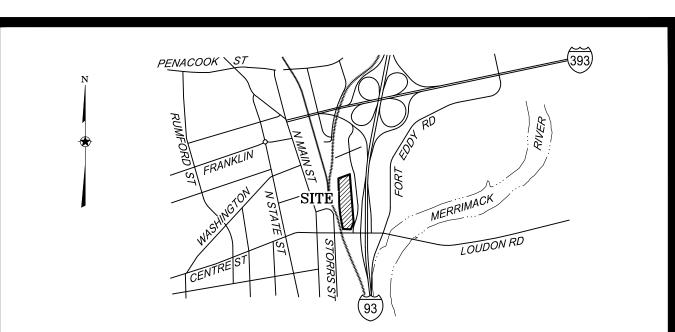

NOTES:

SITE AREA:

EXISTING MAP 6442Z, LOT 12: 4.903 ACRES (213,578 SF) EXISTING MAP 6442Z, LOT 12-2 0.667 ACRES (29,051 SF) TOTAL (POST-MERGER) 5.570 ACRES (242,629 SF)

MAP

SCALE: 1" = 2000'

PRIOR TO THE PLANNING BOARD CHAIR SIGNING THE FINAL PLAN. EXISTING LOTS 12. AND 12-2 SHALL BE CONSOLIDATED INTO NEW LOT 12 VIA VOLUNTARY LOT MERGER. ZONING DISTRICT: OCP - OPPORTUNITY CORRIDOR PERFORMANCE FH - FLOOD HAZARD OVERLAY DISTRICT (500-YEAR FLOOD)

VICINITY

MINIMUM LOT REQUIREMENTS:	<u>OCP</u>	<u>PROPOSED</u>
MIN. LOT SIZE	N/A	242,629 SF
MIN. LOT FRONTAGE	150 FT	789.8 FT
MINIMUM YARD SETBACK REQUIREMENTS:		
FRONT YARD:	15 FT	16.6 FT
SIDE YARD	15 FT	0 FT
REAR YARD	15 FT	N/A
MAX. BUILDING HEIGHT	*45 FT	30 FT
(*RESTRICTED BY VIEW OF STATE HOUSE DOME	FROM I-93)	
MIN. FLOOR AREA RATIO	0.3	0.39

TO SHOW THE PROPOSED 'ADAPTIVE RE-USE' AND REDEVELOPMENT OF THE FORMER NHDOT HIGHWAY GARAGE NO. 12 PROPERTY INTO A TOTAL OF EIGHTY (80) PROPOSED MULTI-FAMILY RESIDENTIAL UNITS ALONG WITH ASSOCIATED SITE IMPROVEMENTS. LOT NUMBERS REFER TO THE CITY OF CONCORD ASSESSOR'S MAPS 641Z, 6414Z, 6442Z & 743Z.

- SITE IS SERVICED BY MUNICIPAL SEWER & WATER, GAS, ELECTRIC AND TELECOMMUNICATIONS SUBJECT PARCEL IS LOCATED IN ZONE X, 0.2% ANNUAL CHANCE FLOOD HAZARD, AS GRAPHICALLY DEPICTED ON THE FEDERAL EMERGENCY MANAGEMENT AGENCY FLOOD
- INSURANCE RATE MAP FOR THE CITY OF CONCORD, NEW HAMPSHIRE, COMMUNITY NUMBER 330110, MAP NUMBER 33013C0533E WITH AN EFFECTIVE DATE OF APRIL 19, 2010. BUILDABLE AREA: 5.570 ACRES (242,629 SF)

LOT COVERAGE: MAX. ALLOWED: EXISTING: 65% PROPOSED:

PURPOSE OF PLAN:

MIN. REQUIRED: (2 SPACES/UNIT x 80 UNITS)= 160 SPACES

- PROPOSED: (INCLUDING 10 ACCESSIBLE SPACES)= 160 SPACES SITE IMPROVEMENTS DEPICTED ON THE PLAN SHALL CONFORM WITH THE AMERICANS FOR DISABILITIES ACT (2010 ADA STANDARDSFOR ACCESSIBLE DESIGN) WITH REGARDS TO ACCESSIBLE PARKING AND ACCESS.
- STATE PERMITS/APPROVALS: NHDES ALTERATION OF TERRAIN (AOT) PERMIT NO.: AOT-2471. DATED: 10/13/23. NHDES SEWER CONNECTION PERMIT NO.: D2024-0212, DATED: 4/19/24.
- SEE SHEET 15 OF 24 FOR NHDES / NH FISH & GAME (NHFG) PERMIT CONDITIONS & WILDLIFE PROTECTION NOTES.
- THE SITE IS SUBJECT TO NHDES GROUNDWATER MONITORING PERMIT (GMP) NO. GWP 199004021-C-005. SEE SHEET 8 OF 24 FOR RELATED NHDES AOT PERMIT CONDITIONS. NO EXCAVATION WORK WIHTIN THE BUILDING OR ON SITE SHALL TAKE PLACE WITHIN 10-FEET OF THE EXISTING 60" AND 24"x36" BRICK DRAIN LINES UNTIL THE PROPOSED CIPP LINING IS COMPLETED AND APPROVED BY THE CITY OF CONCORD ENGINEERING DEPARTMENT. SEE

SHEET 10 OF 24 FOR CIPP LINING SCOPE OF WORK. PRESENT OWNER OF RECORD: MAP 6442Z, LOTS 12 & 12-2 STICKNEY AVE, LLC

670 NORTH COMMERCIAL STREET MANCHESTER, NH 03101 BK 3819 PG 2284

9	3/14/25	MINOR SITE REVISIONS FOR ADMINISTRATIVE APPROVAL	TEZ
8	9/11/24	ADDRESS STAFF COMMENTS, ADD CIPP LINING SCOPE & REVISE EASEMENTS	TEZ
7	4/16/24	ADDRESS STAFF & NHDES COMMENTS	TEZ
6	1/31/24	ADDRESS STAFF COMMENTS	TEZ
1-5	-	SEE PREVIOUS PLAN REVISIONS ON FILE	TEZ
0 Z	DATE	REVISION	BY

MASTER SITE PLAN MAP 6442Z, LOTS 12 & 12-2)

7, 9, II & I3 STICKNEY AVENUE CONCORD, NEW HAMPSHIRE PREPARED FOR:



670 N. COMMERCIAL STREET, SUITE 303 MANCHESTER, NEW HAMPSHIRE RECORD OWNER:

40 METERS SCALE: 1"=40 Feet 1"=12.192 Meters

20 JULY 2022

L Hayner/Swanson, Inc. Civil Engineers/Land Surveyors

131 Middlesex Turnpike 3 Congress Street Nashua, NH 03062 Burlington, MA 01803 (781) 203-1501 (603) 883-2057 www.hayner-swanson.com

DRAWING NAME: 5800-SITE FQ43 TELD BOOK: 1262 5800 1 OF 24 RAWING LOC: J: \5000\5800\DWG\5800 SITE

10 60

CONCRETE CURBING

SYL

11

88888

₩

 \square PB

♣ ATC-6

SLOPE GRANITE CURBING

SIGN

—— UGE(c) —— UNDERGROUND ELECTRIC

=== STORM DRAIN & MANHOLE

GAS MAIN & GAS GATE

—— UGC(c) —— UNDERGROUND VIDEO CABLE

STORM DRAIN & CATCH BASIN

—S—— SANITARY SEWER & MANHOLE

DOUBLE YELLOW PAINT LINE

SINGLE YELLOW PAINT LINE

SINGLE WHITE PAINT LINE

STREET ADDRESS

STREET LIGHT

UTILITY PULL BOX

SIGNAL MAST ARM

WATER MAIN & HYDRANT

TREE/BRUSH LINE

CONIFEROUS TREE

DECIDUOUS TREE

TRAFFIC SIGNAL

PARKING SPACE COUNT

REINFORCED CONCRETE

PAVEMENT SAWCUT

WATER MAIN & GATE VALVE

(SEE NOTE 5 ON SHEET 2)

STORMWATER RUNOFF DIRECTION

PROPOSED FULL-DEPTH PAVEMENT

ITEMS TAKEN FROM KLEINFELDER SITE PLAN


-OHW ----- OVERHEAD ELECTRIC & TELEPHONE

ACCESSIBLE PARKING SPACE

DETECTABLE WARNING PANEL

UTILITY POLE WITH GUY SUPPORT

© Hayner/Swanson, Inc

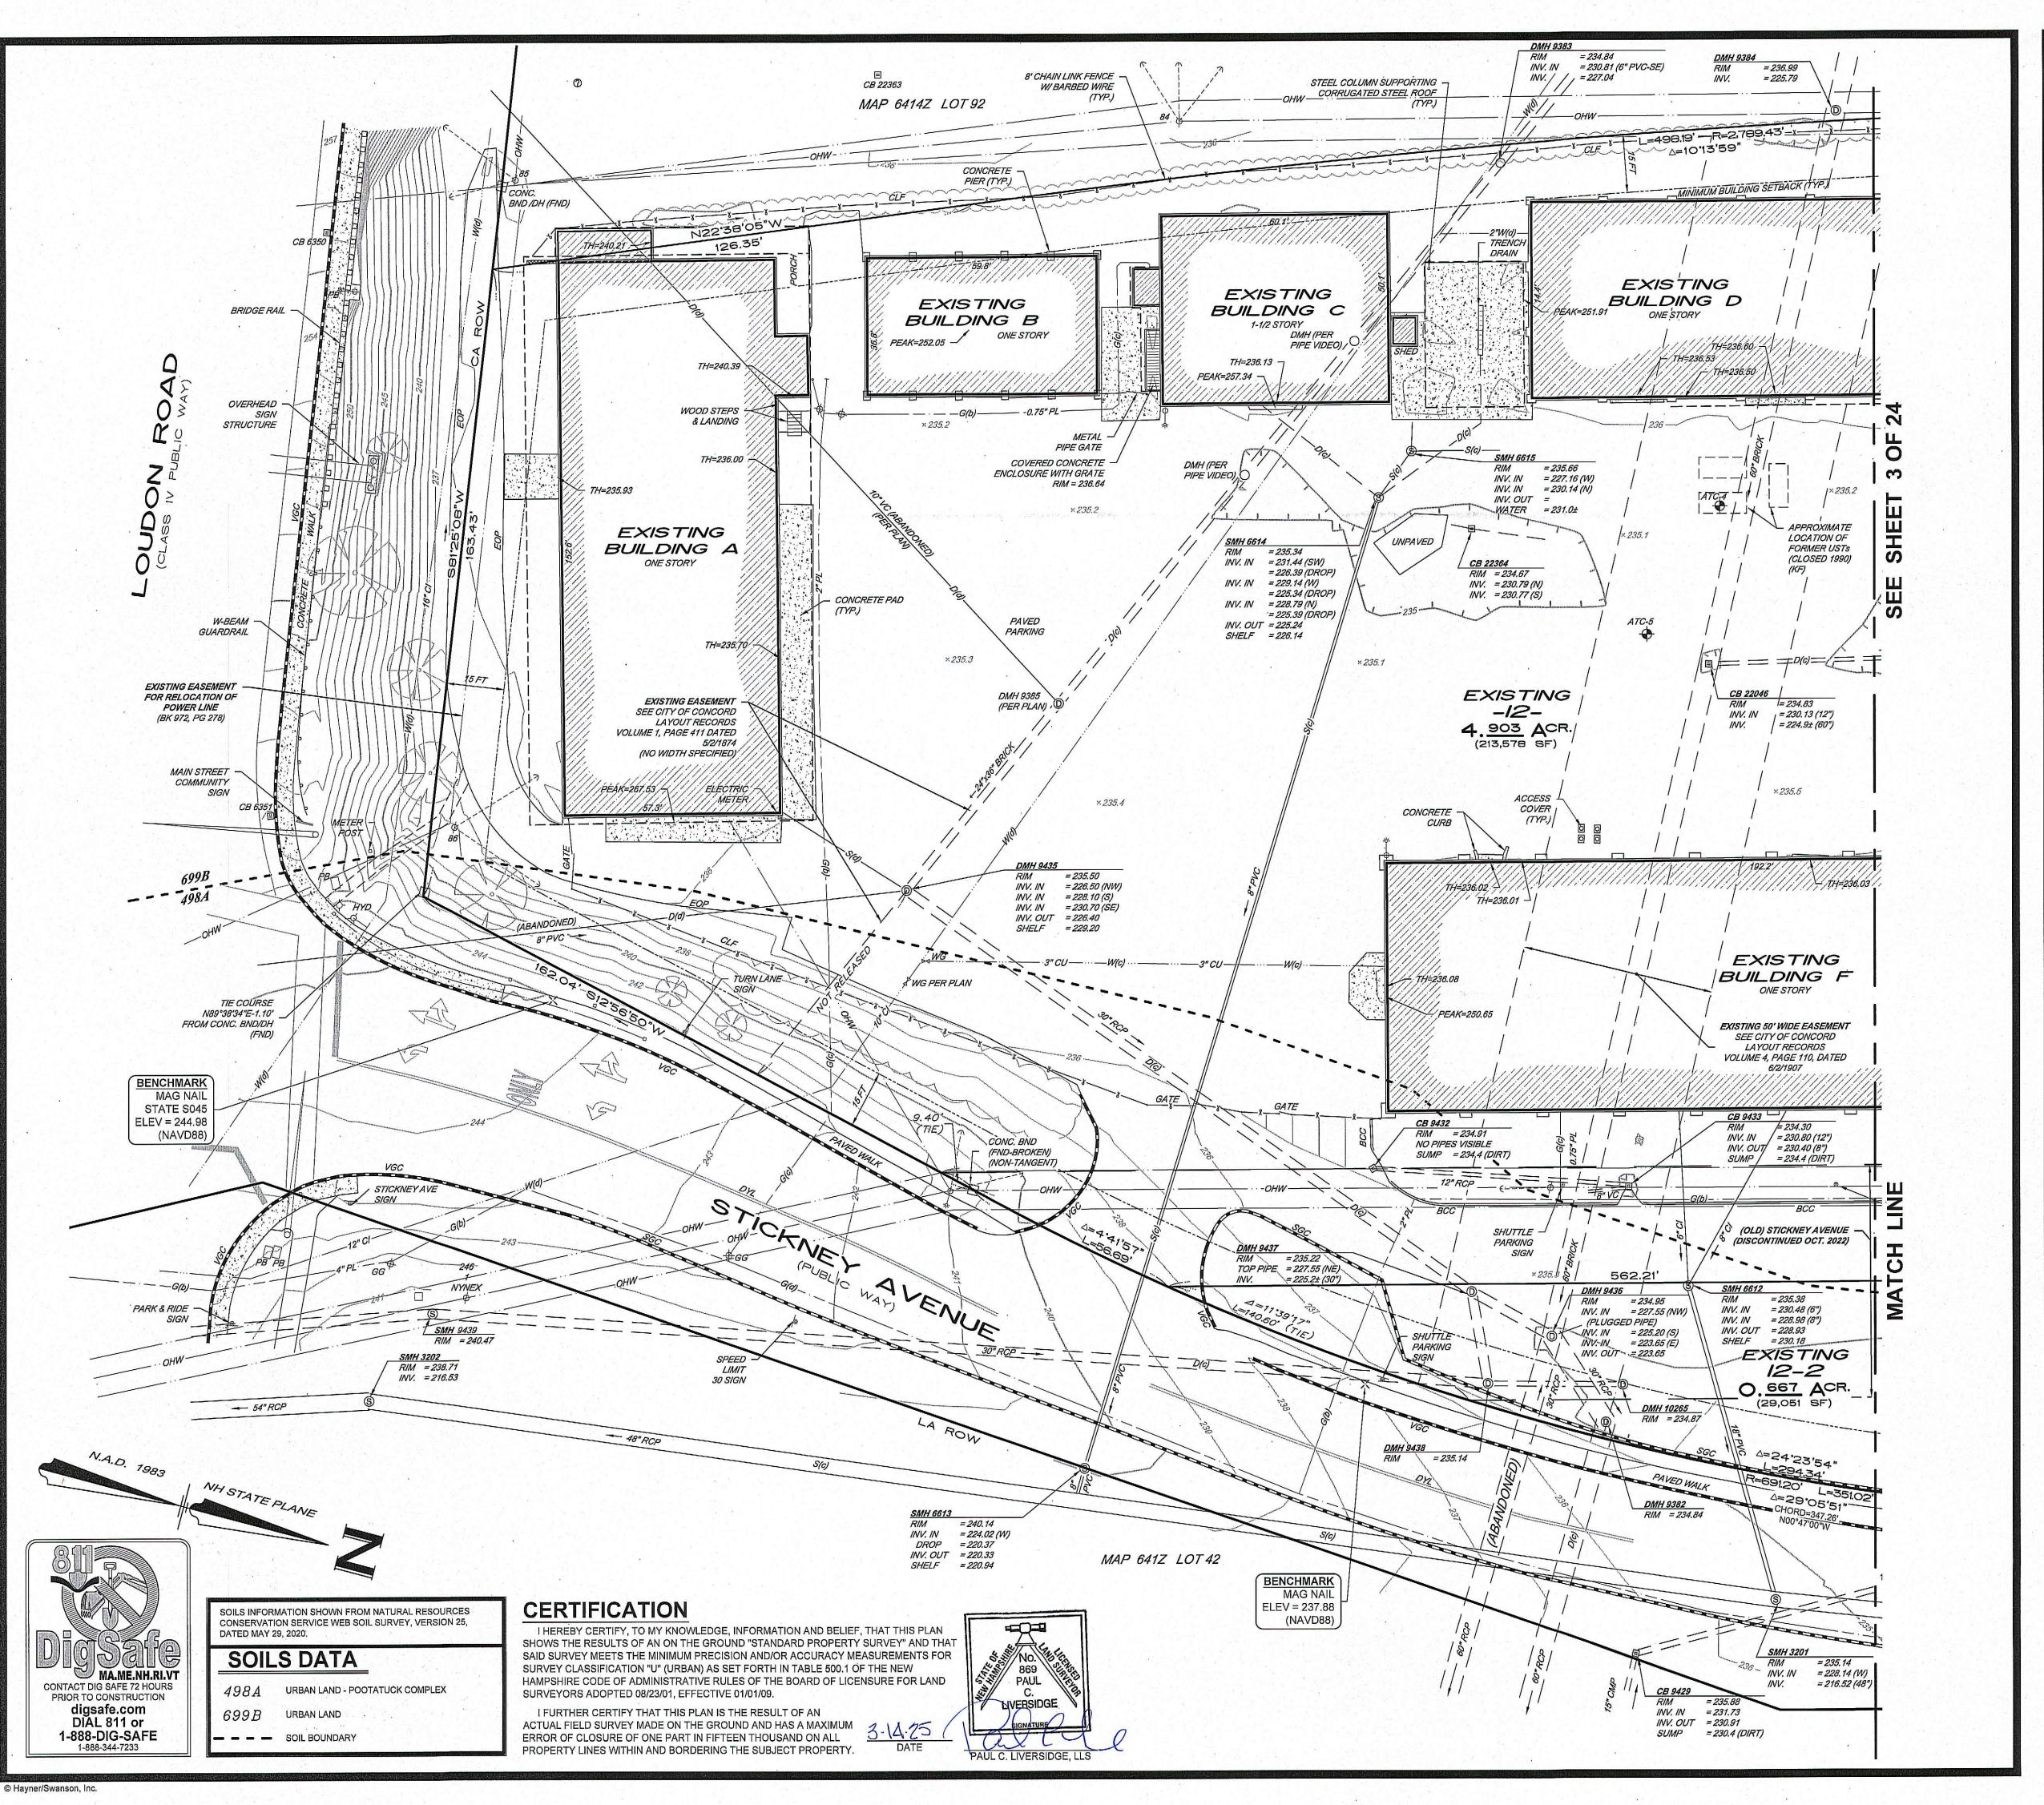

SURVEY NOTES:

- . BOUNDARY AND TOPOGRAPHIC INFORMATION IS BASED UPON A FIELD SURVEY PERFORMED BY THIS
- OFFICE IN JUNE & JULY 2021.

 2. SURVEY CONTROL INFORMATION:
 VERTICAL DATUM: NAVD88
 - VERTICAL DATUM: NAVD88
 HORIZONTAL DATUM: NAD83
 HORIZONTAL PROJECTION: NH STATE PLANE
- UNITS: US SURVEY FEET

 IT SHALL BE THE CONTRACTOR'S RESPONSIBILITY TO VERIFY THE ACCURACY OF THE EXISTING TOPOGRAPHY PRIOR TO EARTHWORK OPERATIONS. NO CLAIM FOR EXTRA WORK DUE TO
- THE CONTRACTOR SHALL ONLY USE BENCHMARKS AS PROVIDED BY THE ENGINEER
- 5. ITEMS IDENTIFIED WITH '(KF)', SUCH AS MONITORING WELLS AND USTS, ARE SHOWN AS DEPICTED ON A PLAN ENTITLED "SITE PLAN, NEWHAMPSHIRE DEPARTMENT OF TRANSPORTATION, HIGHWAY GARAGE 12, 11 STICKNEY AVENUE, CONCORD, NEW HAMPSHIRE, SCALE: 1" = 100', DATED 07-08-2021 AND PREPARED BY KLEINFELDER" AND WERE NOT LOCATED AS PART OF THIS SURVEY.

TOPOGRAPHIC INACCURACY SHALL BE CONSIDERED AFTER EARTHWORK HAS COMMENCED.

- 6. LOUDON ROAD (FORMERLY BRIDGE STREET) IS A CLASS IV PUBLIC RIGHT OF WAY CONVEYED BY THE STATE OF NEW HAMPSHIRE TO THE CITY OF CONCORD AT BOOK 1392, PAGE 864.
- 7. AT THEIR OCTOBER 11, 2022 MEETING, THE CONCORD CITY COUNCIL RESOLVED TO DISCONTINUE A PORTION OF (OLD) STICKNEY AVENUE. PRIVATE RIGHTS AND RIGHTS FOR PUBLIC UTILITIES MAY EXIST WITHIN THE FORMER LOCATION.
- B. THE PRESENT STICKNEY AVENUE WAS LAID OUT ACROSS LANDS OF THE STATE OF NEW HAMPSHIRE AND ACROSS PORTIONS OF (OLD) STICKNEY AVENUE AS A PART OF NH PROJECT NO. P-7002-A (INTERSTATE ROUTE 93). PER CORRESPONDENCE WITH THE CITY OF CONCORD ENGINEERING DEPARTMENT, THE CITY OF CONCORD CITY COUNCIL HAS NOT MADE A SPECIFIC ACCEPTANCE OF THE LAID-OUT LOCATION BY THE STATE OF NEW HAMPSHIRE. FURTHERMORE, THE CITY HAS NO RECORDS OF THE STATE OF NEW HAMPSHIRE RECLASSIFYING IT AND TURNING IT OVER TO THE CITY AS EITHER A CLASS IV OR V PUBLIC HIGHWAY
- 9. SEVERAL DRAIN MANHOLE STRUCTURES SHOWN ON THIS PLAN HAD SEWER COVERS AT TIME OF

EASEMENTS, RIGHTS & RESTRICTIONS:

- THE SUBJECT PROPERTY MAY BE SUBJECT TO THE FOLLOWING EASEMENT:
- A. GROUNDWATER MANAGEMENT ZONE AS REFERENCED IN DOCUMENT RECORDED NOVEMBER 8, 2000 AT BOOK 2230, PAGE 1107.
- 2. EASEMENTS, RIGHTS AND RESTRICTIONS LISTED ABOVE OR DEPICTED ON THIS PLAN ARE THOSE THAT WERE FOUND AT THE REGISTRY OF DEEDS FOR THE PURPOSES OF THE DETERMINATION AND LOCATION OF THE PROPERTY LINES OF THE SURVEYED PREMISES. EASEMENTS, RIGHTS AND RESTRICTIONS INCLUDING BUT NOT LIMITED TO UNWRITTEN RIGHTS MAY AFFECT THE PROPERTY. THE SURVEYOR MAKES NO PROFESSIONAL OPINION REGARDING TITLE, RIGHTS OR OWNERSHIP OF PROPERTY.

▶ UTILITY NOTE ◀

THE UNDERGROUND UTILITIES DEPICTED HEREON HAVE BEEN LOCATED FROM FIELD SURVEY INFORMATION AND PLOTTED FROM EXISTING DRAWINGS. THE SURVEYOR MAKES NO GUARANTEES THAT THE UNDERGROUND UTILITIES DEPICTED COMPRISE ALL SUCH UTILITIES IN THE AREA, EITHER IN SERVICE OR ABANDONED. THE SURVEYOR FURTHER DOES NOT WARRANT THAT THE UNDERGROUND UTILITIES SHOWN ARE IN THE EXACT LOCATION INDICATED ALTHOUGH THEY ARE LOCATED AS ACCURATELY AS POSSIBLE FROM THE INFORMATION AVAILABLE. THE SURVEYOR HAS NOT PHYSICALLY LOCATED THE UNDERGROUND PORTIONS OF THE UTILITIES.

► UTILITY QUALITY LEGEND ◀

SUBSURFACE UTILITIES AS DEPICTED ON THIS PLAN ARE IDENTIFIED BY QUALITY LEVELS DEFINED BY CI/ASCE 38-02 "ASCE STANDARD GUIDELINE FOR COLLECTION AND DEPICTION OF EXISTING SUBSURFACE UTILITY DATA"

LEVEL A (a) PRECISE HORIZONTAL AND VERTICAL LOCATION OF UTILITIES OBTAINED BY ACTUAL EXPOSURE AND SUBSEQUENT MEASUREMENTS OF SUBSURFACE

LEVEL B (b) INFORMATION OBTAINED THROUGH THE APPLICATION OF APPROPRIATE SURFACE GEOPHYSICAL METHODS TO DETERMINE THE EXISTENCE AND

APPROXIMATE HORIZONTAL POSITION OF SUBSURFACE UTILITIES. (IE. DIGSAFE)

LEVEL C (c) INFORMATION OBTAINED BY SURVEYING AND PLOTTING VISIBLE ABOVE—GROUND UTILITY FEATURES AND BY USING PROFESSIONAL JUDGEMENT IN CORRELATING THIS INFORMATION TO QUALITY LEVEL D INFORMATION.

LEVEL D (d) INFORMATION DERIVED FROM EXISTING RECORDS OR ORAL RECOLLECTIONS.

 9
 3/14/25
 MINOR SITE REVISIONS FOR ADMINISTRATIVE APPROVAL
 TEZ

 8
 9/11/24
 ADDRESS STAFF COMMENTS, ADD CIPP LINING SCOPE & REVISE EASEMENTS
 TEZ

 7
 4/16/24
 ADDRESS STAFF & NHDES COMMENTS
 TEZ

 6
 1/31/24
 ADDRESS STAFF COMMENTS
 TEZ

 1-5
 SEE PREVIOUS PLAN REVISIONS ON FILE
 TEZ

BY

20 METERS

2 OF 24

EXISTING CONDITIONS PLAN

No. DATE

5, 7, 9, II & I3 STICKNEY AVENUE CONCORD, NEW HAMPSHIRE

BRADY SULLIVAN

CORD OWNER:

670 N. COMMERCIAL STREET, SUITE 303 MANCHESTER, NEW HAMPSHIRE

WITH WITH WITHING

STICKNEY AVENUE, LLC

MMERCIAL STREET, SUITE 303 MANCHESTER, NEW HAMPSHIRE 03
20 0 20 40 60 80 FEET

SCALE: 1"=20 Feet 1"=6.096 Meters

20 JULY 2022





Civil Engineers/Land Surveyors
3 Congress Street 131 Middlesex Turnpike
Nashua, NH 03062 Burlington, MA 01803
(603) 883-2057 (781) 203-1501

FIELD BOOK: 1262 DRAWING NAME: 5800—SITE EC22

TELD BOOK: 1262 | DRAWING NAME: 5800—SITE EC22 | 5800


DRAWING LOC: J: \5000\5800\DWG\5800 SITE | File Number

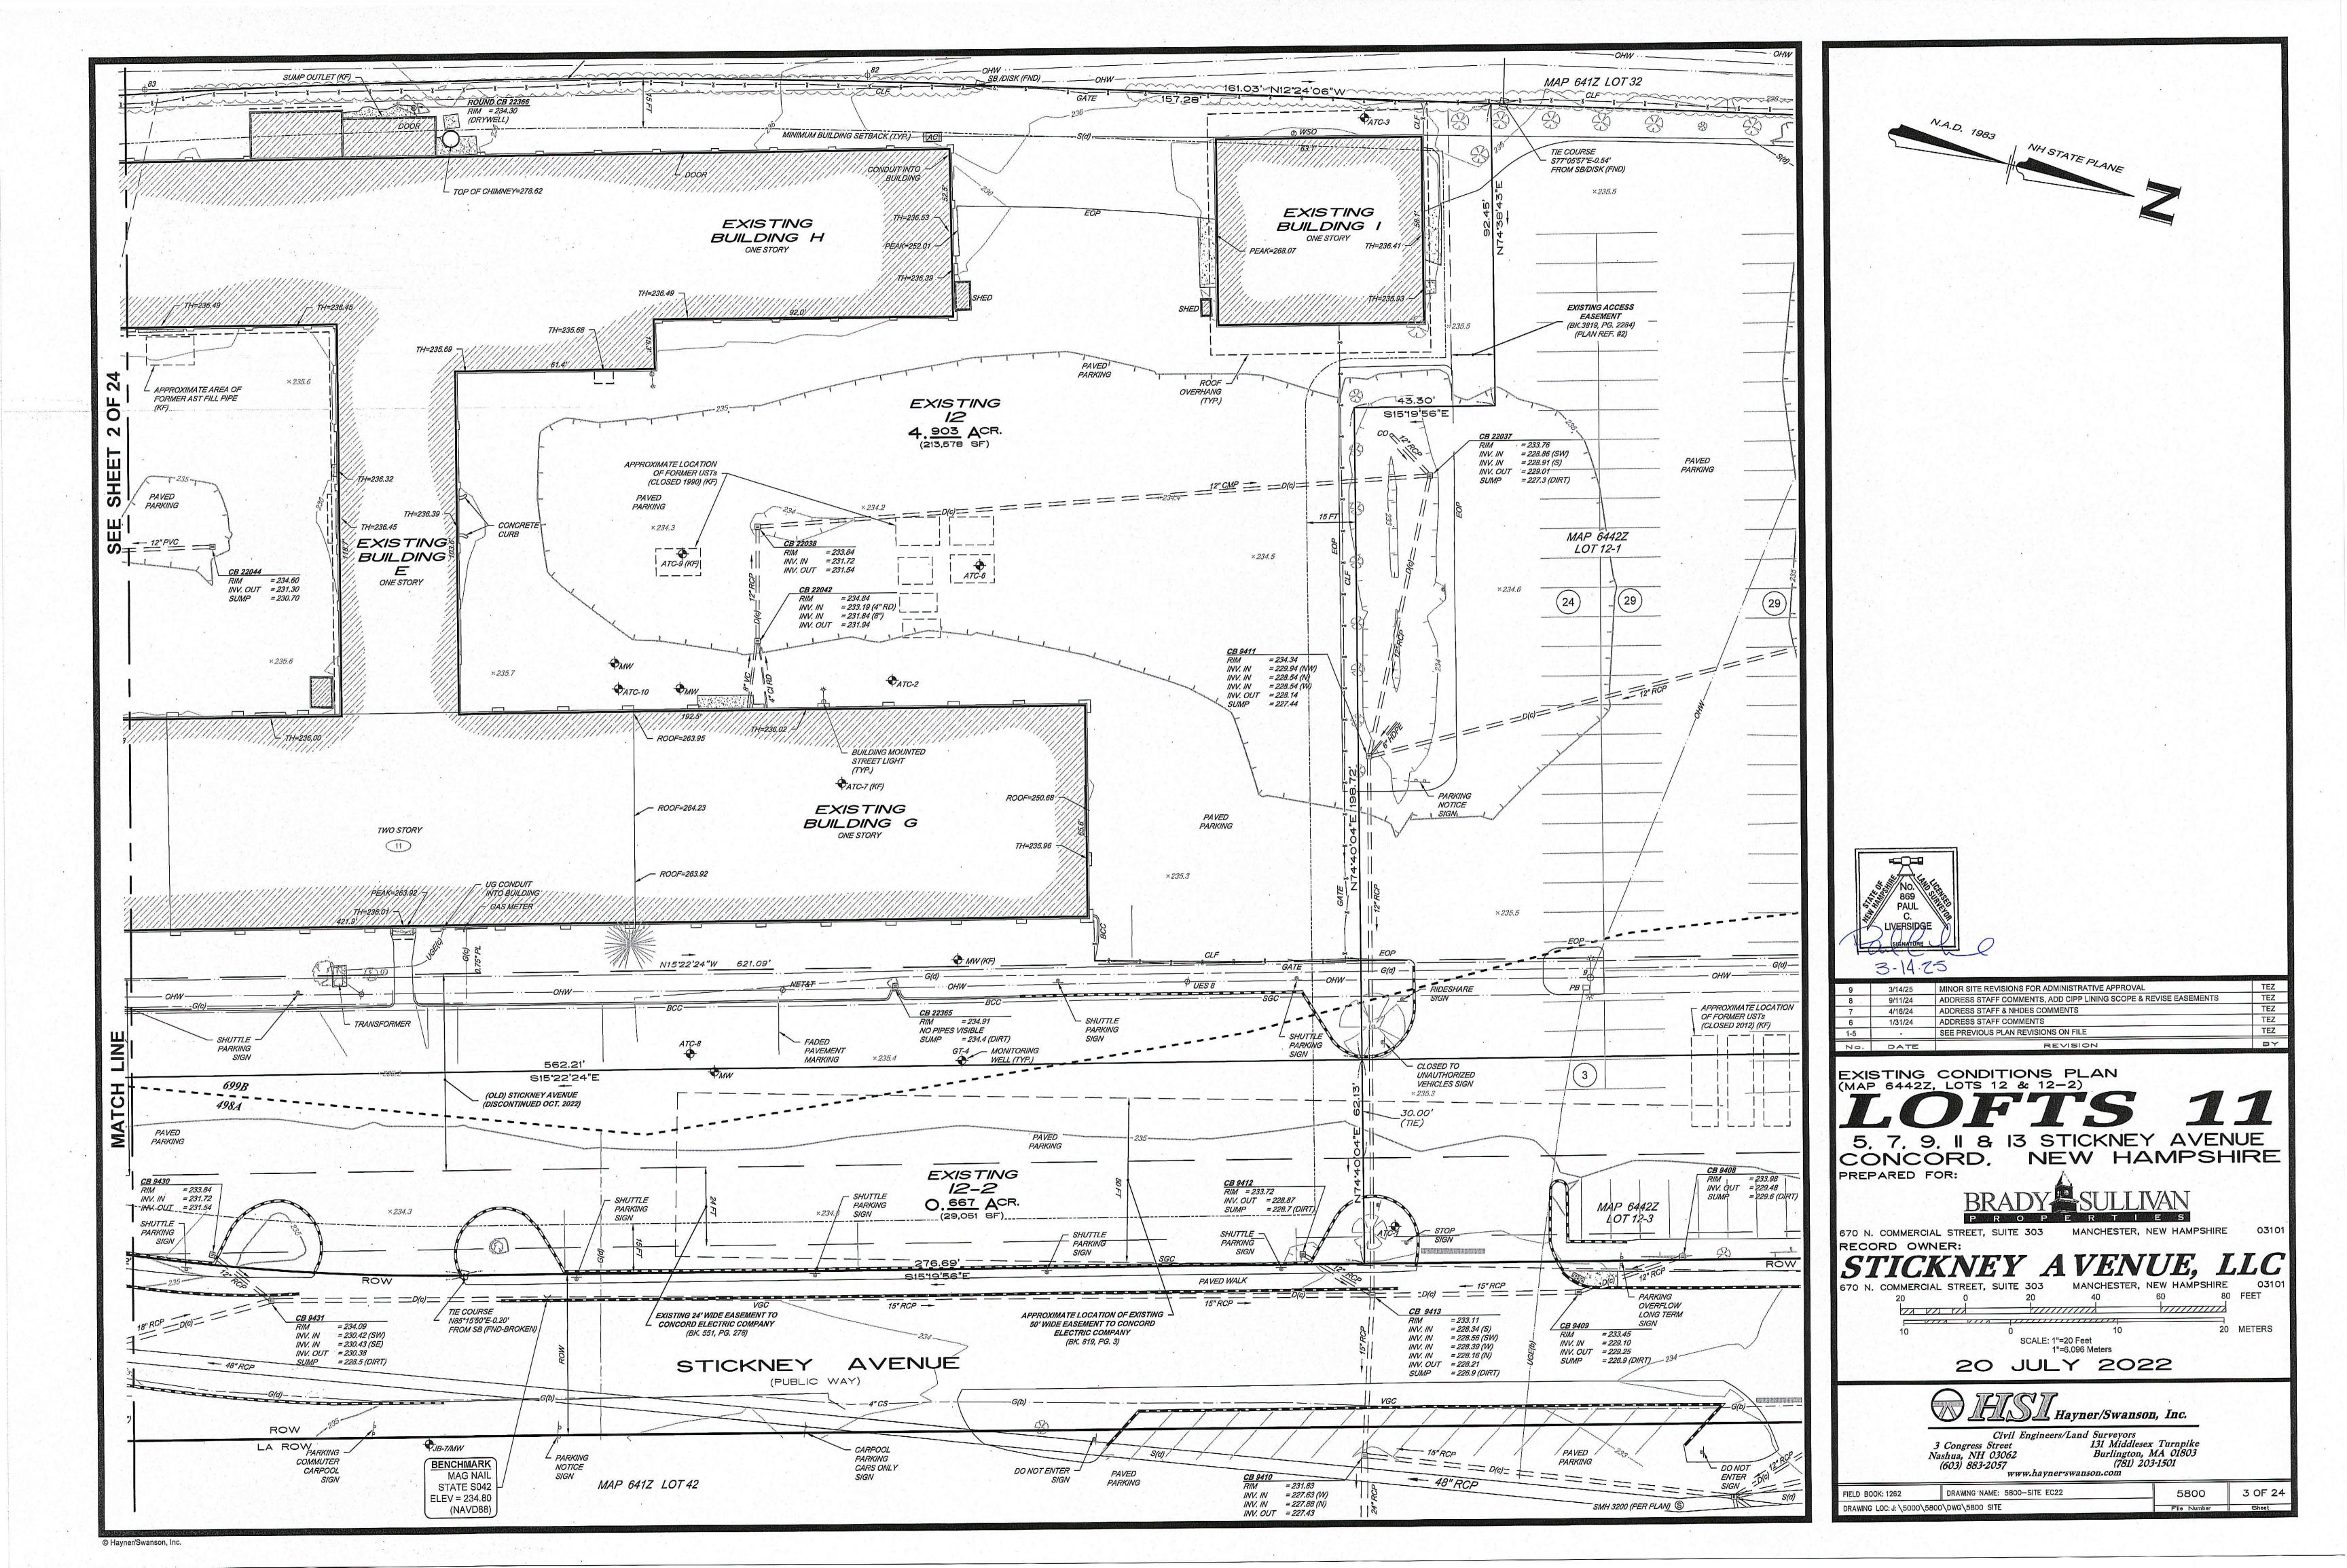

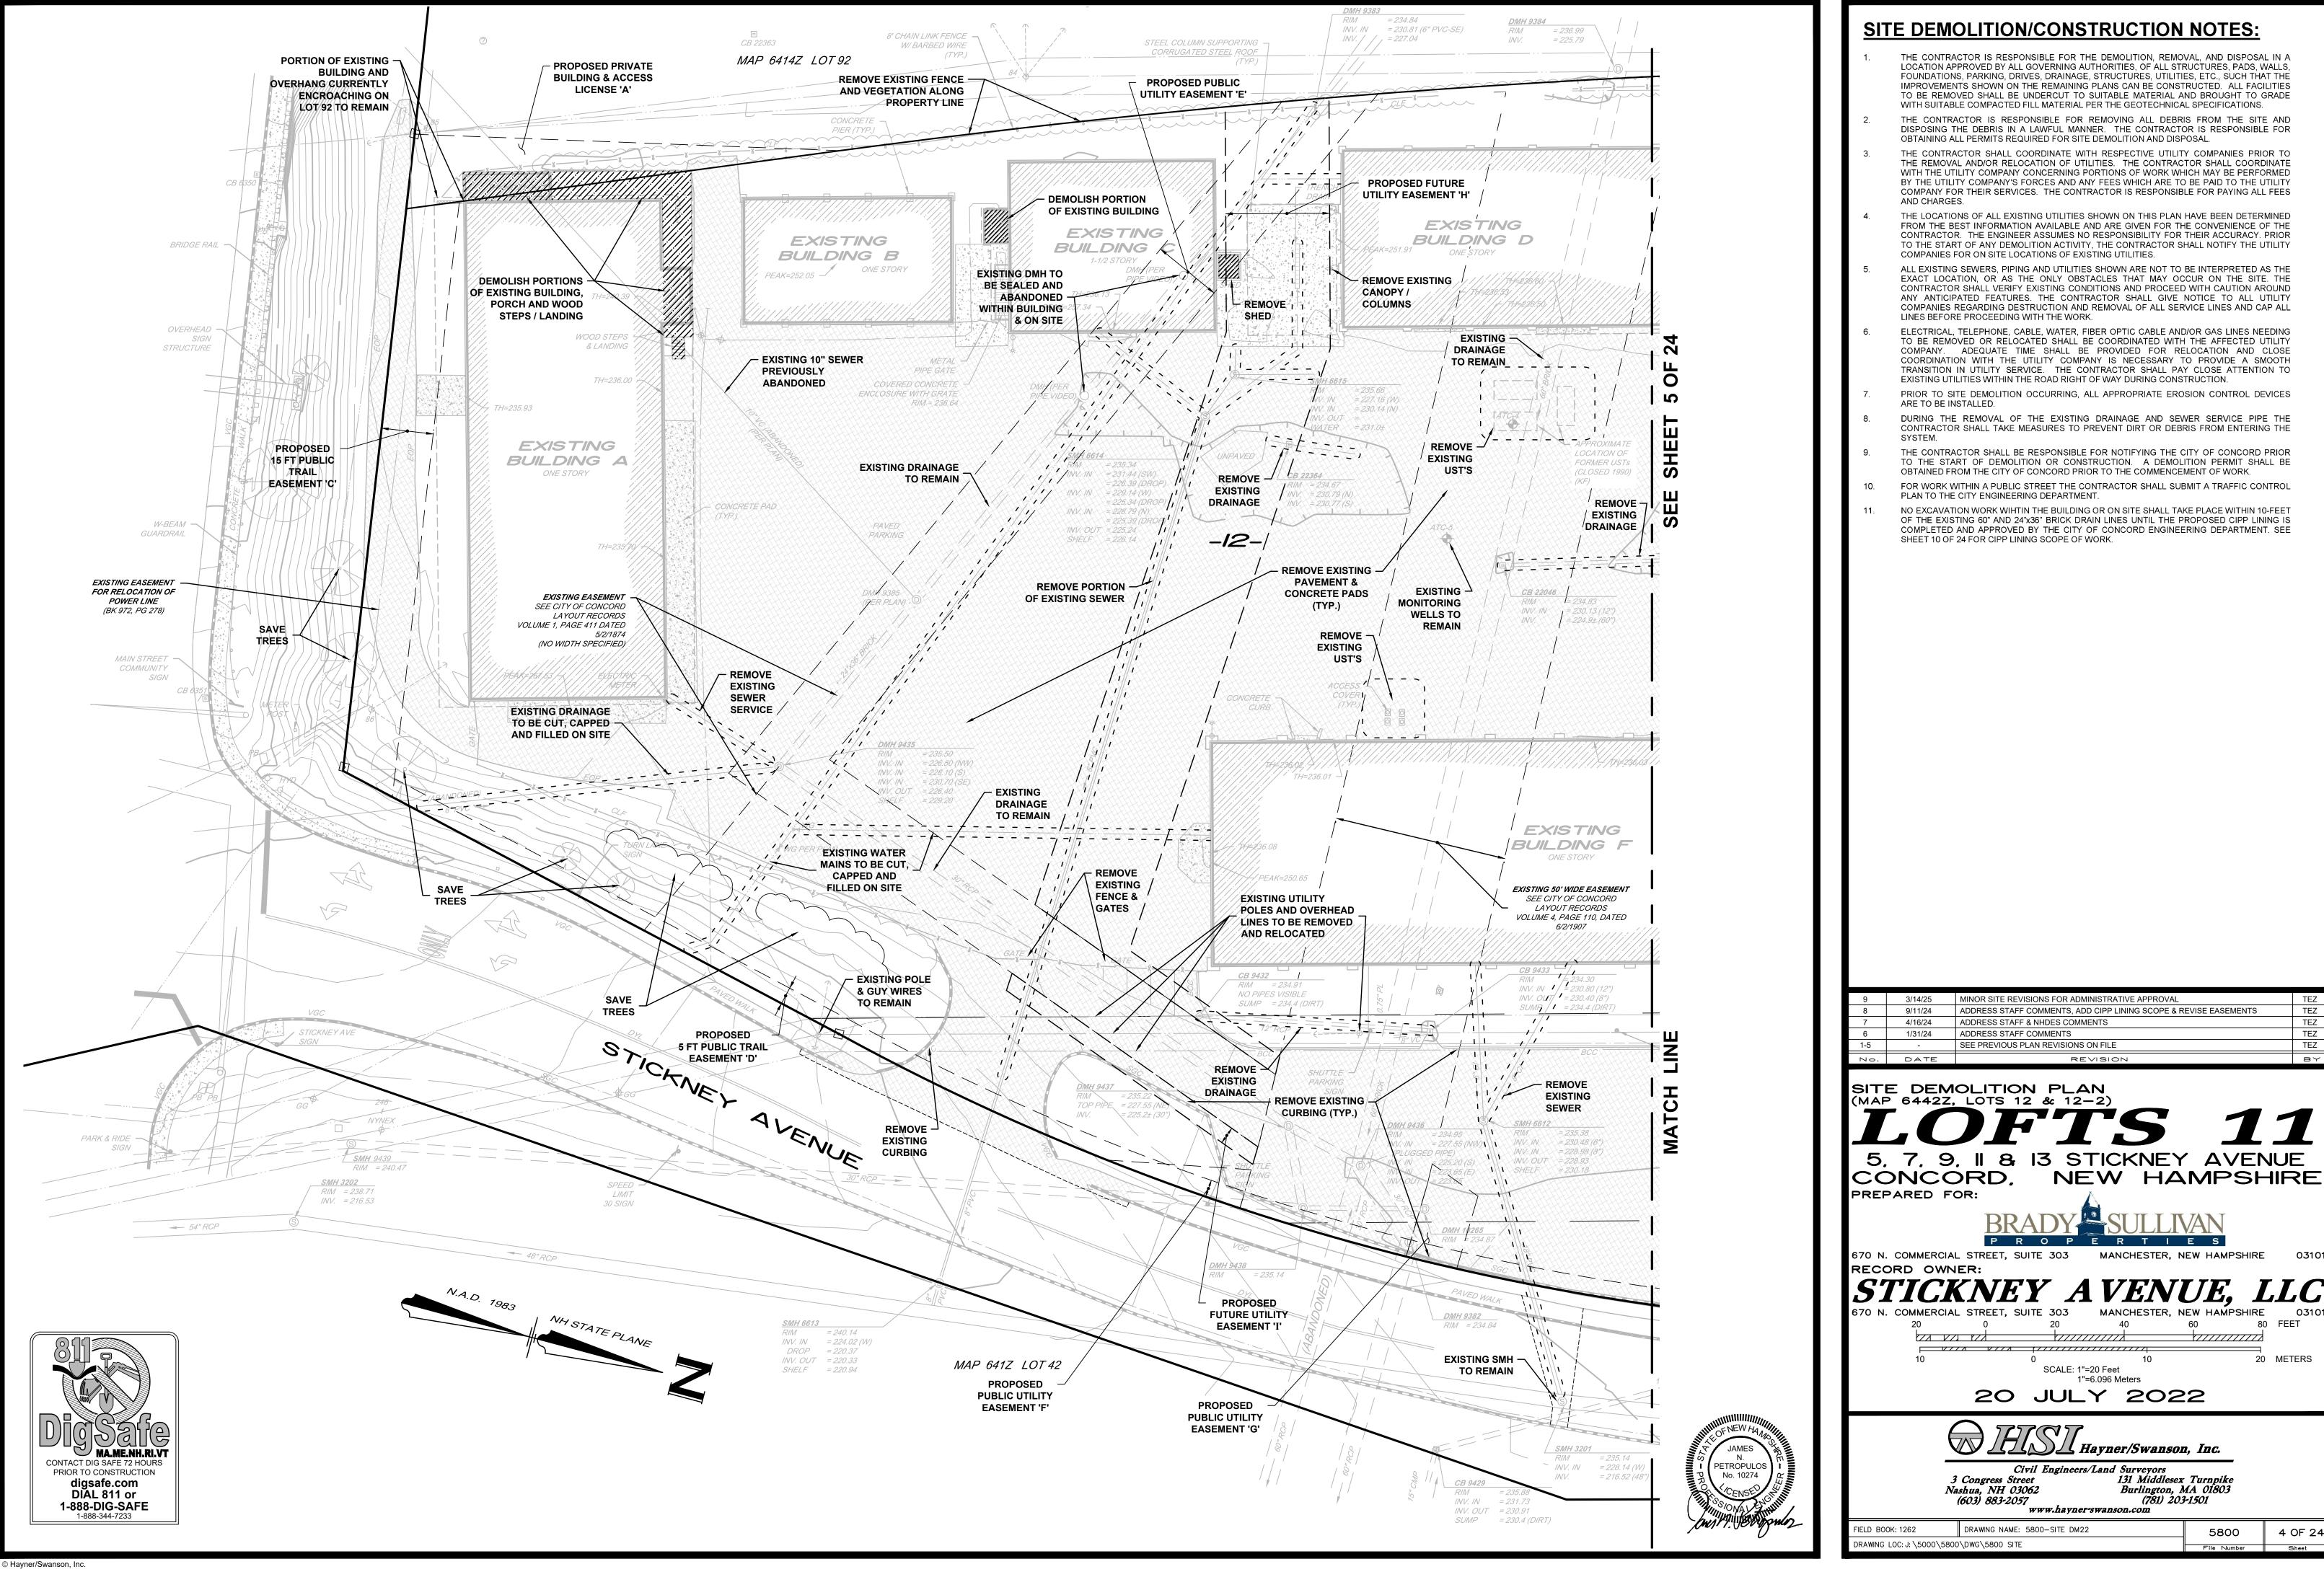

SITE DEMOLITION/CONSTRUCTION NOTES:

- THE CONTRACTOR IS RESPONSIBLE FOR THE DEMOLITION, REMOVAL, AND DISPOSAL IN A LOCATION APPROVED BY ALL GOVERNING AUTHORITIES. OF ALL STRUCTURES. PADS. WALLS. FOUNDATIONS, PARKING, DRIVES, DRAINAGE, STRUCTURES, UTILITIES, ETC., SUCH THAT THE IMPROVEMENTS SHOWN ON THE REMAINING PLANS CAN BE CONSTRUCTED. ALL FACILITIES TO BE REMOVED SHALL BE UNDERCUT TO SUITABLE MATERIAL AND BROUGHT TO GRADE WITH SUITABLE COMPACTED FILL MATERIAL PER THE GEOTECHNICAL SPECIFICATIONS.
- THE CONTRACTOR IS RESPONSIBLE FOR REMOVING ALL DEBRIS FROM THE SITE AND DISPOSING THE DEBRIS IN A LAWFUL MANNER. THE CONTRACTOR IS RESPONSIBLE FOR OBTAINING ALL PERMITS REQUIRED FOR SITE DEMOLITION AND DISPOSAL.
- THE CONTRACTOR SHALL COORDINATE WITH RESPECTIVE UTILITY COMPANIES PRIOR TO THE REMOVAL AND/OR RELOCATION OF UTILITIES. THE CONTRACTOR SHALL COORDINATE WITH THE UTILITY COMPANY CONCERNING PORTIONS OF WORK WHICH MAY BE PERFORMED BY THE UTILITY COMPANY'S FORCES AND ANY FEES WHICH ARE TO BE PAID TO THE UTILITY COMPANY FOR THEIR SERVICES. THE CONTRACTOR IS RESPONSIBLE FOR PAYING ALL FEES
- THE LOCATIONS OF ALL EXISTING UTILITIES SHOWN ON THIS PLAN HAVE BEEN DETERMINED FROM THE BEST INFORMATION AVAILABLE AND ARE GIVEN FOR THE CONVENIENCE OF THE CONTRACTOR. THE ENGINEER ASSUMES NO RESPONSIBILITY FOR THEIR ACCURACY. PRIOR TO THE START OF ANY DEMOLITION ACTIVITY, THE CONTRACTOR SHALL NOTIFY THE UTILITY
- ALL EXISTING SEWERS, PIPING AND UTILITIES SHOWN ARE NOT TO BE INTERPRETED AS THE EXACT LOCATION, OR AS THE ONLY OBSTACLES THAT MAY OCCUR ON THE SITE. THE CONTRACTOR SHALL VERIFY EXISTING CONDITIONS AND PROCEED WITH CAUTION AROUND ANY ANTICIPATED FEATURES. THE CONTRACTOR SHALL GIVE NOTICE TO ALL UTILITY COMPANIES REGARDING DESTRUCTION AND REMOVAL OF ALL SERVICE LINES AND CAP ALL
- TO BE REMOVED OR RELOCATED SHALL BE COORDINATED WITH THE AFFECTED UTILITY COMPANY. ADEQUATE TIME SHALL BE PROVIDED FOR RELOCATION AND CLOSE COORDINATION WITH THE UTILITY COMPANY IS NECESSARY TO PROVIDE A SMOOTH TRANSITION IN UTILITY SERVICE. THE CONTRACTOR SHALL PAY CLOSE ATTENTION TO EXISTING UTILITIES WITHIN THE ROAD RIGHT OF WAY DURING CONSTRUCTION.
 - PRIOR TO SITE DEMOLITION OCCURRING, ALL APPROPRIATE EROSION CONTROL DEVICES
- DURING THE REMOVAL OF THE EXISTING DRAINAGE AND SEWER SERVICE PIPE THE CONTRACTOR SHALL TAKE MEASURES TO PREVENT DIRT OR DEBRIS FROM ENTERING THE
- THE CONTRACTOR SHALL BE RESPONSIBLE FOR NOTIFYING THE CITY OF CONCORD PRIOR TO THE START OF DEMOLITION OR CONSTRUCTION. A DEMOLITION PERMIT SHALL BE OBTAINED FROM THE CITY OF CONCORD PRIOR TO THE COMMENCEMENT OF WORK.
- FOR WORK WITHIN A PUBLIC STREET THE CONTRACTOR SHALL SUBMIT A TRAFFIC CONTROL
- NO EXCAVATION WORK WIHTIN THE BUILDING OR ON SITE SHALL TAKE PLACE WITHIN 10-FEET OF THE EXISTING 60" AND 24"x36" BRICK DRAIN LINES UNTIL THE PROPOSED CIPP LINING IS COMPLETED AND APPROVED BY THE CITY OF CONCORD ENGINEERING DEPARTMENT. SEE

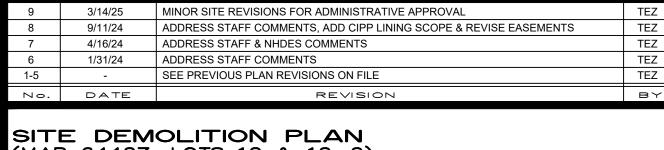

7, 9, II & I3 STICKNEY AVENUE

670 N. COMMERCIAL STREET, SUITE 303 MANCHESTER, NEW HAMPSHIRE


20 METERS SCALE: 1"=20 Feet


20 JULY 2022

Hayner/Swanson, Inc.

131 Middlesex Turnpike Burlington, MA 01803 (781) 203-1501 www.hayner-swanson.com

5800

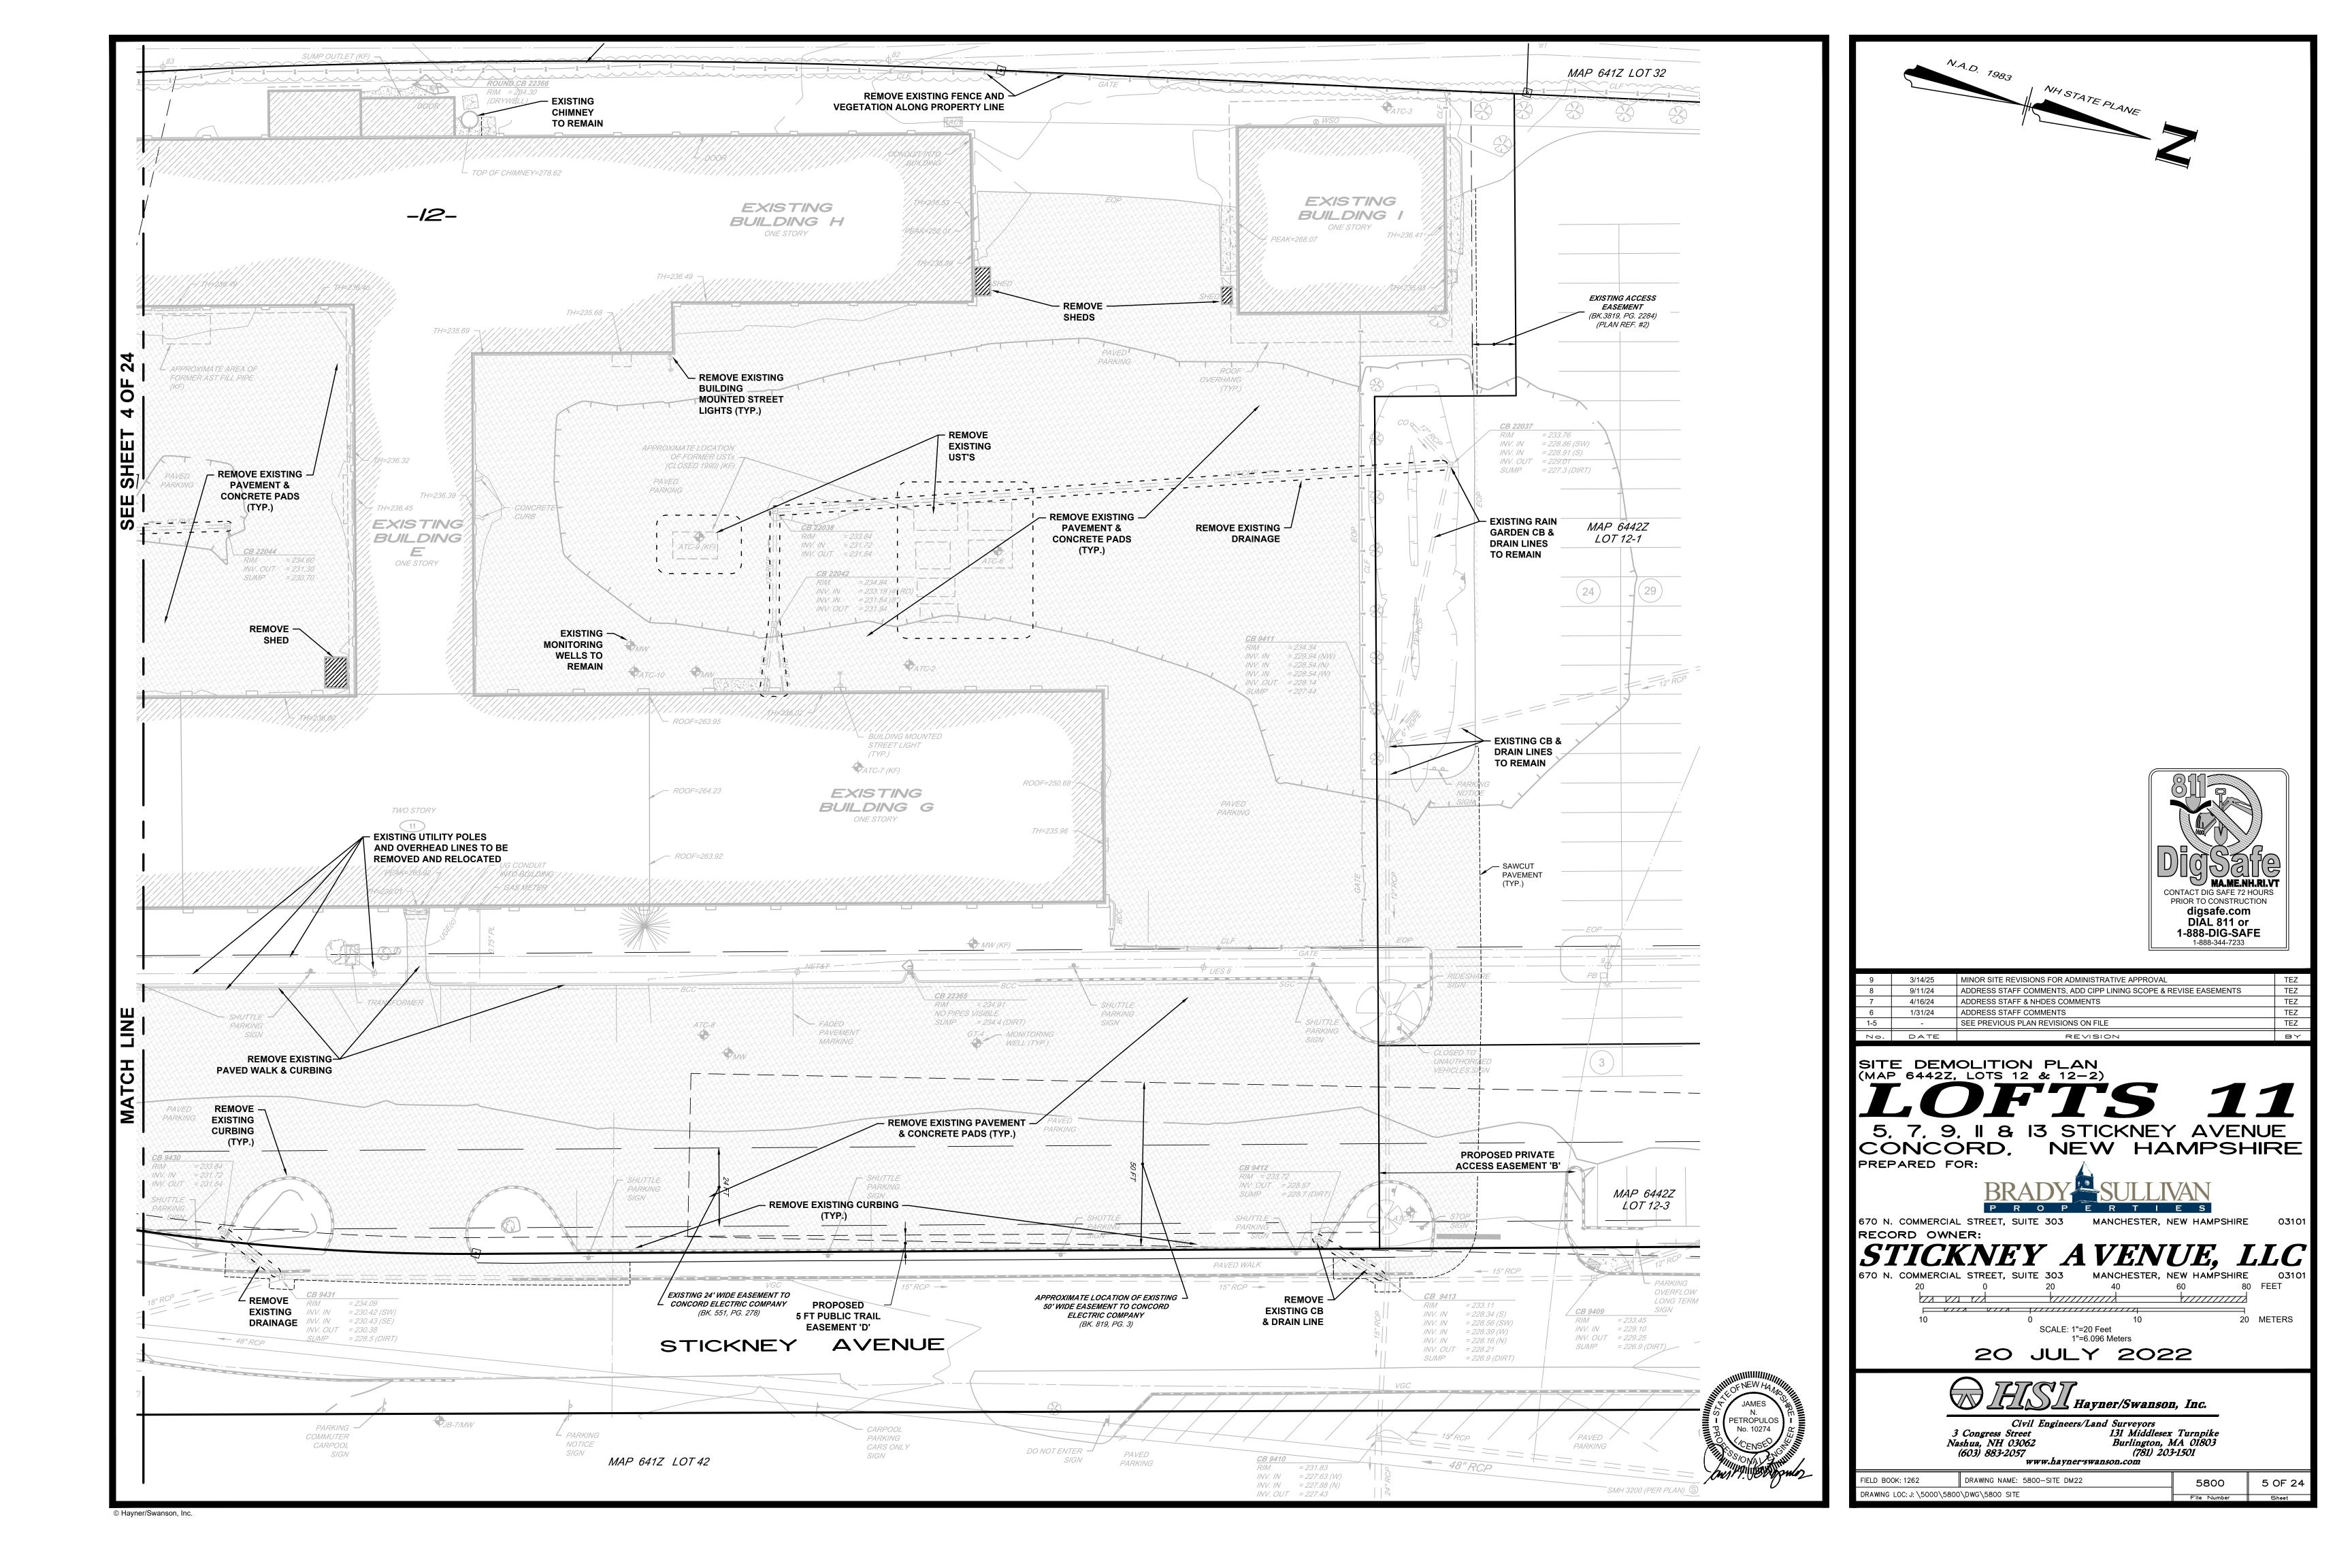

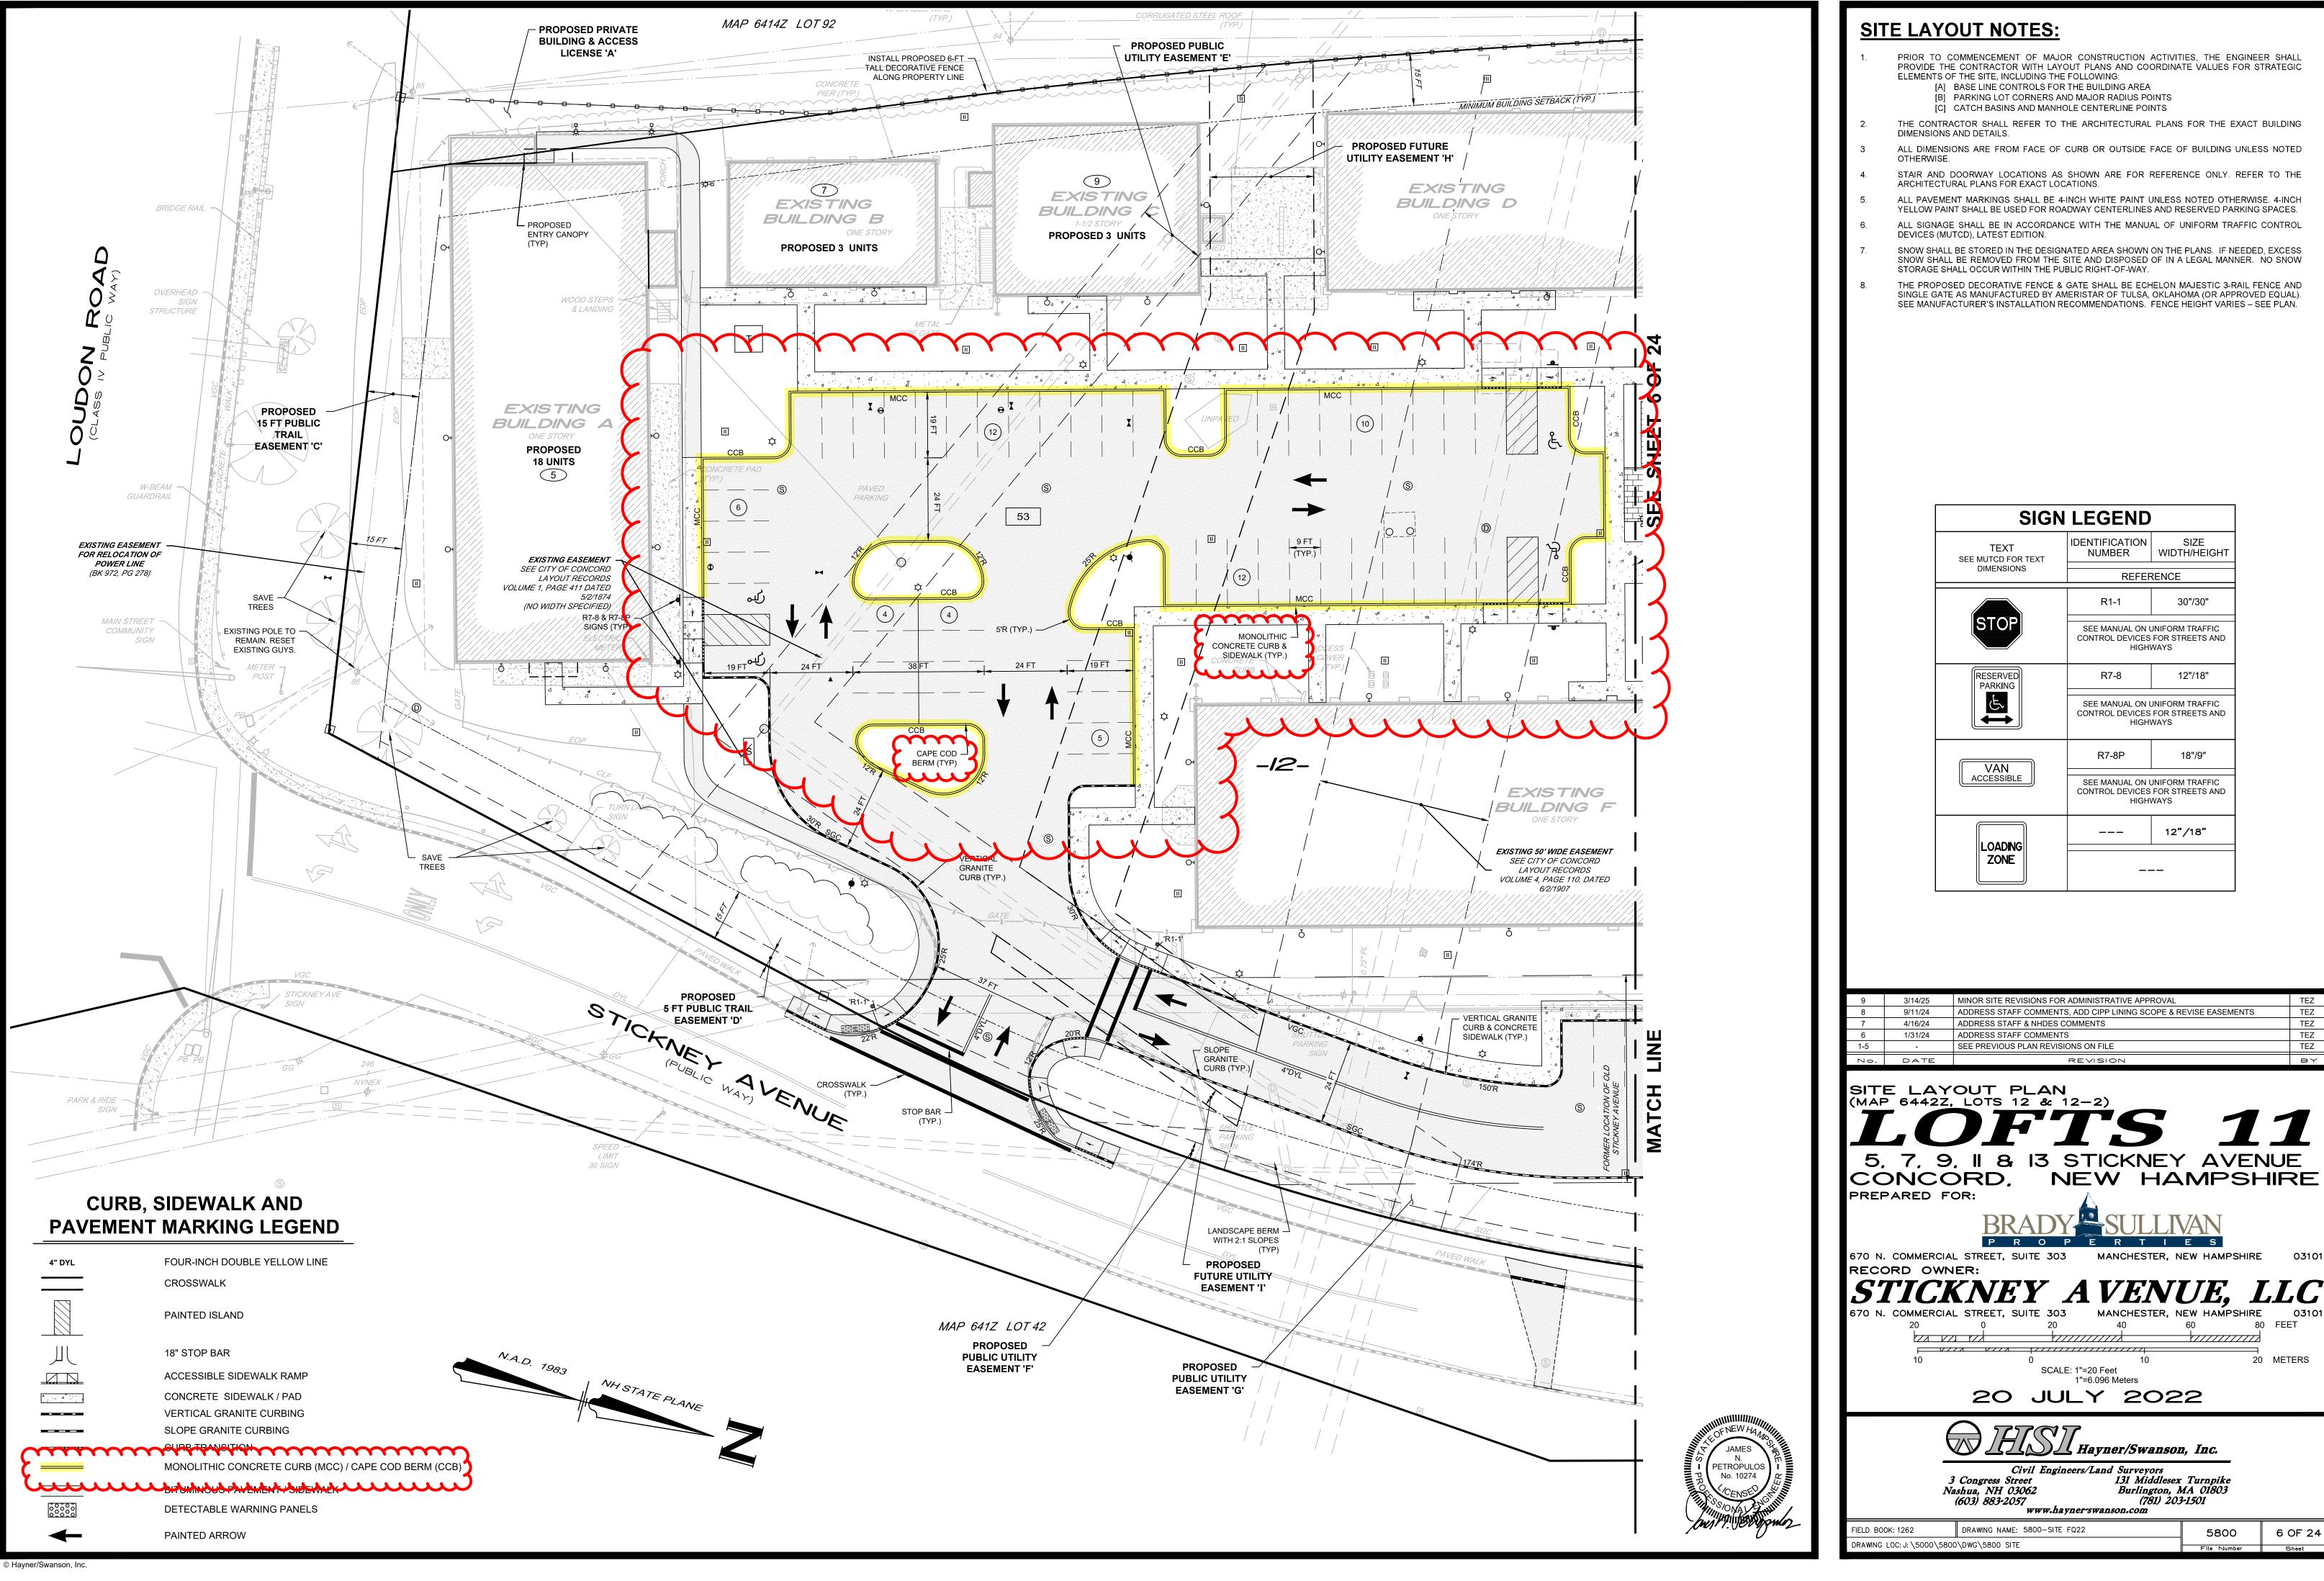

PRIOR TO COMMENCEMENT OF MAJOR CONSTRUCTION ACTIVITIES, THE ENGINEER SHALL PROVIDE THE CONTRACTOR WITH LAYOUT PLANS AND COORDINATE VALUES FOR STRATEGIC

THE CONTRACTOR SHALL REFER TO THE ARCHITECTURAL PLANS FOR THE EXACT BUILDING

ALL DIMENSIONS ARE FROM FACE OF CURB OR OUTSIDE FACE OF BUILDING UNLESS NOTED

STAIR AND DOORWAY LOCATIONS AS SHOWN ARE FOR REFERENCE ONLY. REFER TO THE

ALL PAVEMENT MARKINGS SHALL BE 4-INCH WHITE PAINT UNLESS NOTED OTHERWISE. 4-INCH

ALL SIGNAGE SHALL BE IN ACCORDANCE WITH THE MANUAL OF UNIFORM TRAFFIC CONTROL


SIGN	SIGN LEGEND		
TEXT SEE MUTCD FOR TEXT	IDENTIFICATION NUMBER	SIZE WIDTH/HEIGHT	
DIMENSIONS	REFEF	RENCE	
	R1-1	30"/30"	
STOP	SEE MANUAL ON UNIFORM TRAFFIC CONTROL DEVICES FOR STREETS AND HIGHWAYS		
RESERVED PARKING	R7-8	12"/18"	
₹	SEE MANUAL ON UNIFORM TRAFFIC CONTROL DEVICES FOR STREETS AND HIGHWAYS		
VAN	R7-8P	18"/9"	
ACCESSIBLE	SEE MANUAL ON U CONTROL DEVICES HIGH	FOR STREETS AND	
LOADNIC		12"/18"	
LOADING			


9	3/14/25	MINOR SITE REVISIONS FOR ADMINISTRATIVE APPROVAL	TEZ
8	9/11/24	ADDRESS STAFF COMMENTS, ADD CIPP LINING SCOPE & REVISE EASEMENTS	TEZ
7	4/16/24	ADDRESS STAFF & NHDES COMMENTS	TEZ
6	1/31/24	ADDRESS STAFF COMMENTS	TEZ
1-5	-	SEE PREVIOUS PLAN REVISIONS ON FILE	TEZ
0. Z	DATE	REVISION	BY

670 N. COMMERCIAL STREET, SUITE 303 MANCHESTER, NEW HAMPSHIRE

20 METERS



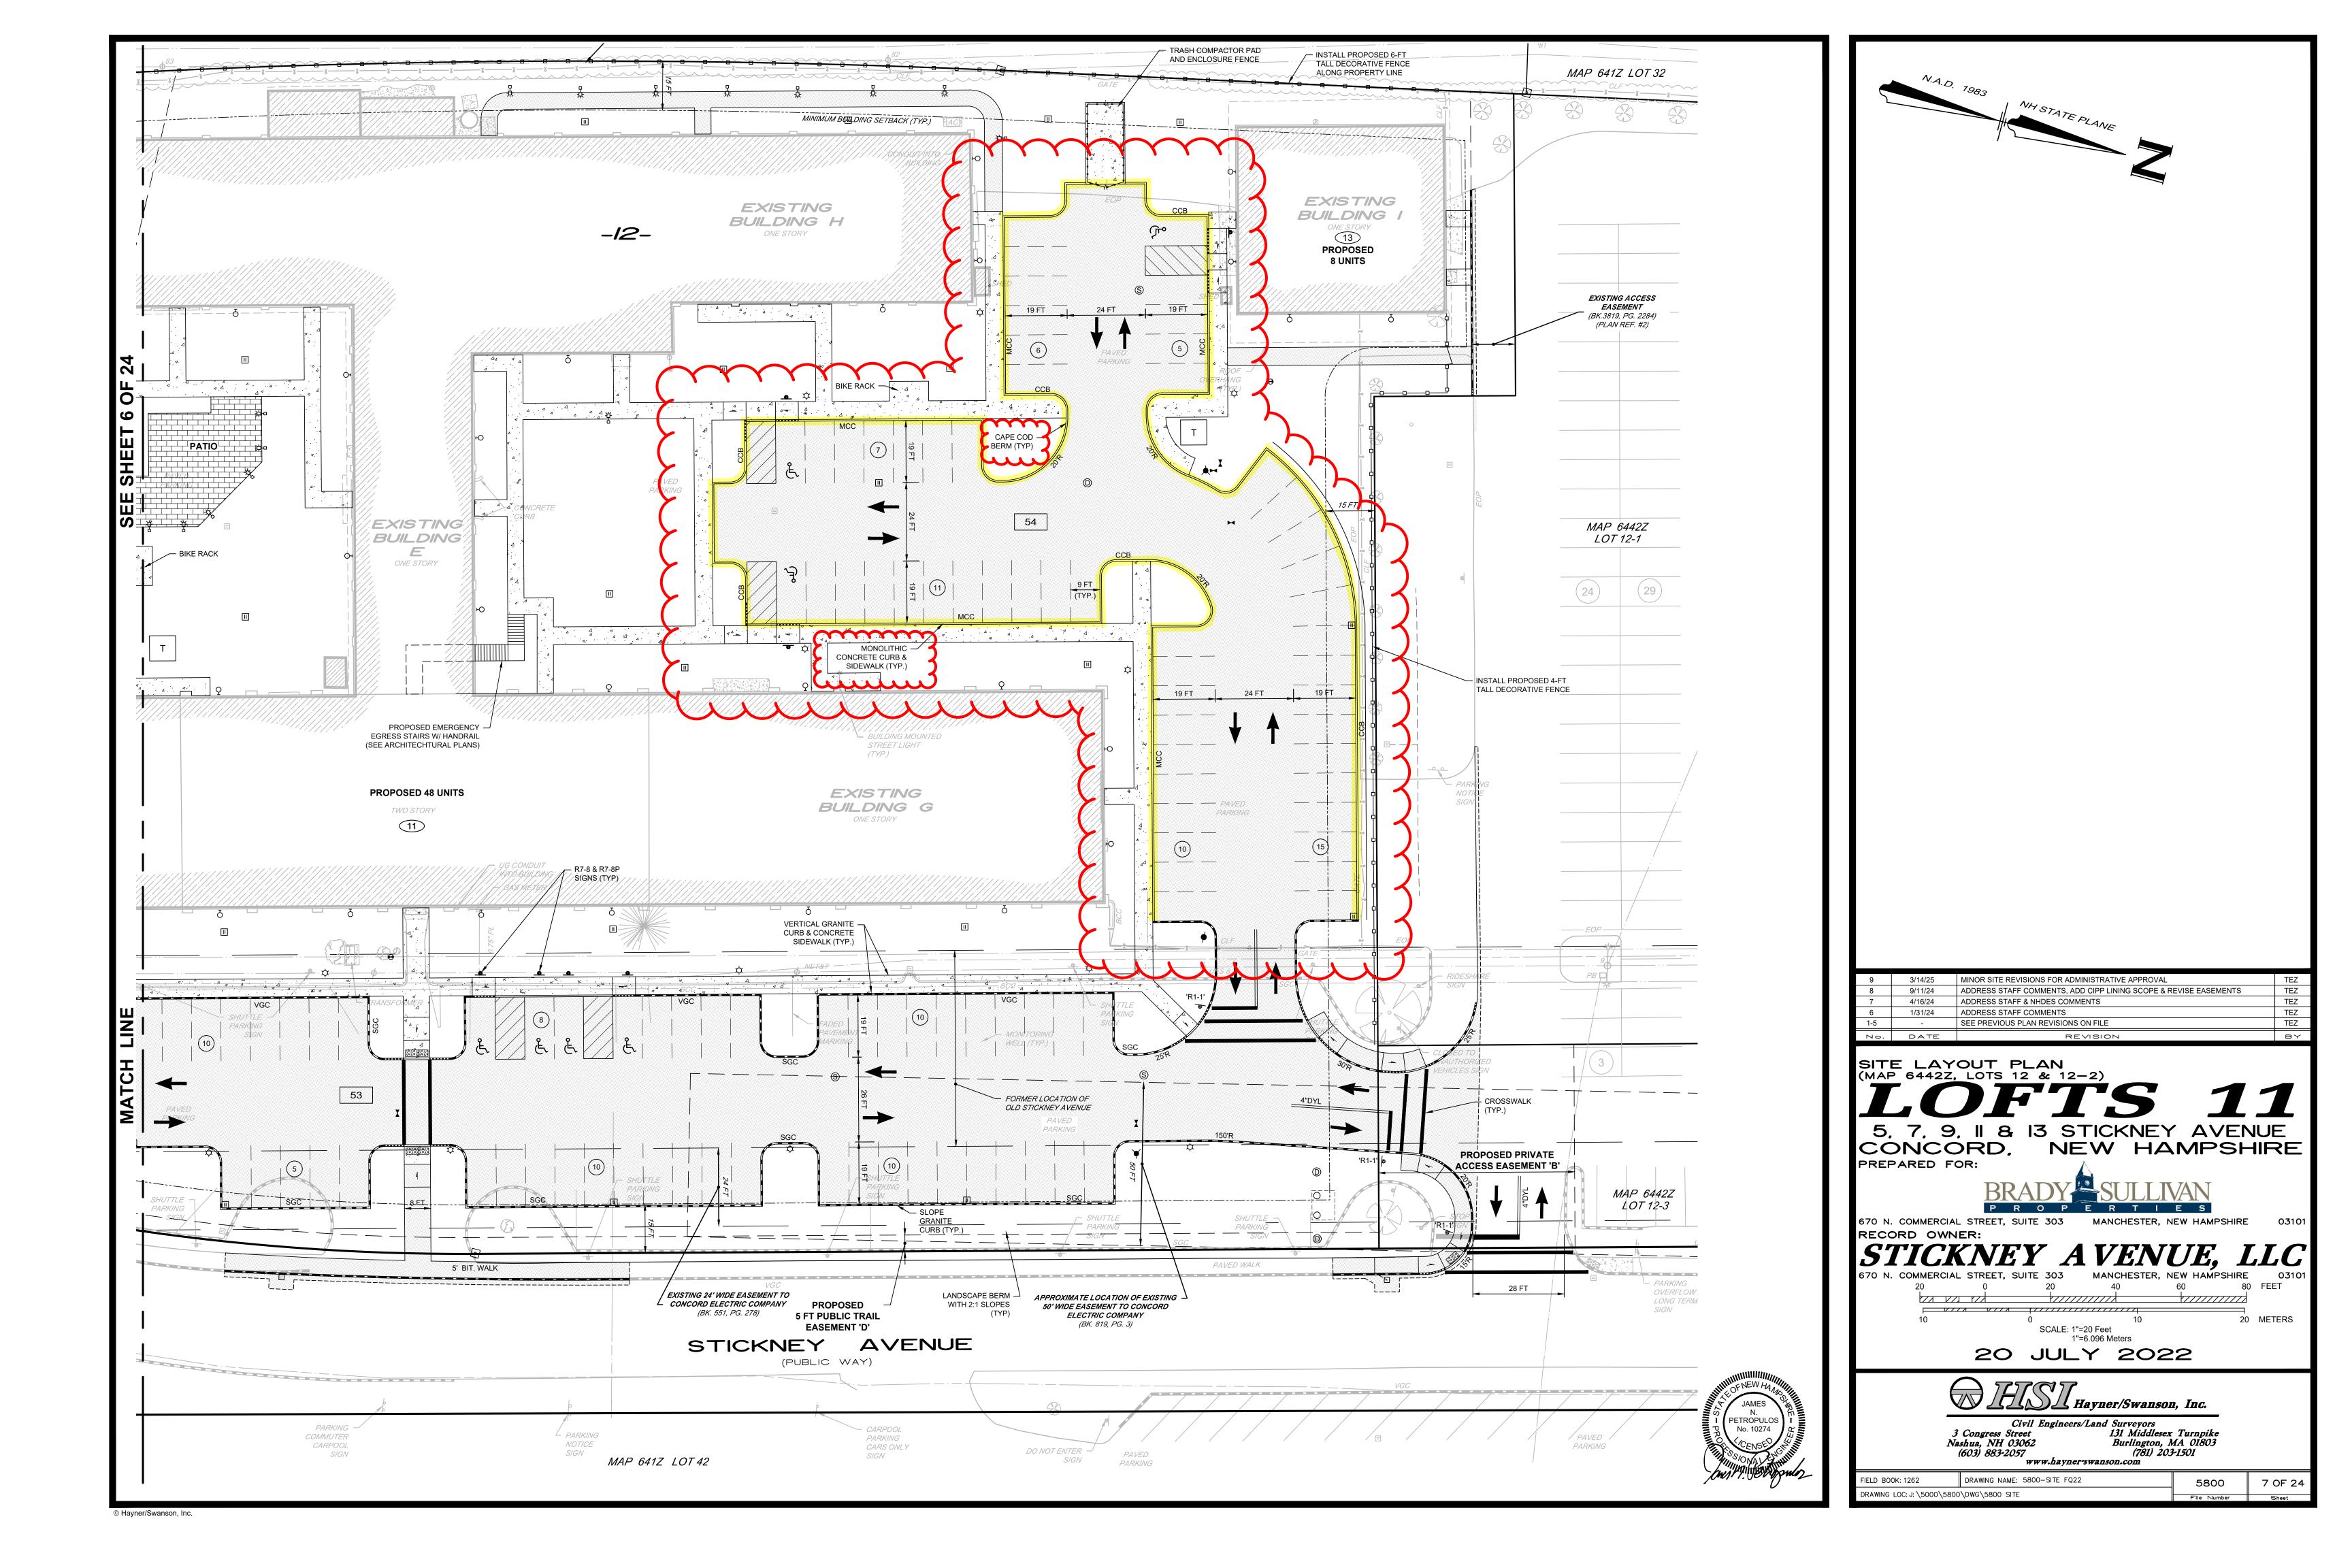

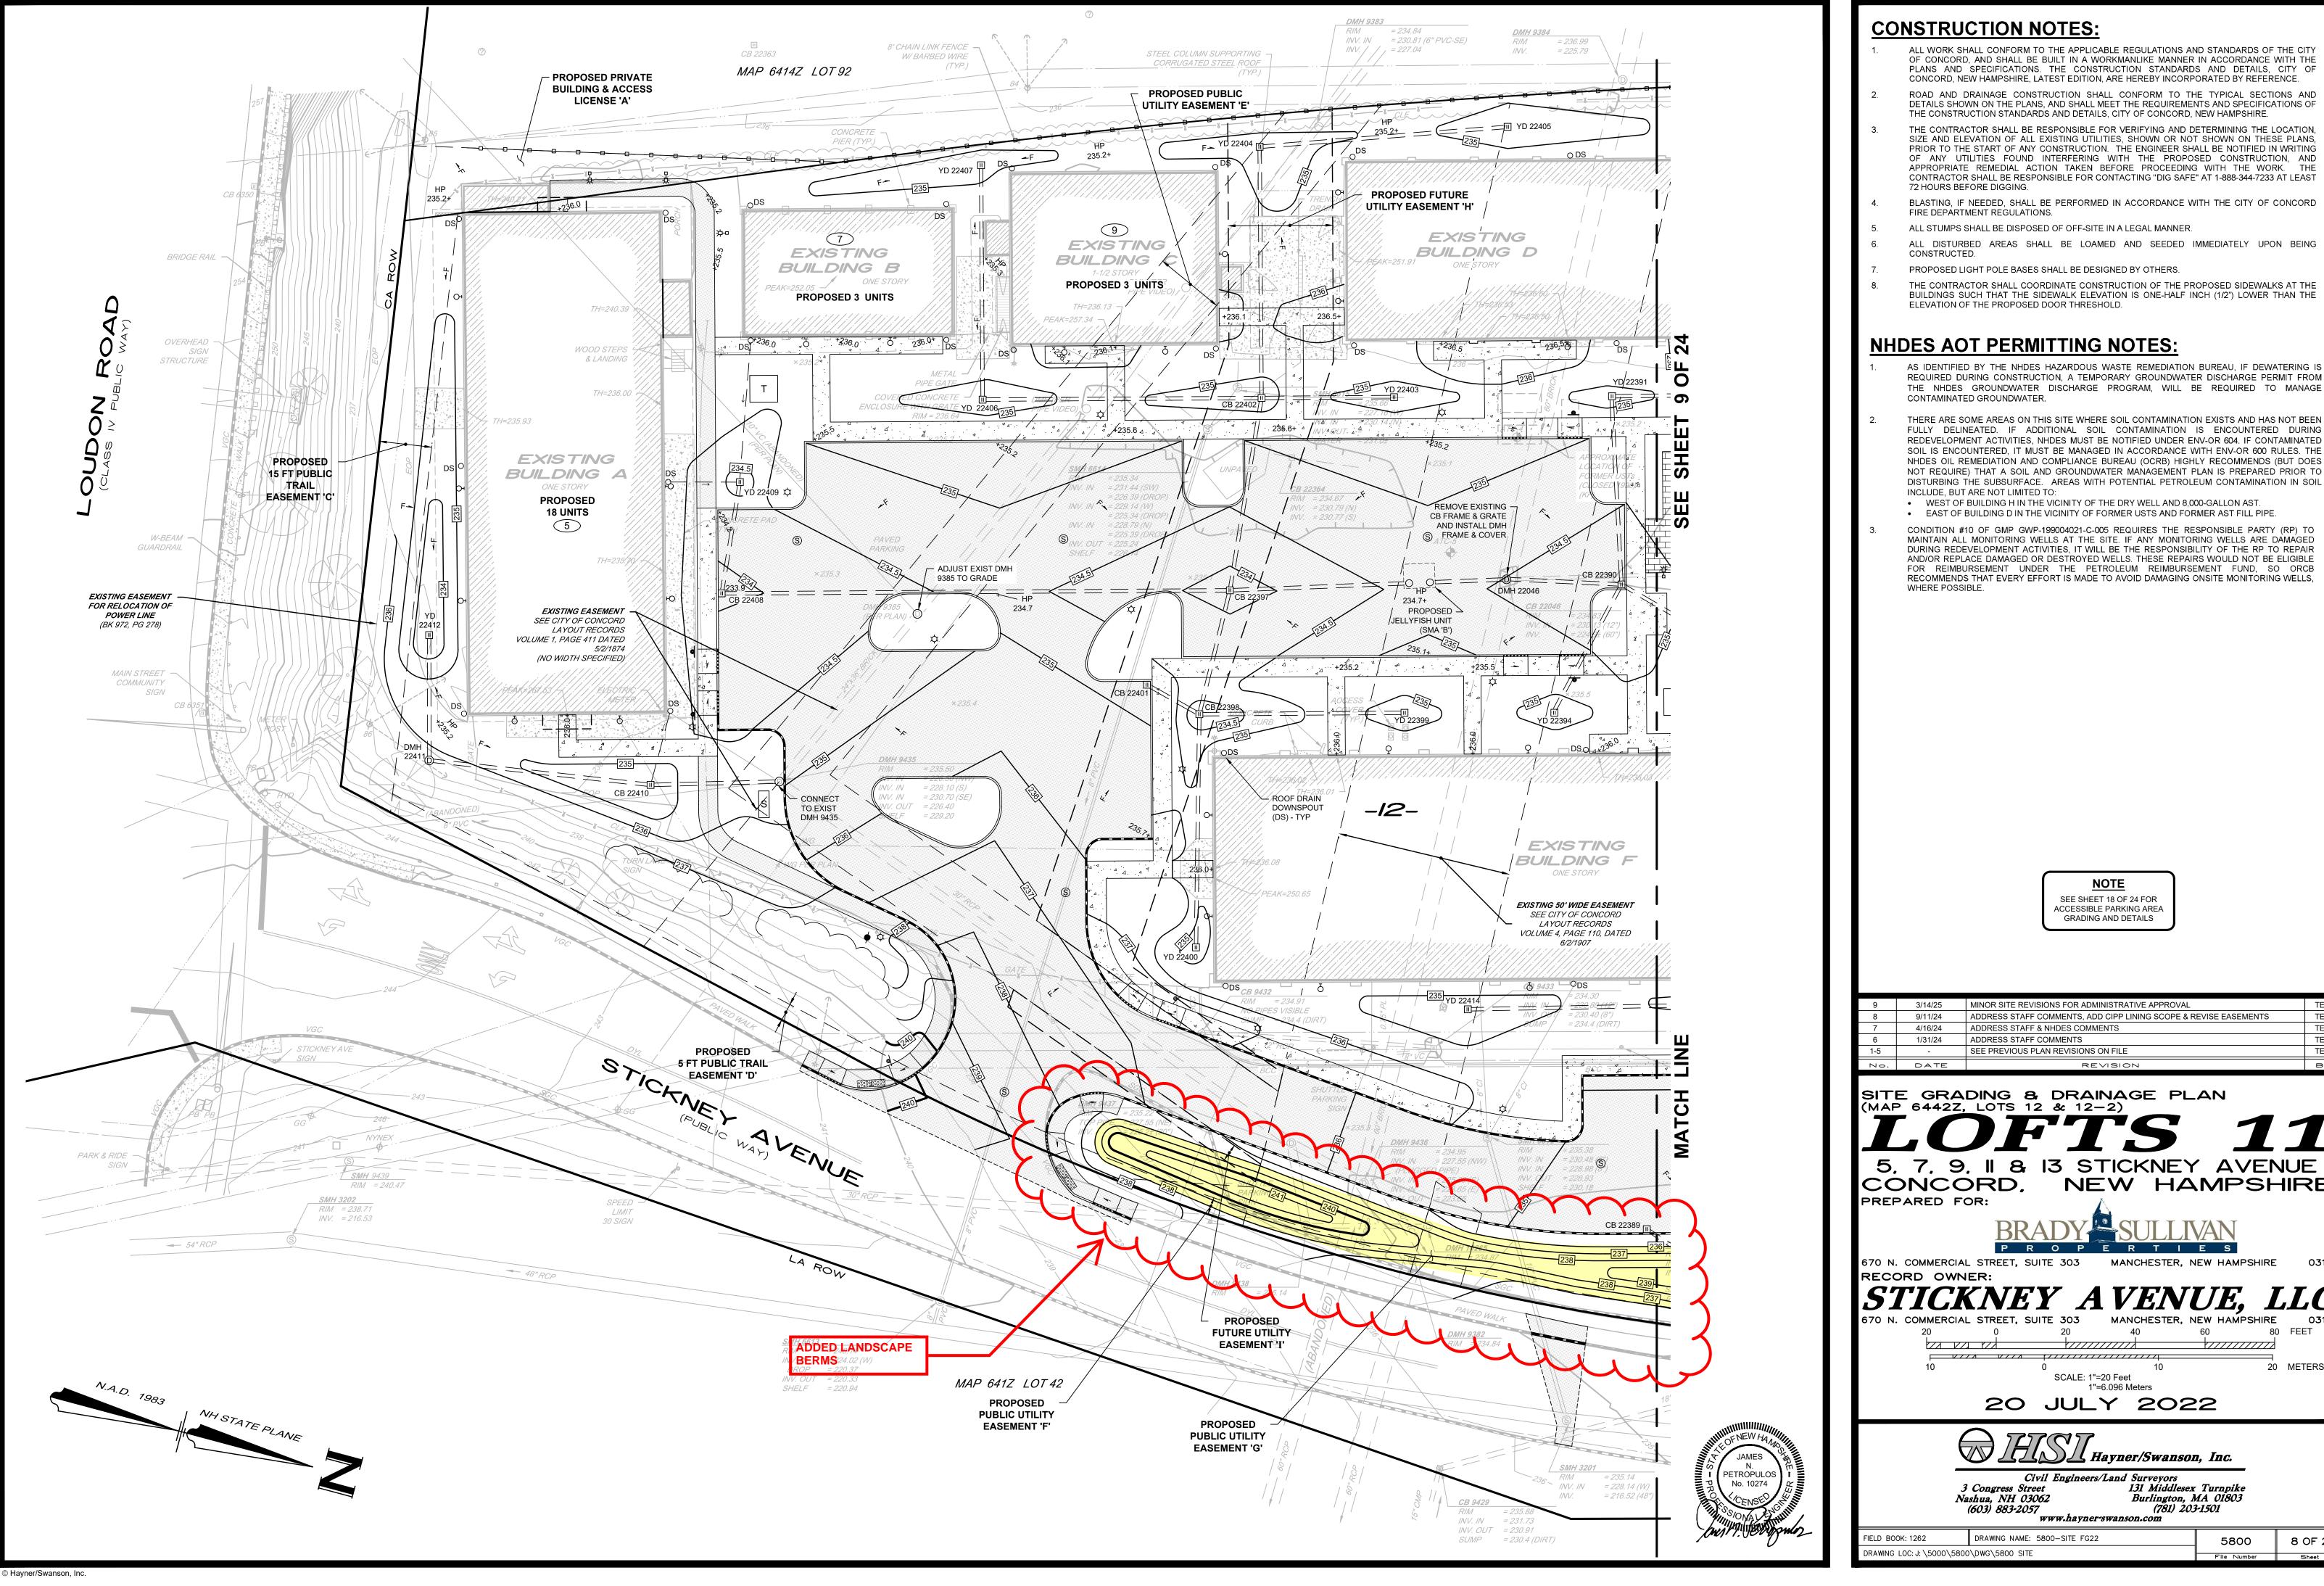

- ALL WORK SHALL CONFORM TO THE APPLICABLE REGULATIONS AND STANDARDS OF THE CITY OF CONCORD, AND SHALL BE BUILT IN A WORKMANLIKE MANNER IN ACCORDANCE WITH THE PLANS AND SPECIFICATIONS. THE CONSTRUCTION STANDARDS AND DETAILS, CITY OF
- ROAD AND DRAINAGE CONSTRUCTION SHALL CONFORM TO THE TYPICAL SECTIONS AND DETAILS SHOWN ON THE PLANS, AND SHALL MEET THE REQUIREMENTS AND SPECIFICATIONS OF THE CONSTRUCTION STANDARDS AND DETAILS, CITY OF CONCORD, NEW HAMPSHIRE.
- THE CONTRACTOR SHALL BE RESPONSIBLE FOR VERIFYING AND DETERMINING THE LOCATION, SIZE AND ELEVATION OF ALL EXISTING UTILITIES, SHOWN OR NOT SHOWN ON THESE PLANS, PRIOR TO THE START OF ANY CONSTRUCTION. THE ENGINEER SHALL BE NOTIFIED IN WRITING OF ANY UTILITIES FOUND INTERFERING WITH THE PROPOSED CONSTRUCTION, AND APPROPRIATE REMEDIAL ACTION TAKEN BEFORE PROCEEDING WITH THE WORK. THE CONTRACTOR SHALL BE RESPONSIBLE FOR CONTACTING "DIG SAFE" AT 1-888-344-7233 AT LEAST
- BLASTING, IF NEEDED, SHALL BE PERFORMED IN ACCORDANCE WITH THE CITY OF CONCORD
- ALL STUMPS SHALL BE DISPOSED OF OFF-SITE IN A LEGAL MANNER.
- ALL DISTURBED AREAS SHALL BE LOAMED AND SEEDED IMMEDIATELY UPON BEING
- PROPOSED LIGHT POLE BASES SHALL BE DESIGNED BY OTHERS.
- THE CONTRACTOR SHALL COORDINATE CONSTRUCTION OF THE PROPOSED SIDEWALKS AT THE BUILDINGS SUCH THAT THE SIDEWALK ELEVATION IS ONE-HALF INCH (1/2") LOWER THAN THE

NHDES AOT PERMITTING NOTES:

- AS IDENTIFIED BY THE NHDES HAZARDOUS WASTE REMEDIATION BUREAU, IF DEWATERING IS REQUIRED DURING CONSTRUCTION, A TEMPORARY GROUNDWATER DISCHARGE PERMIT FROM THE NHDES GROUNDWATER DISCHARGE PROGRAM, WILL BE REQUIRED TO MANAGE
- FULLY DELINEATED. IF ADDITIONAL SOIL CONTAMINATION IS ENCOUNTERED DURING REDEVELOPMENT ACTIVITIES, NHDES MUST BE NOTIFIED UNDER ENV-OR 604. IF CONTAMINATED SOIL IS ENCOUNTERED, IT MUST BE MANAGED IN ACCORDANCE WITH ENV-OR 600 RULES. THE NHDES OIL REMEDIATION AND COMPLIANCE BUREAU (OCRB) HIGHLY RECOMMENDS (BUT DOES NOT REQUIRE) THAT A SOIL AND GROUNDWATER MANAGEMENT PLAN IS PREPARED PRIOR TO DISTURBING THE SUBSURFACE. AREAS WITH POTENTIAL PETROLEUM CONTAMINATION IN SOIL
- EAST OF BUILDING D IN THE VICINITY OF FORMER USTS AND FORMER AST FILL PIPE.
- CONDITION #10 OF GMP GWP-199004021-C-005 REQUIRES THE RESPONSIBLE PARTY (RP) TO MAINTAIN ALL MONITORING WELLS AT THE SITE. IF ANY MONITORING WELLS ARE DAMAGED DURING REDEVELOPMENT ACTIVITIES, IT WILL BE THE RESPONSIBILITY OF THE RP TO REPAIR AND/OR REPLACE DAMAGED OR DESTROYED WELLS. THESE REPAIRS WOULD NOT BE ELIGIBLE FOR REIMBURSEMENT UNDER THE PETROLEUM REIMBURSEMENT FUND, SO ORCB RECOMMENDS THAT EVERY EFFORT IS MADE TO AVOID DAMAGING ONSITE MONITORING WELLS,

SEE SHEET 18 OF 24 FOR ACCESSIBLE PARKING AREA GRADING AND DETAILS

9	3/14/25	MINOR SITE REVISIONS FOR ADMINISTRATIVE APPROVAL	TEZ
8	9/11/24	ADDRESS STAFF COMMENTS, ADD CIPP LINING SCOPE & REVISE EASEMENTS	TEZ
7	4/16/24	ADDRESS STAFF & NHDES COMMENTS	TEZ
6	1/31/24	ADDRESS STAFF COMMENTS	TEZ
1-5	-	SEE PREVIOUS PLAN REVISIONS ON FILE	TEZ
0 ·	DATE	REVISION	BY

7, 9, II & I3 STICKNEY AVENUE NEW HAMPSHIRE



670 N. COMMERCIAL STREET, SUITE 303 MANCHESTER, NEW HAMPSHIRE

20 METERS SCALE: 1"=20 Feet

20 JULY 2022




Civil Engineers/Land Surveyors


131 Middlesex Turnpike

131 Middlesex Turnpike

131 Burlington, MA 01803

(781) 203-1501

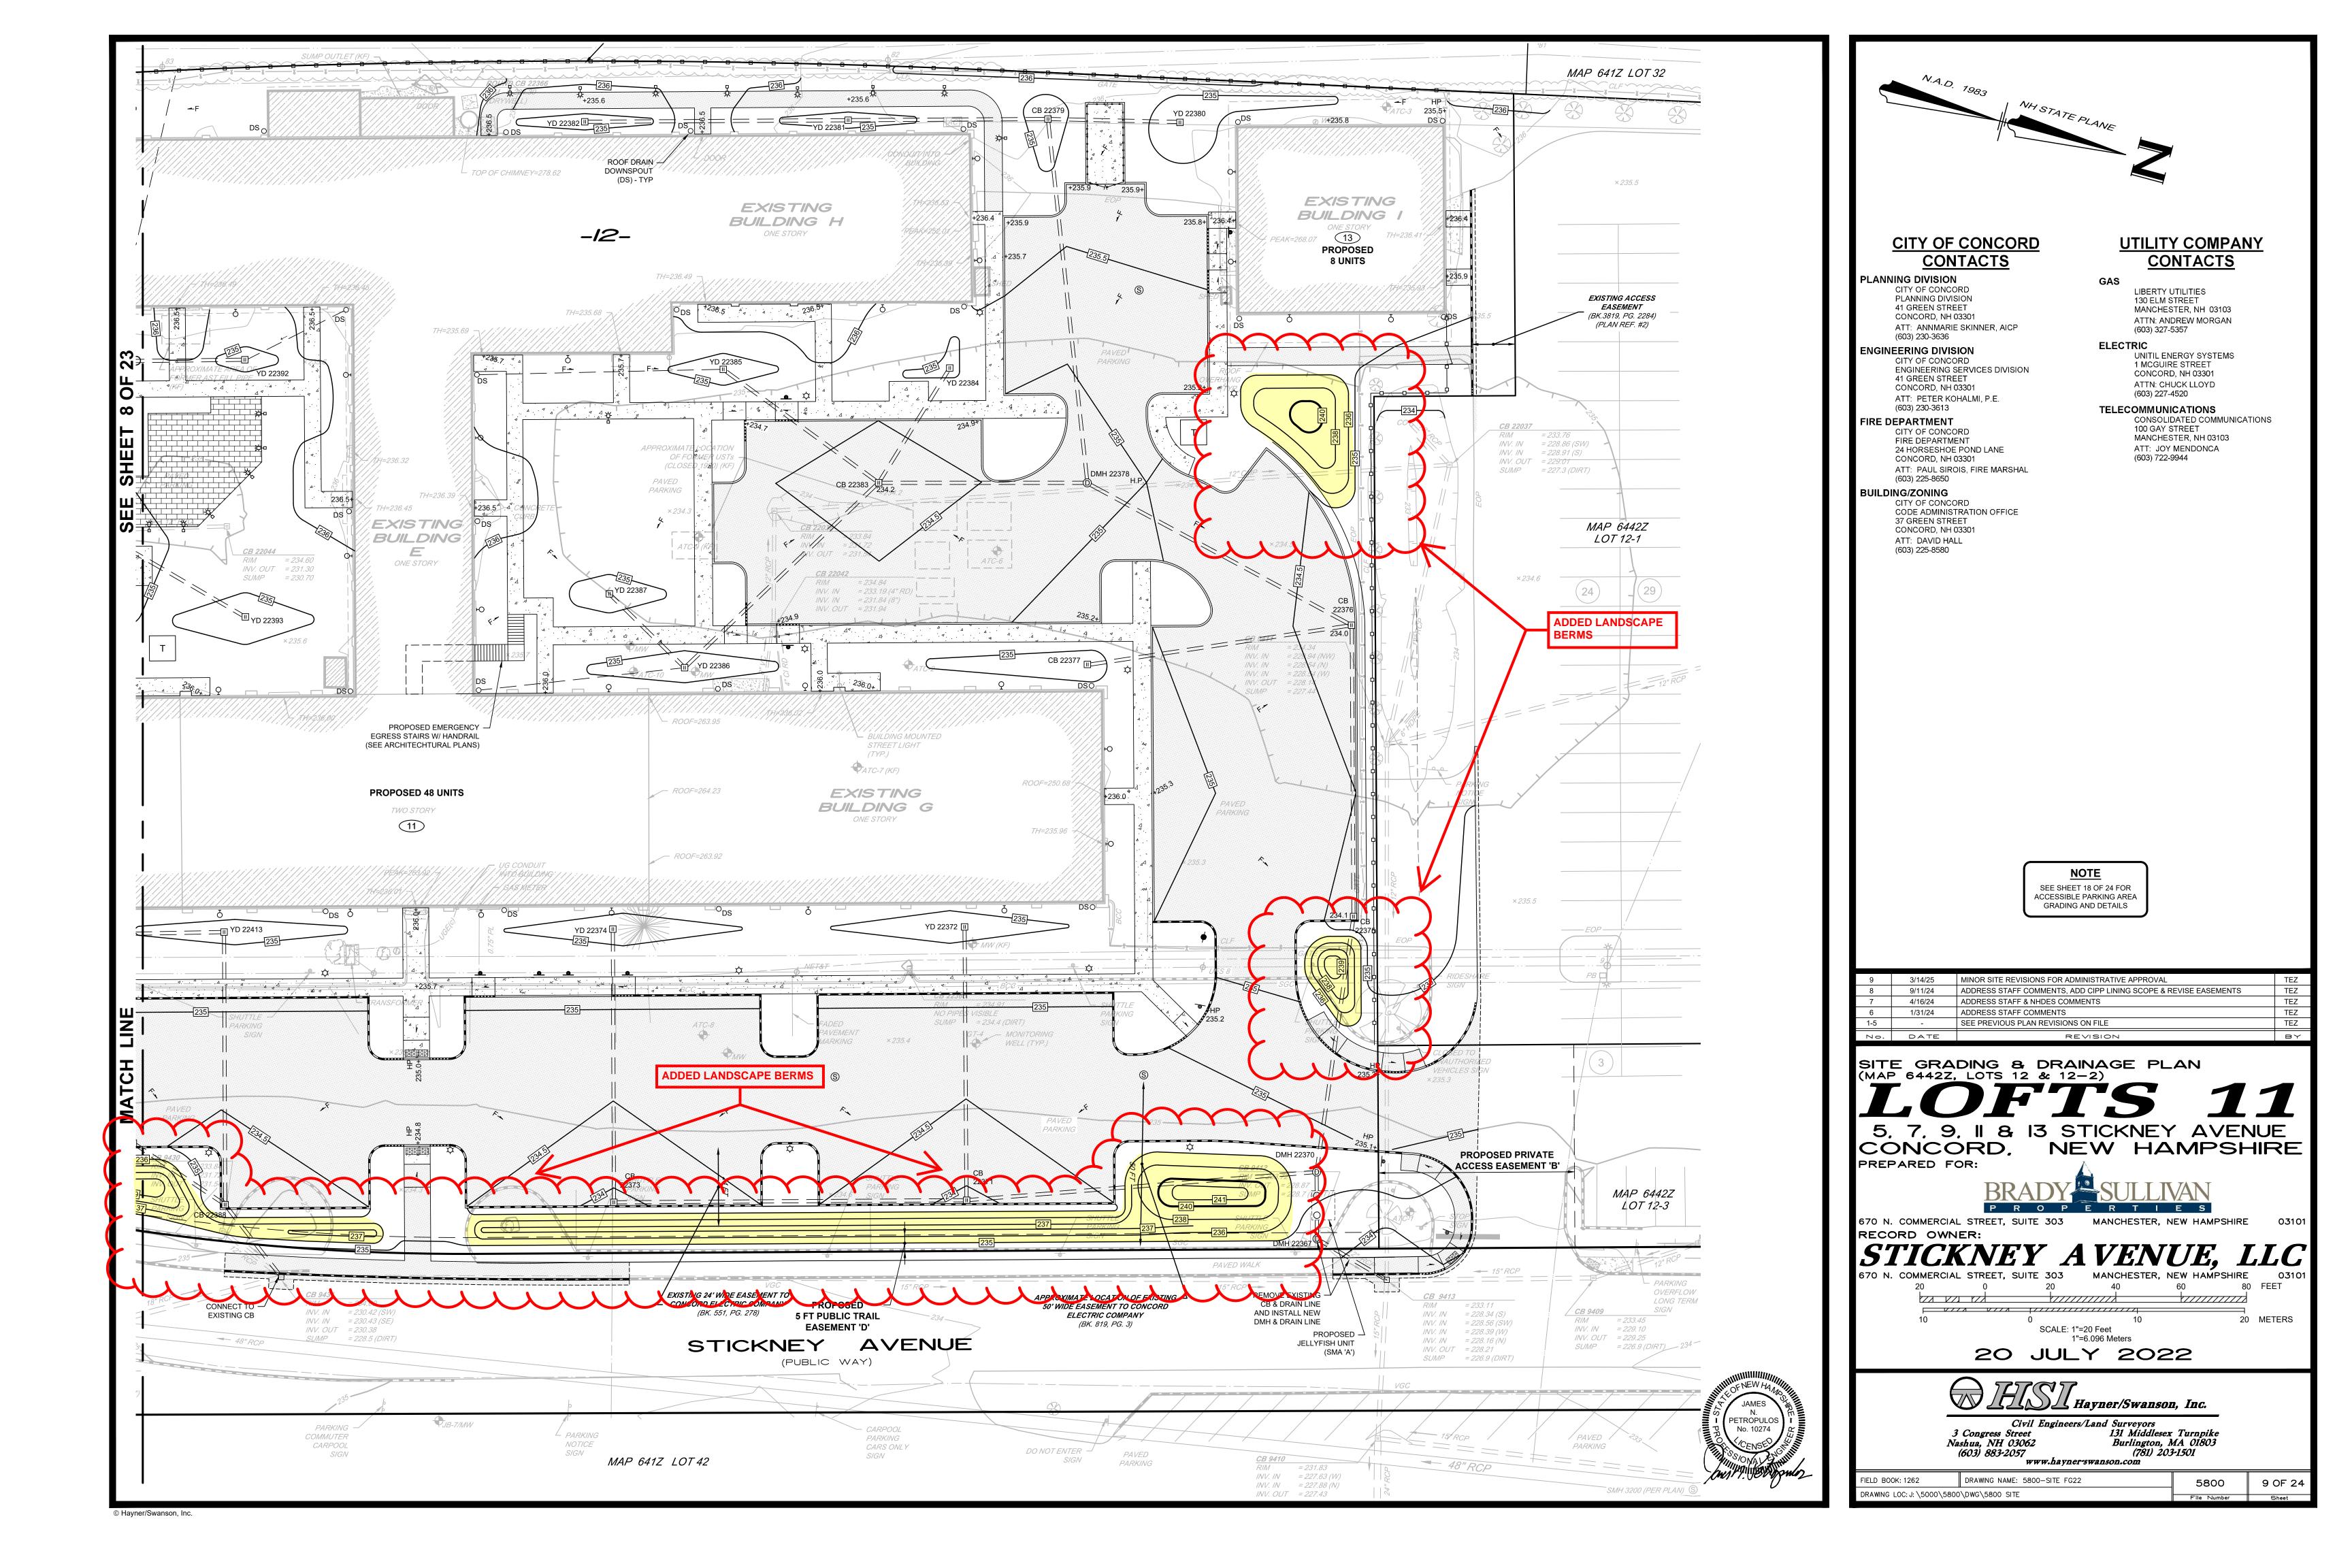

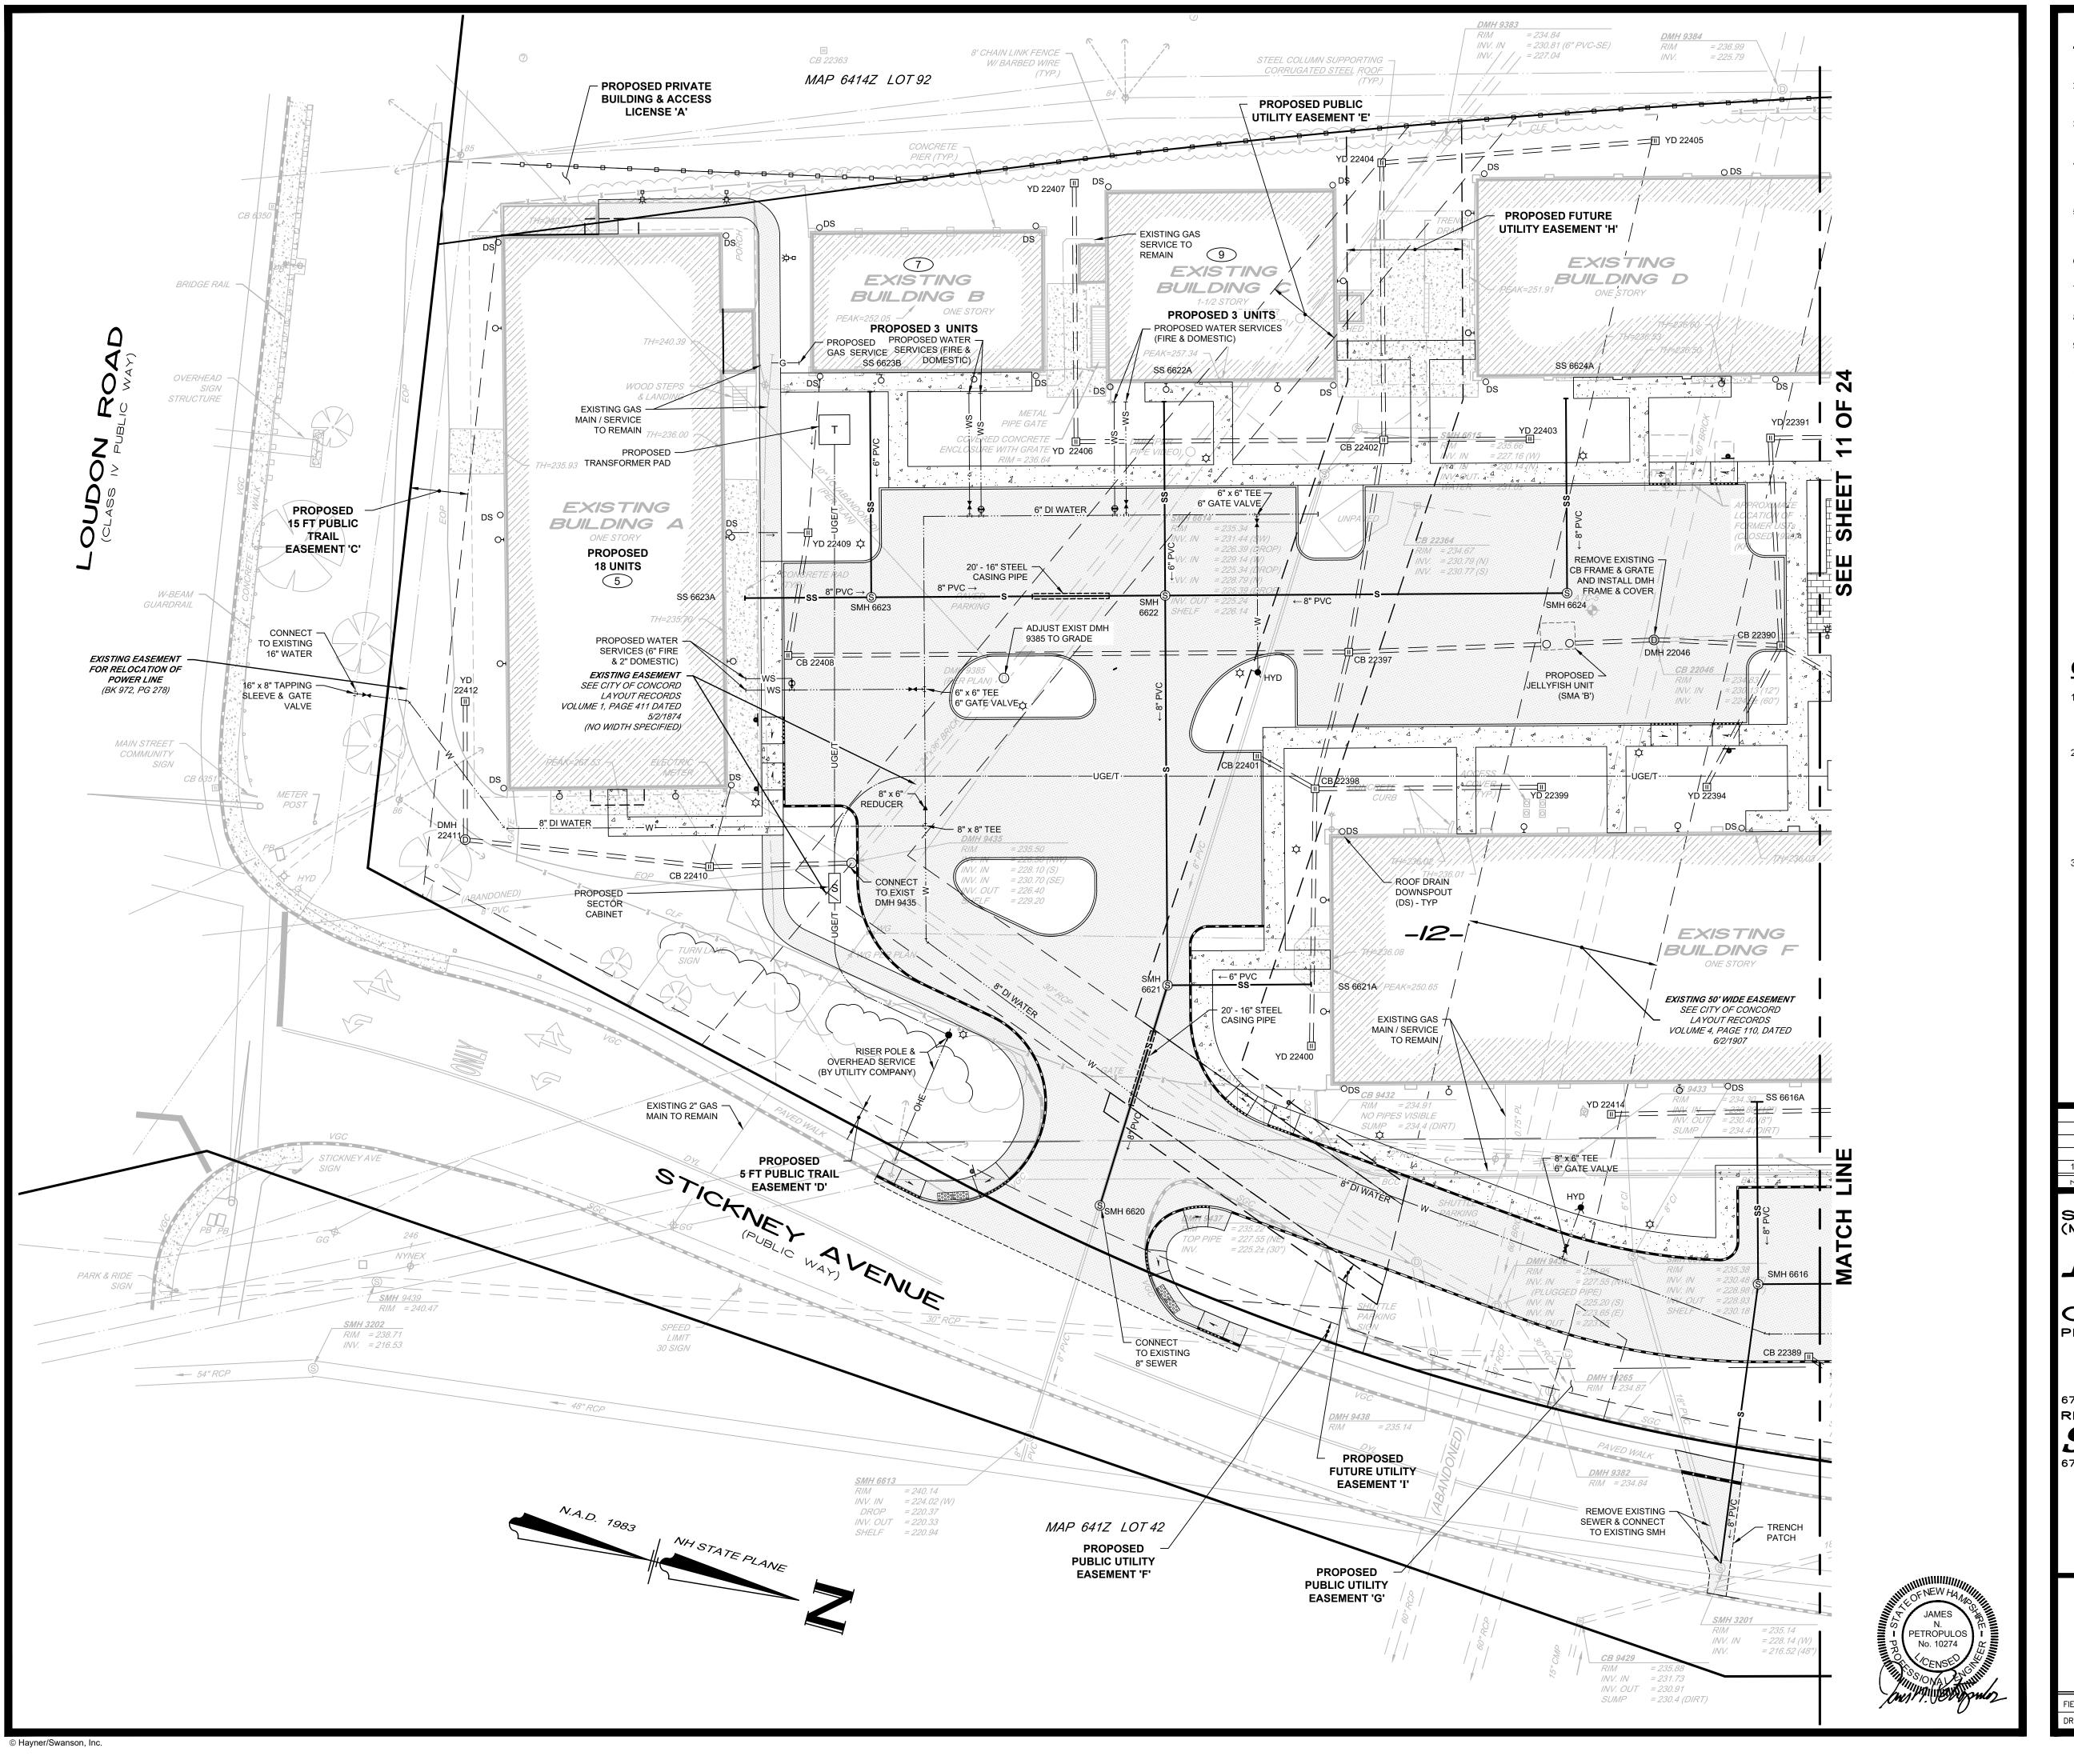

UTILITY NOTES:

- REFERENCE ARCHITECT'S PLANS FOR ALL BUILDING SERVICE CONNECTIONS
- CONSTRUCTION SHALL CONFORM TO THE TYPICAL SECTIONS AND DETAILS SHOWN ON THE PLANS, AND SHALL MEET THE REQUIREMENTS AND SPECIFICATIONS OF THE CITY OF CONCORD CONSTRUCTION STANDARDS AND DETAILS, LATEST EDITION.
- ALL DRAINAGE PIPES SHALL BE CLASS IV 3000 D (RCP) UNLESS OTHERWISE NOTED. ALL DRAINAGE PIPE GREATER THAN 36 INCH DIAMETER SHALL BE CLASS V-3750D (RCP). CATCH BASINS SHALL BE TYPE B, AND HAVE 3 FT SUMPS UNLESS OTHERWISE NOTED.
- ALL DRAINAGE PIPE SHALL BE FURNISHED AND INSTALLED WITH FLEXIBLE GASKETS. JOINTS SHALL BE MADE WITH OIL RESISTANT COMPRESSION RINGS OF AN ELASTOMERIC MATERIAL CONFORMING TO ASTM C-443. MANUFACTURER'S INSTALLATION INSTRUCTIONS SHALL BE
- ALL STORMWATER MANAGEMENT IMPROVEMENTS WILL BE MAINTAINED BY THE PROPERTY OWNER IN PERPETUITY IN ACCORDANCE WITH LOCAL, STATE, AND FEDERAL REGULATIONS; NHDES STORMWATER MANUAL RECOMMENDATIONS: STORMWATER MAINTENANCE AND OPERATIONS PLANS: AND ANY MANUFACTURER SPECIFICATIONS.
- ALL ELECTRIC RELATED WORK SHALL COMPLY WITH UNITIL ELECTRIC STANDARDS AND
- ALL PRIMARY AND SECONDARY SERVICE LOCATIONS ARE APPROXIMATE AND ARE SHOWN FOR COORDINATION PURPOSES ONLY.
- THE SECONDARY POWER RUN FROM TRANSFORMER PAD TO THE BUILDING SHALL BE
- PERFORMED BY THE PROJECT'S ELECTRICAL CONTRACTOR. ALL TELECOMMUNICATIONS RELATED WORK SHALL COMPLY WITH FAIRPOINT COMMUNICATIONS
- STANDARDS AND SPECIFICATIONS. ALL TELECOMMUNICATIONS LINE LOCATIONS ARE APPROXIMATE AND SHOWN FOR
- COORDINATION PURPOSES ONLY.
- PRIOR TO CONSTRUCTION, THE CONTRACTOR SHALL COORDINATE THE EXACT SIZE AND LOCATION OF THE NATURAL GAS MAIN AND SERVICES WITH LIBERTY UTILITIES.
- PRIOR TO CONSTRUCTION, THE CONTRACTOR SHALL COORDINATE FINAL WATER SERVICE (DOMESTIC & FIRE PROTECTION) WITH THE PROJECT'S MEP/FP ENGINEER.
- THE CONTRACTOR SHALL REFER TO THE PROJECT'S GEOTECNICAL ENGINEERING REPORT PREPARED BY NOBIS GROUP AS IT RELATES TO UTILITY INSTALLATION, DETWATERING AND GROUNDWATER CONTROL.
- BASED UPON RECENT VIDEO INSPECTIONS, IT APPEARS THAT THERE MAY BE SEVERAL ON-SITE BLIND CONNECTIONS THAT TIE INTO THE EXISTING 60" DRAIN LINE, INCLUDING WITHIN THE FOOTPRINT OF EXISTING BUILDINGS 'D' AND 'F'. THE CONTRACTOR SHALL REMOVE ALL EXISTING CONNECTIONS INTO THE ABOVE-REFERENCED DRAIN LINE DURING BUILDING/SITE DEMOLITION AND CONSTRUCTION, WITH THE EXCEPTION OF THE PROPOSED SITE DRAINAGE CONNECTIONS AT EXISTING CATCH BASIN 22046 AS SHOWN ON THE PLANS.
- THERE ARE MULTIPLE LOCATIONS WHERE THERE IS LESS THAN 36" OF SEPARATION BETWEEN DRAINAGE AND WATER PIPES, 2" RIGID POLYSTYRENE THERMAL INSULATION WITH A MINIMUM "R" VALUE OF 10 SHALL BE INSTALLED WITH A MINIMUM WIDTH OF 2-FT ON EACH SIDE OF THE UTILITY AND A MINIMUM LENGTH OF 8-FT ON EACH SIDE OF THE UTILITY CROSSING.

CURED-IN-PLACE PIPE (CIPP) LINING NOTE:

THE CONTRACTOR SHALL PERFORM CURED-IN-PLACE PIPE (CIPP) LINING OF THE FOLLOWING EXISTING PUBLIC DRAIN LINES IN ACCORDANCE WITH NASSCO PACP GUIDELINES: APPROXIMATLEY 328-FT 60" BRICK DRAIN FROM DMH 9384 TO DMH 9436

APPROXIMATLEY 180-FT 24"X36" BRICK DRAIN FROM DMH 9383 TO DMH 9385

- THE EXISTING BRICK SEWER/DRAIN LINES AS REFERENCED ABOVE AND SHOWN ON THE SITE PLANS SHALL BE REHABILITATED BY THE INSTALLATION OF A CURED-IN-PLACE PIPE (CIPP) IN ACCORDANCE WITH ASTM F 1743: REHABILITATION OF EXISTING PIPELINES AND CONDUITS BY PULLED-IN-PLACE INSTALLATION OF CURED-IN-PLACE THERMOSETTING RESIN PIPE (CIPP); AND THE LINER DESIGN SHALL CONFORM TO ASTM F 1216: STANDARD PRACTICE FOR REHABILITATION OF EXISTING PIPELINES AND CONDUITS BY THE INVERSION AND CURING OF A RESIN-IMPREGNATED TUBE. PRIOR TO CONSTRUCTION, THE CONTRACTOR SHALL PROVIDE A LINER DESIGN SUBMITTAL TO THE ENGINEER, STAMPED BY A PROFESSIONAL ENGINEER REGISTERED IN THE STATE OF NEW HAMPSHIRE, FOR REVIEW AND ACCEPTANCE.
- THE WORK SHALL INCLUDE BY-PASS PUMPING, CLEANING AND ROOT CUTTING INCLUDING DECANTING AND DISPOSAL OF SURPLUS DEBRIS, INITIAL CLOSED-CIRCUIT TELEVISION (CCTV) INSPECTION, INSTALLATION OF RESIN-IMPREGNATED TUBE INTO THE EXISTING PIPE FOLLOWED BY HOT WATER OR STEAM CURING AS SPECIFIED BY THE RESIN MANUFACTURER, AND FINAL CLOSED-CIRCUIT TELEVISION (CCTV) INSPECTION ACCEPTABLE TO THE ENGINEER, AND ALL OTHER RELATED WORK. ALL SUCH WORK SHALL COMPLY WITH THE REFERENCED TECHNICAL SPECIFICATIONS AND THE SPECIFIC PRODUCT MANUFACTURER'S RECOMMENDATIONS. ANY CONFLICT BETWEEN THE PRODUCT MANUFACTURER'S RECOMMENDATIONS AND ANY PORTION OF THE TECHNICAL SPECIFICATIONS SHALL BE RESOLVED WITH THE ENGINEER PRIOR TO PROCEEDING WITH THE WORK.

9	3/14/25	MINOR SITE REVISIONS FOR ADMINISTRATIVE APPROVAL	TEZ
8	9/11/24	ADDRESS STAFF COMMENTS, ADD CIPP LINING SCOPE & REVISE EASEMENTS	TEZ
7	4/16/24	ADDRESS STAFF & NHDES COMMENTS	TEZ
6	1/31/24	ADDRESS STAFF COMMENTS	TEZ
1-5	-	SEE PREVIOUS PLAN REVISIONS ON FILE	TEZ
0. Z	DATE	REVISION	BY

SITE UTILITY PLAN (MAP 6442Z, LOTS 12 & 12-2)

7, 9, II & I3 STICKNEY AVENUE CONCORD, NEW HAMPSHIRE

PREPARED FOR:

670 N. COMMERCIAL STREET, SUITE 303 MANCHESTER, NEW HAMPSHIRE RECORD OWNER:

20 METERS


SCALE: 1"=20 Feet 20 JULY 2022


Hayner/Swanson, Inc.


131 Middlesex Turnpike Burlington, MA 01803 3 Congress Street Nashua, NH 03062 (781) 203-1501 (603) 883-2057 www.hayner-swanson.com


DRAWING NAME: 5800-SITE FU22 TELD BOOK: 1262 PRAWING LOC: J: \5000\5800\DWG\5800 SITE


10 OF 24 5800

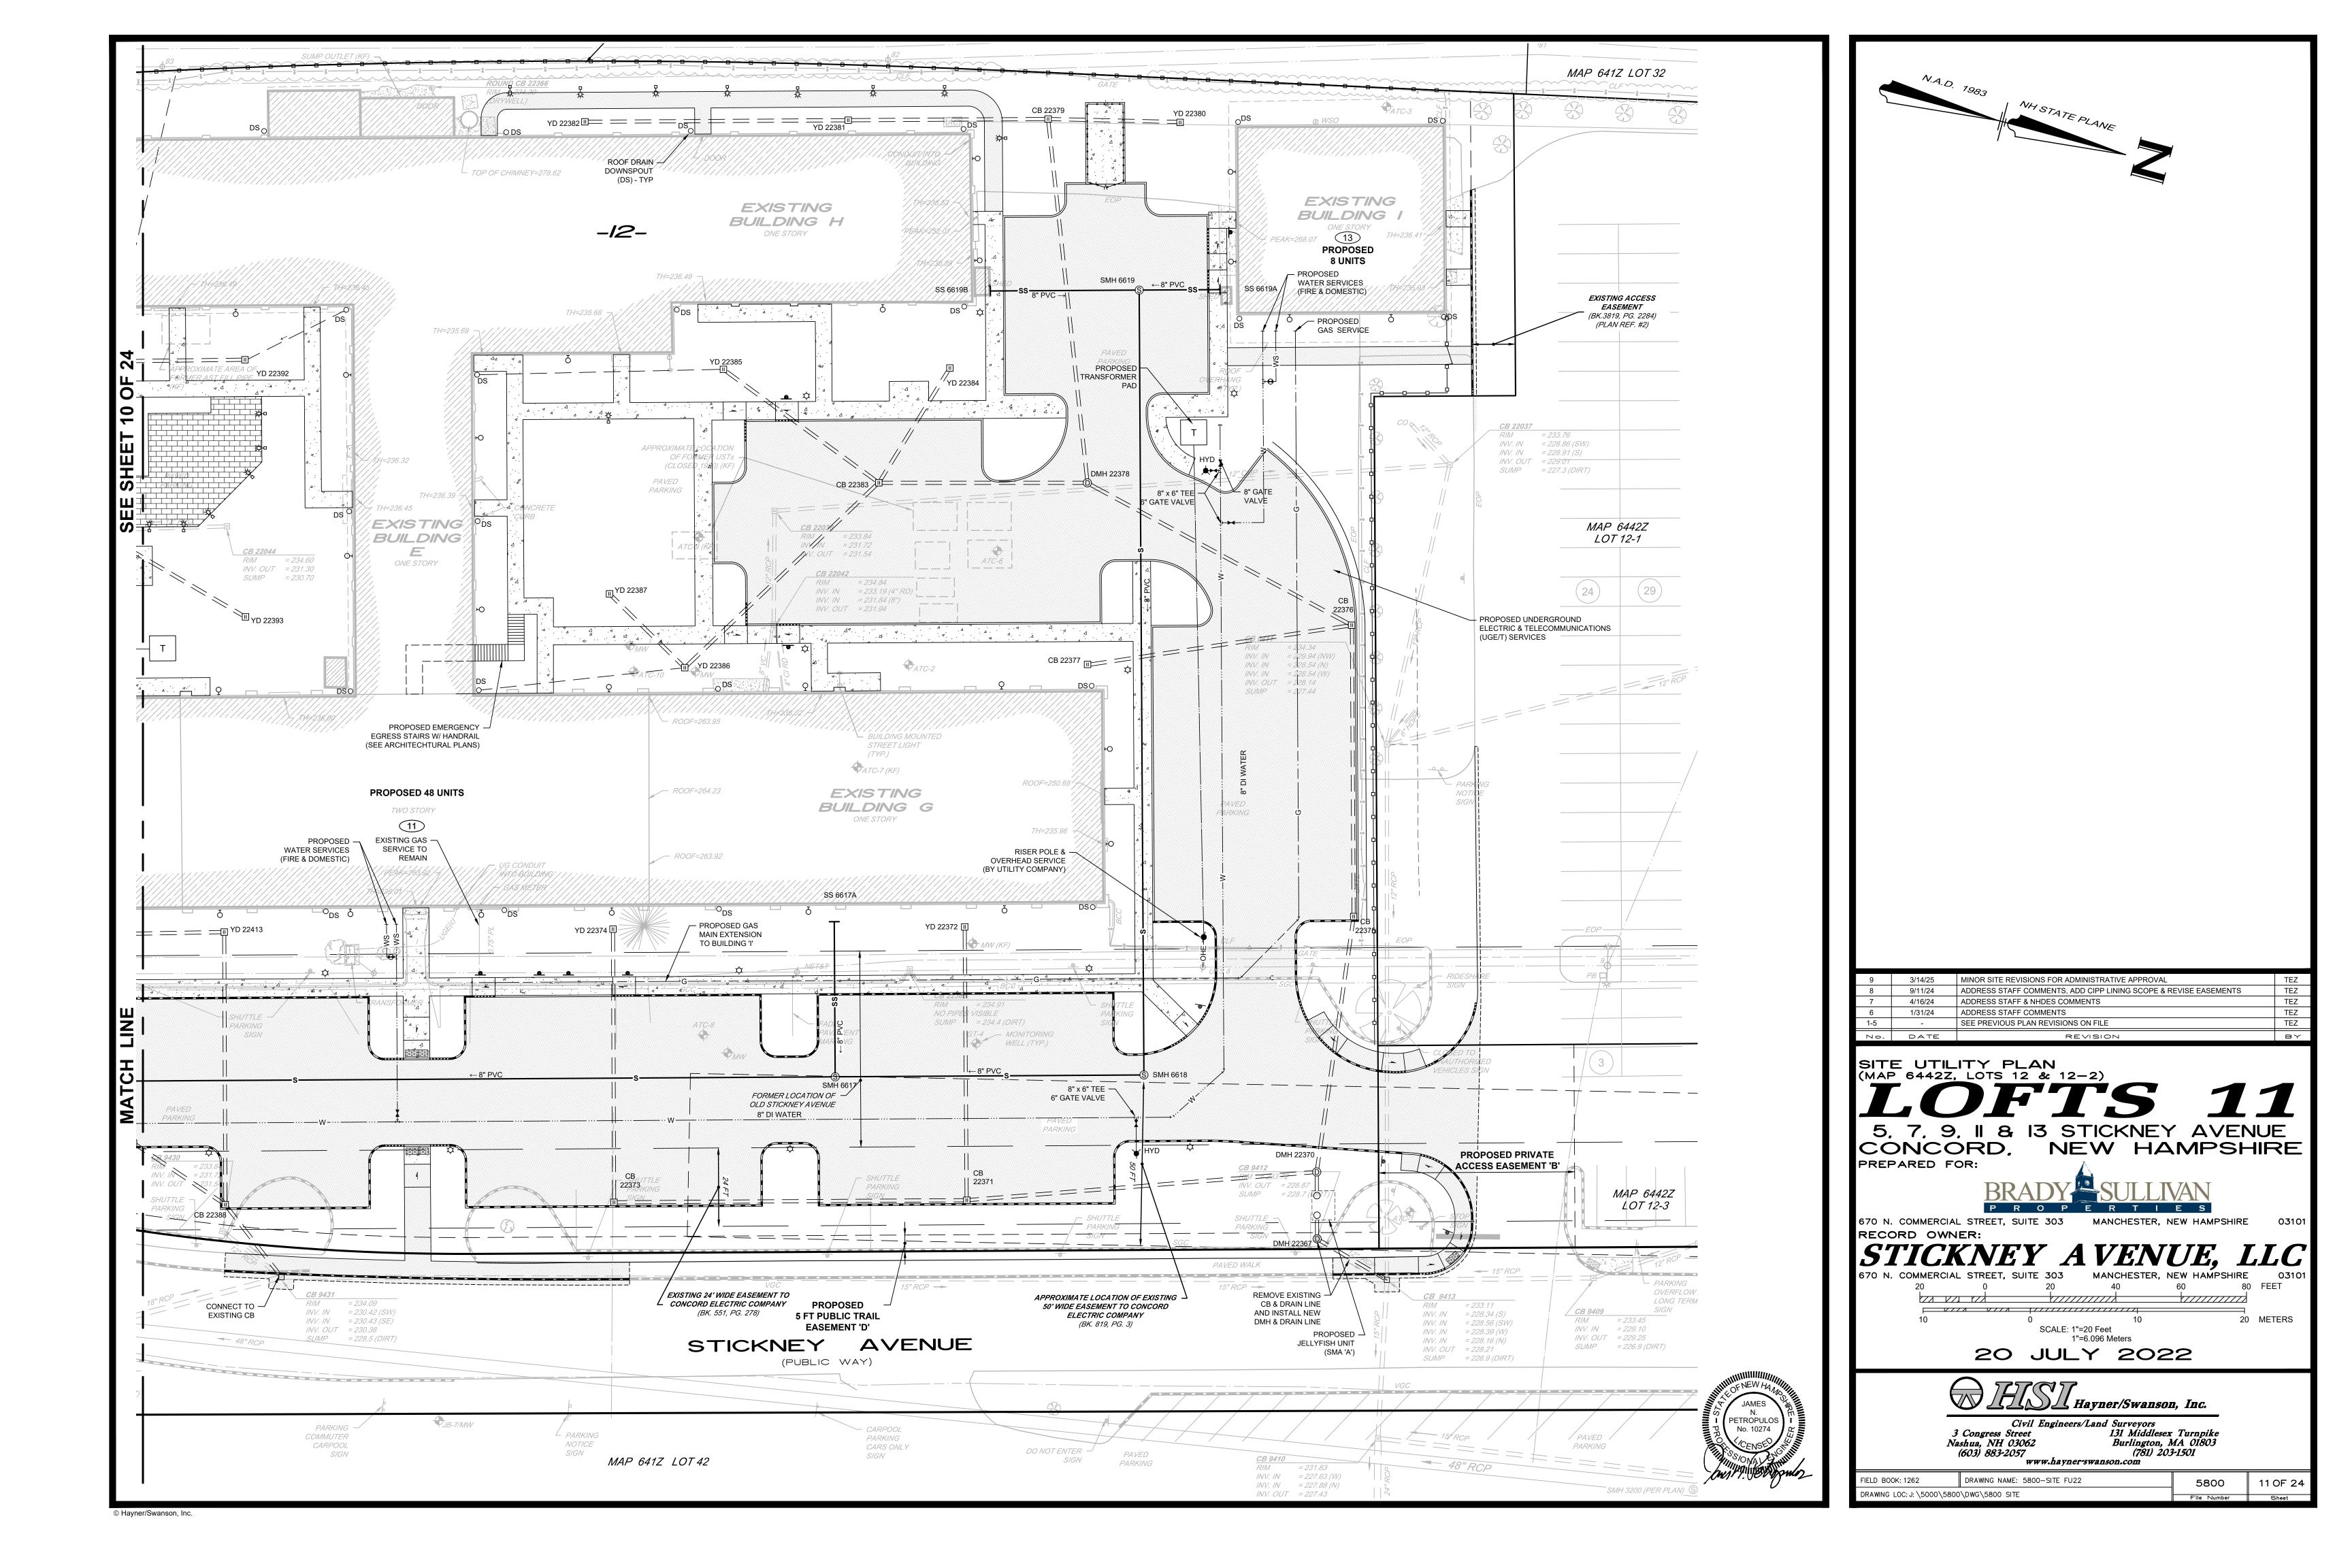

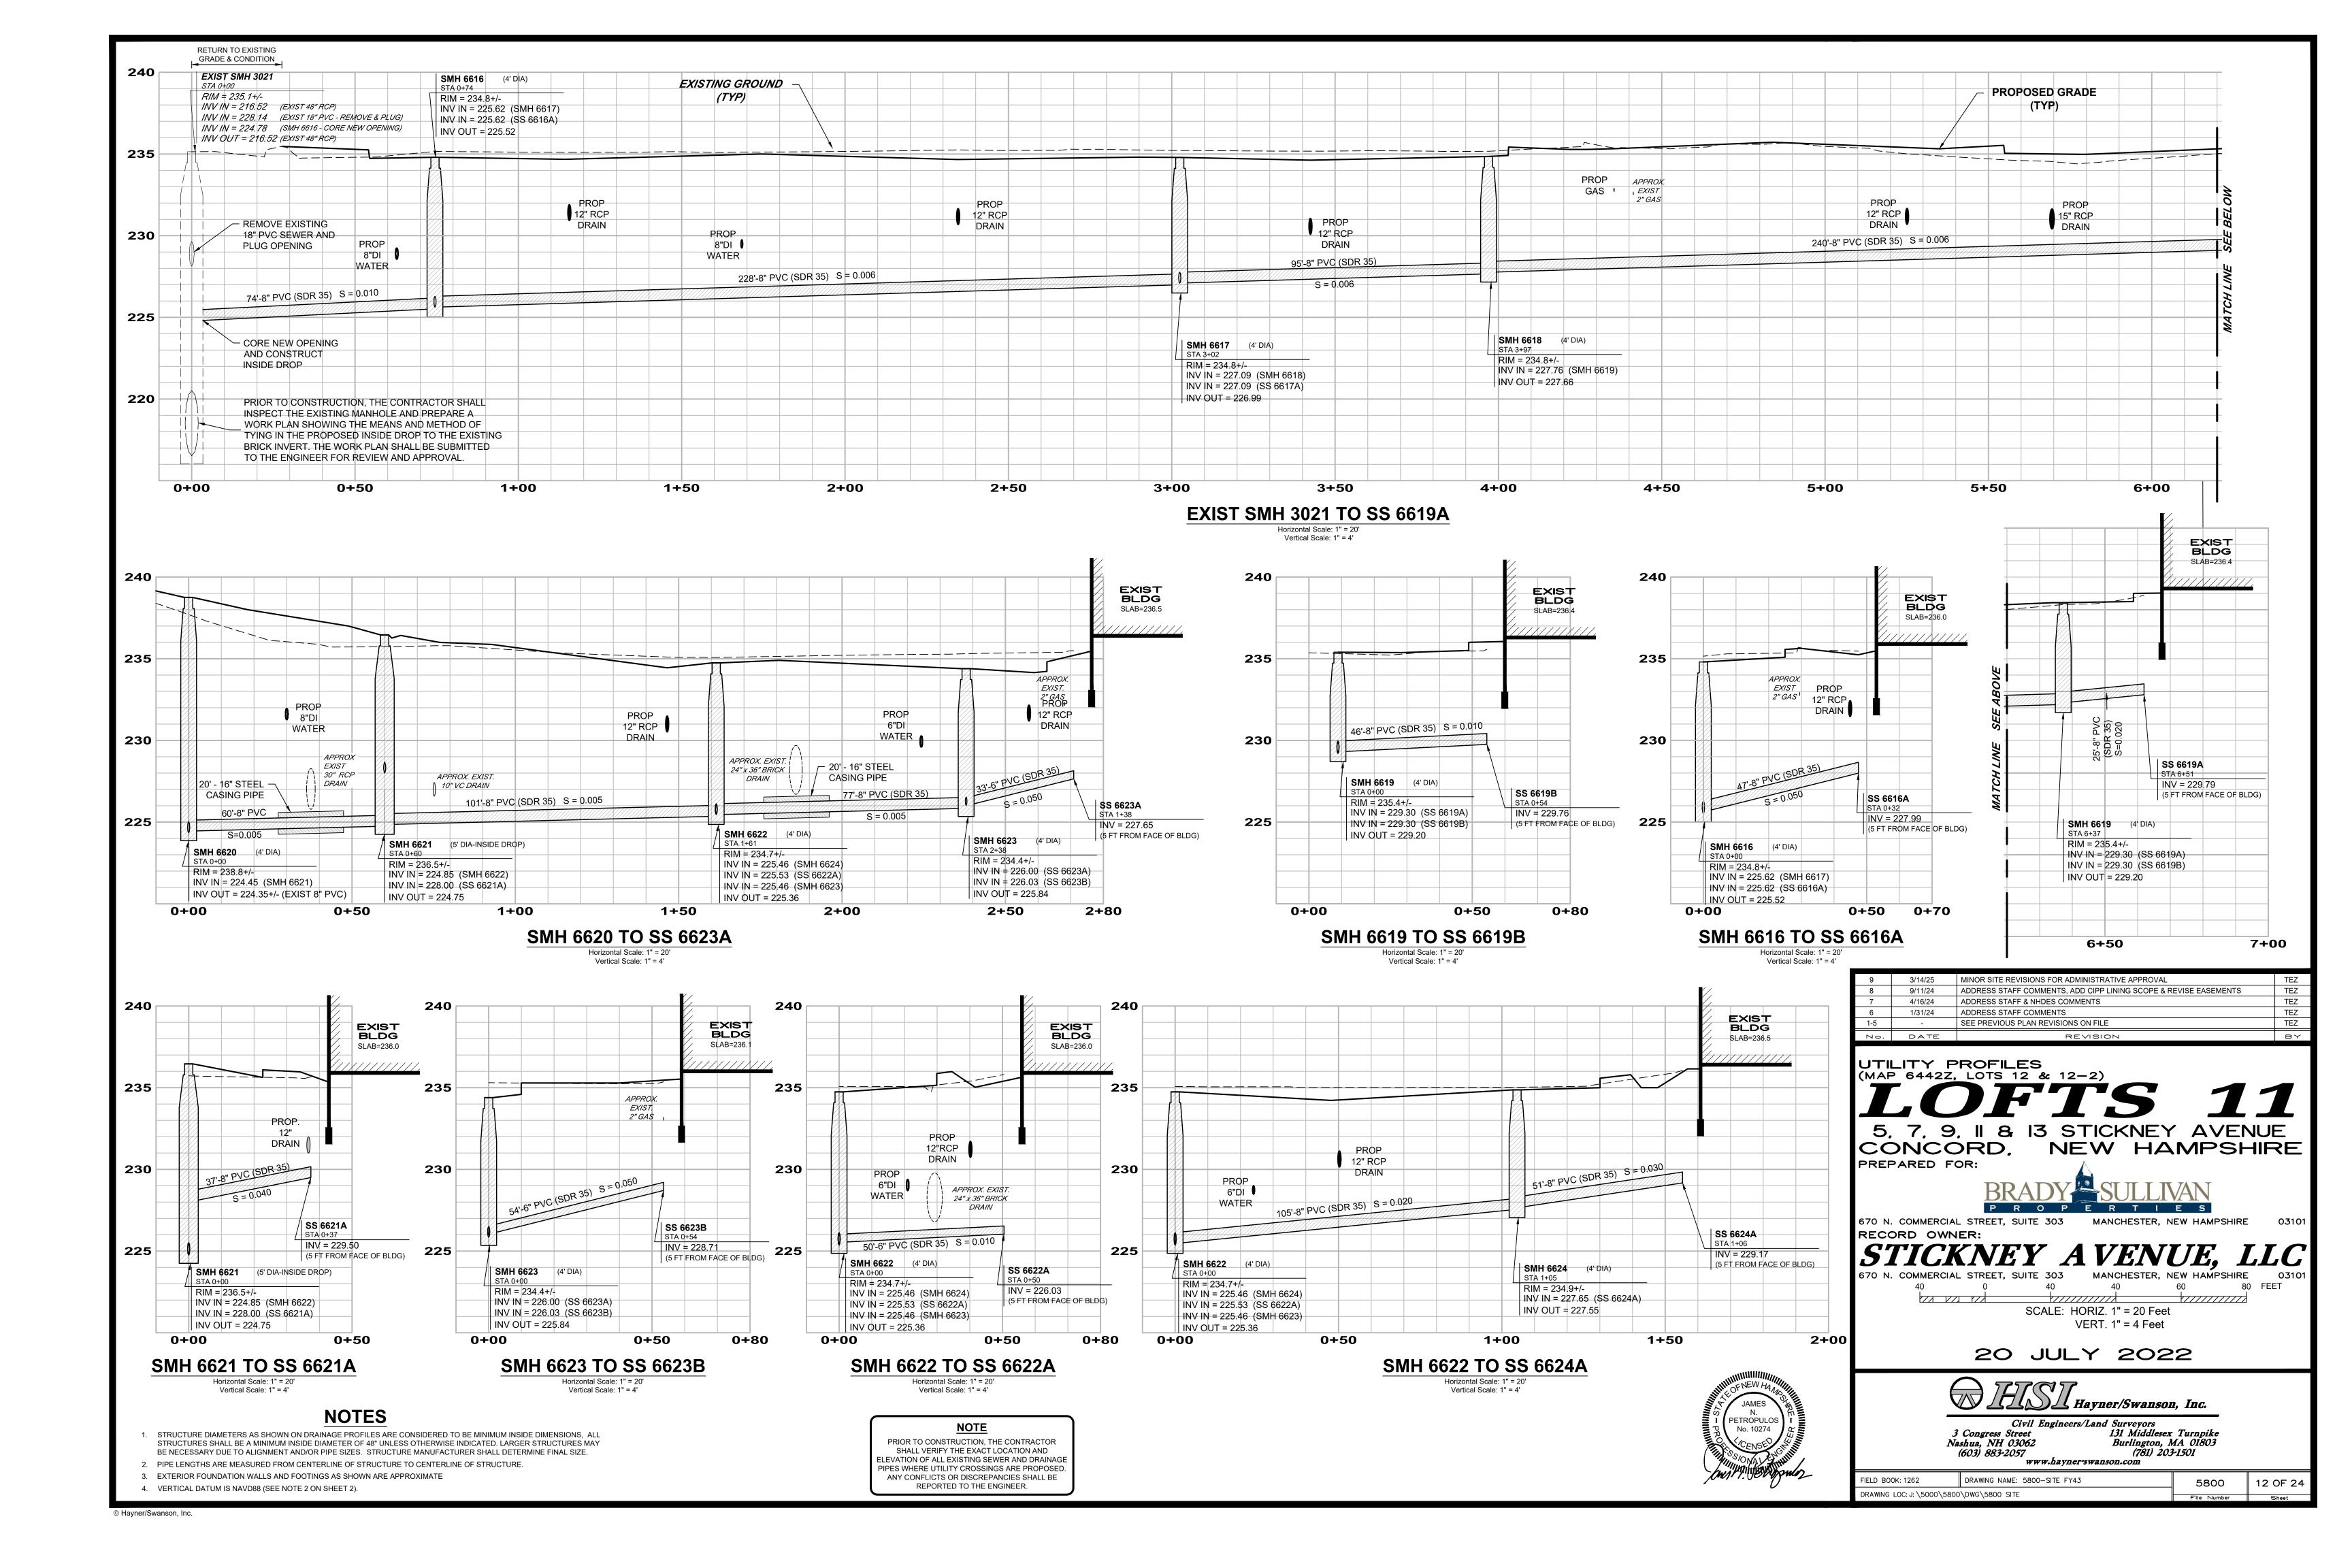

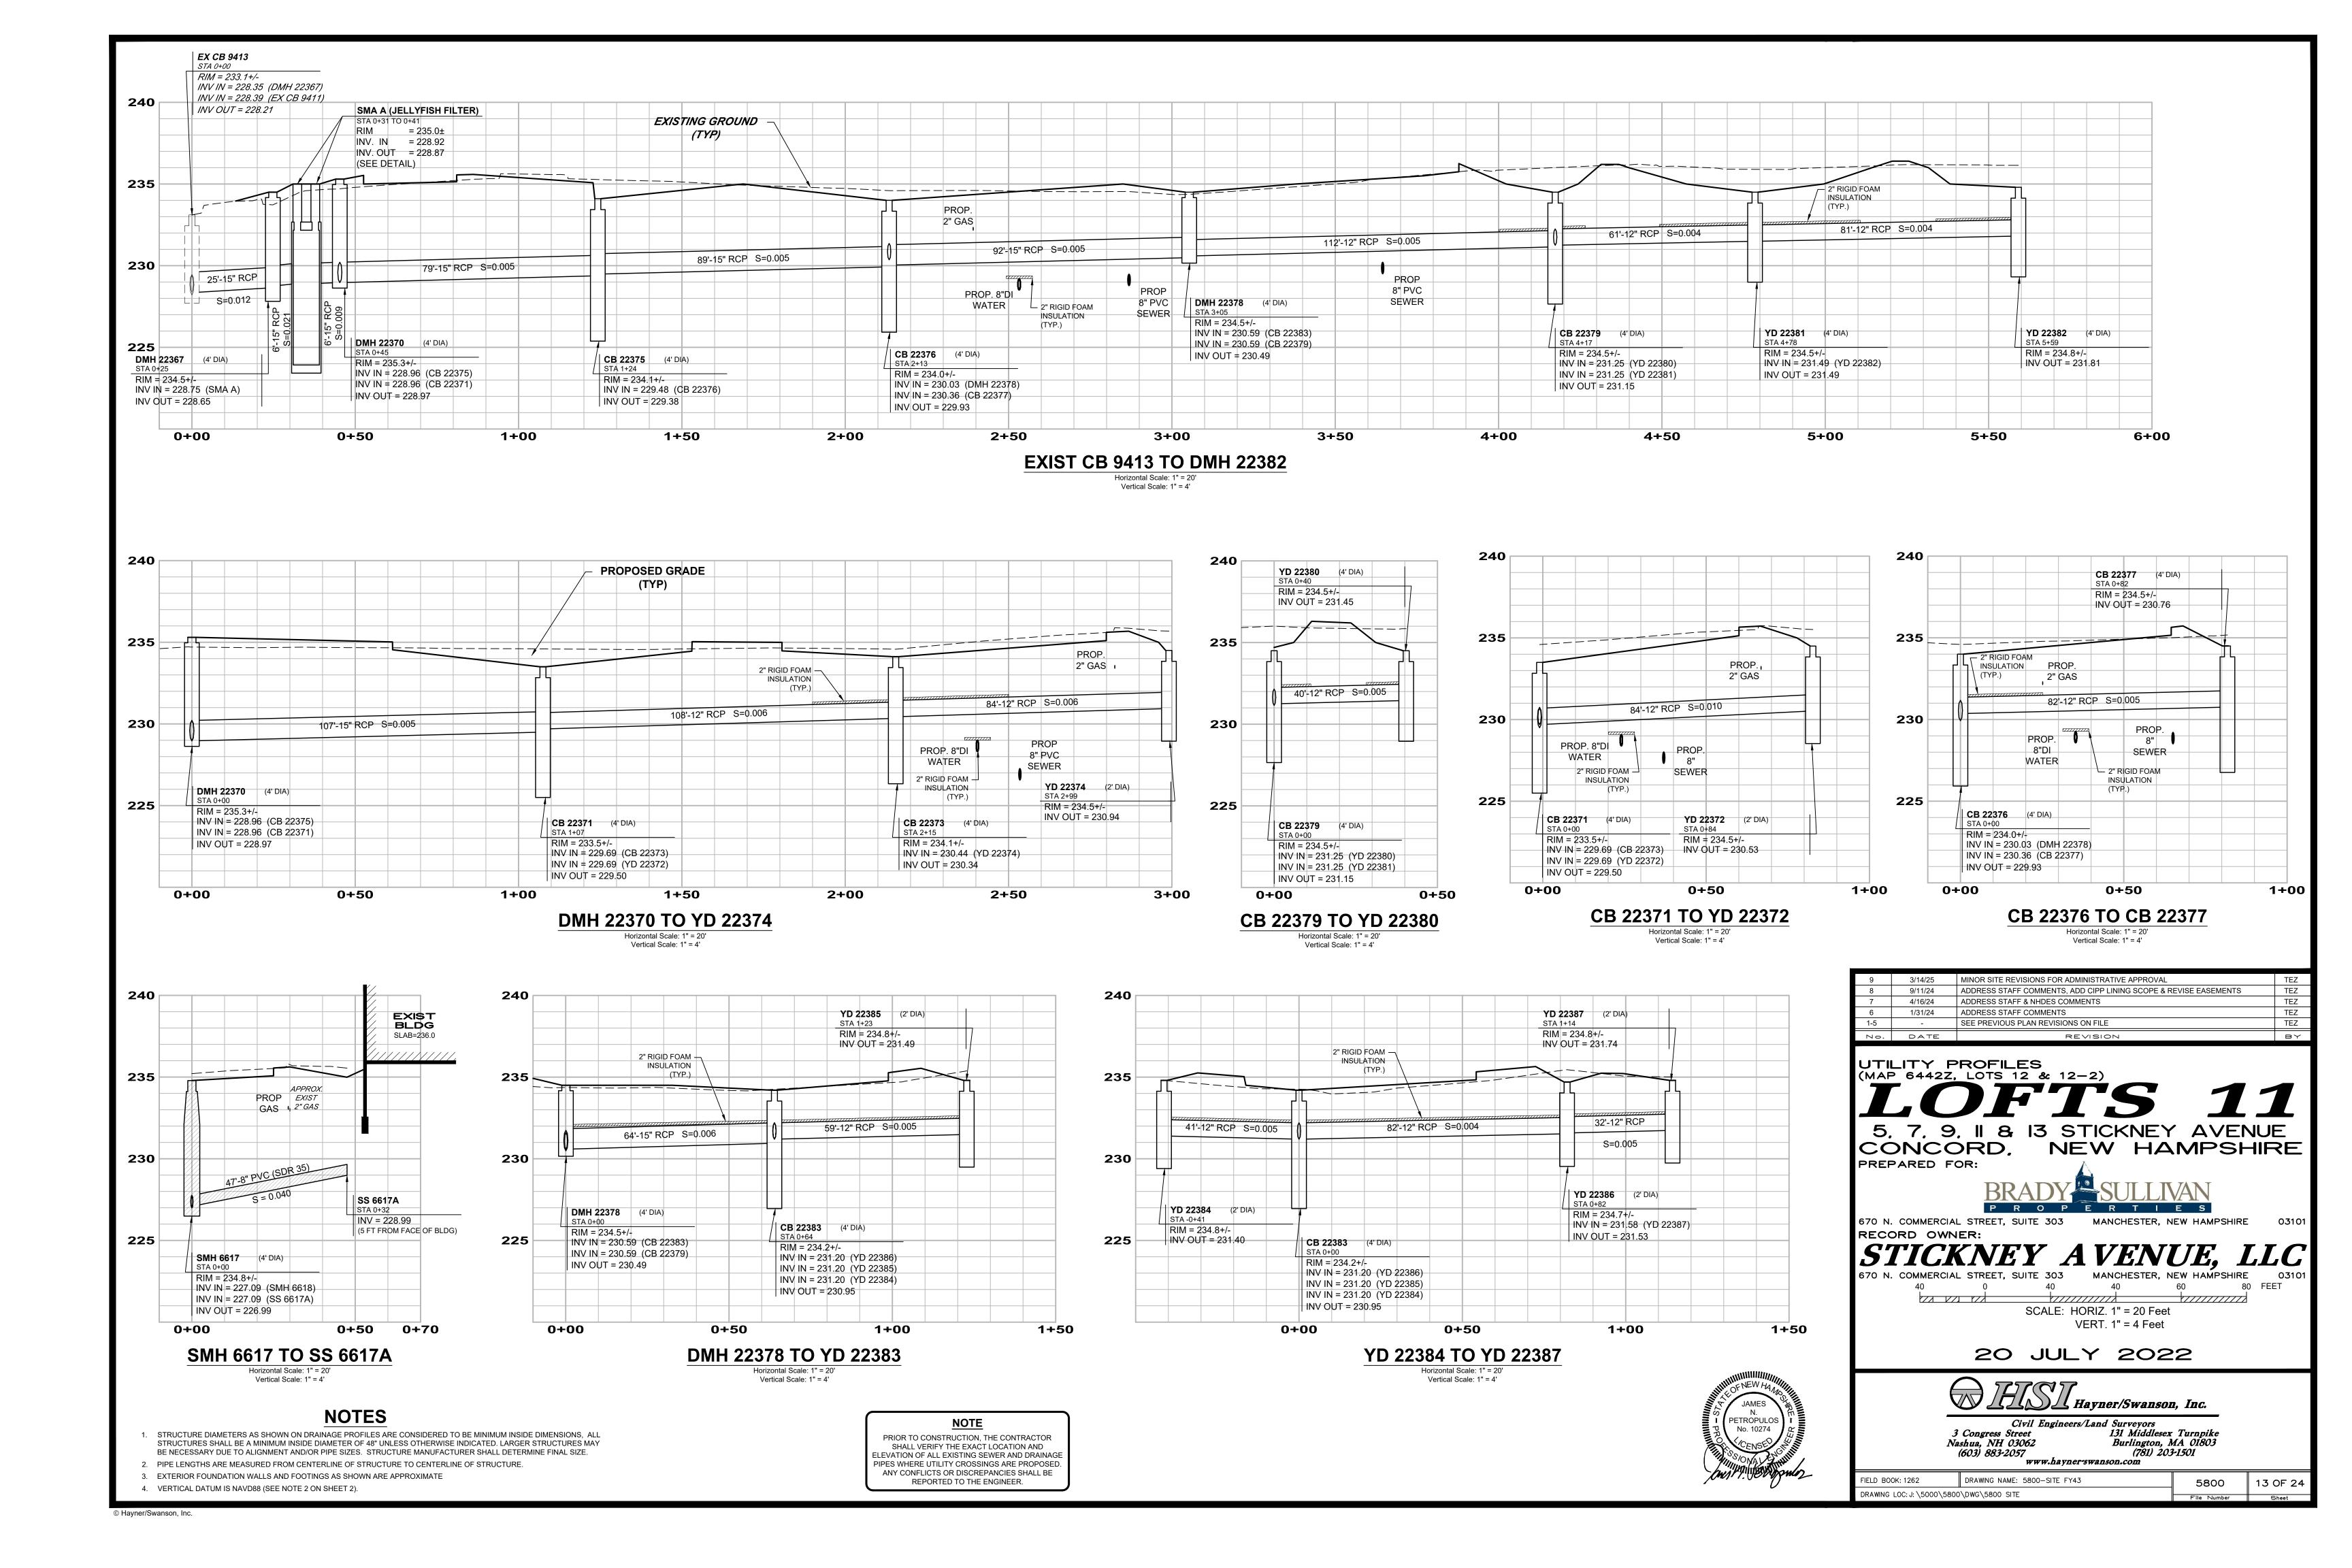

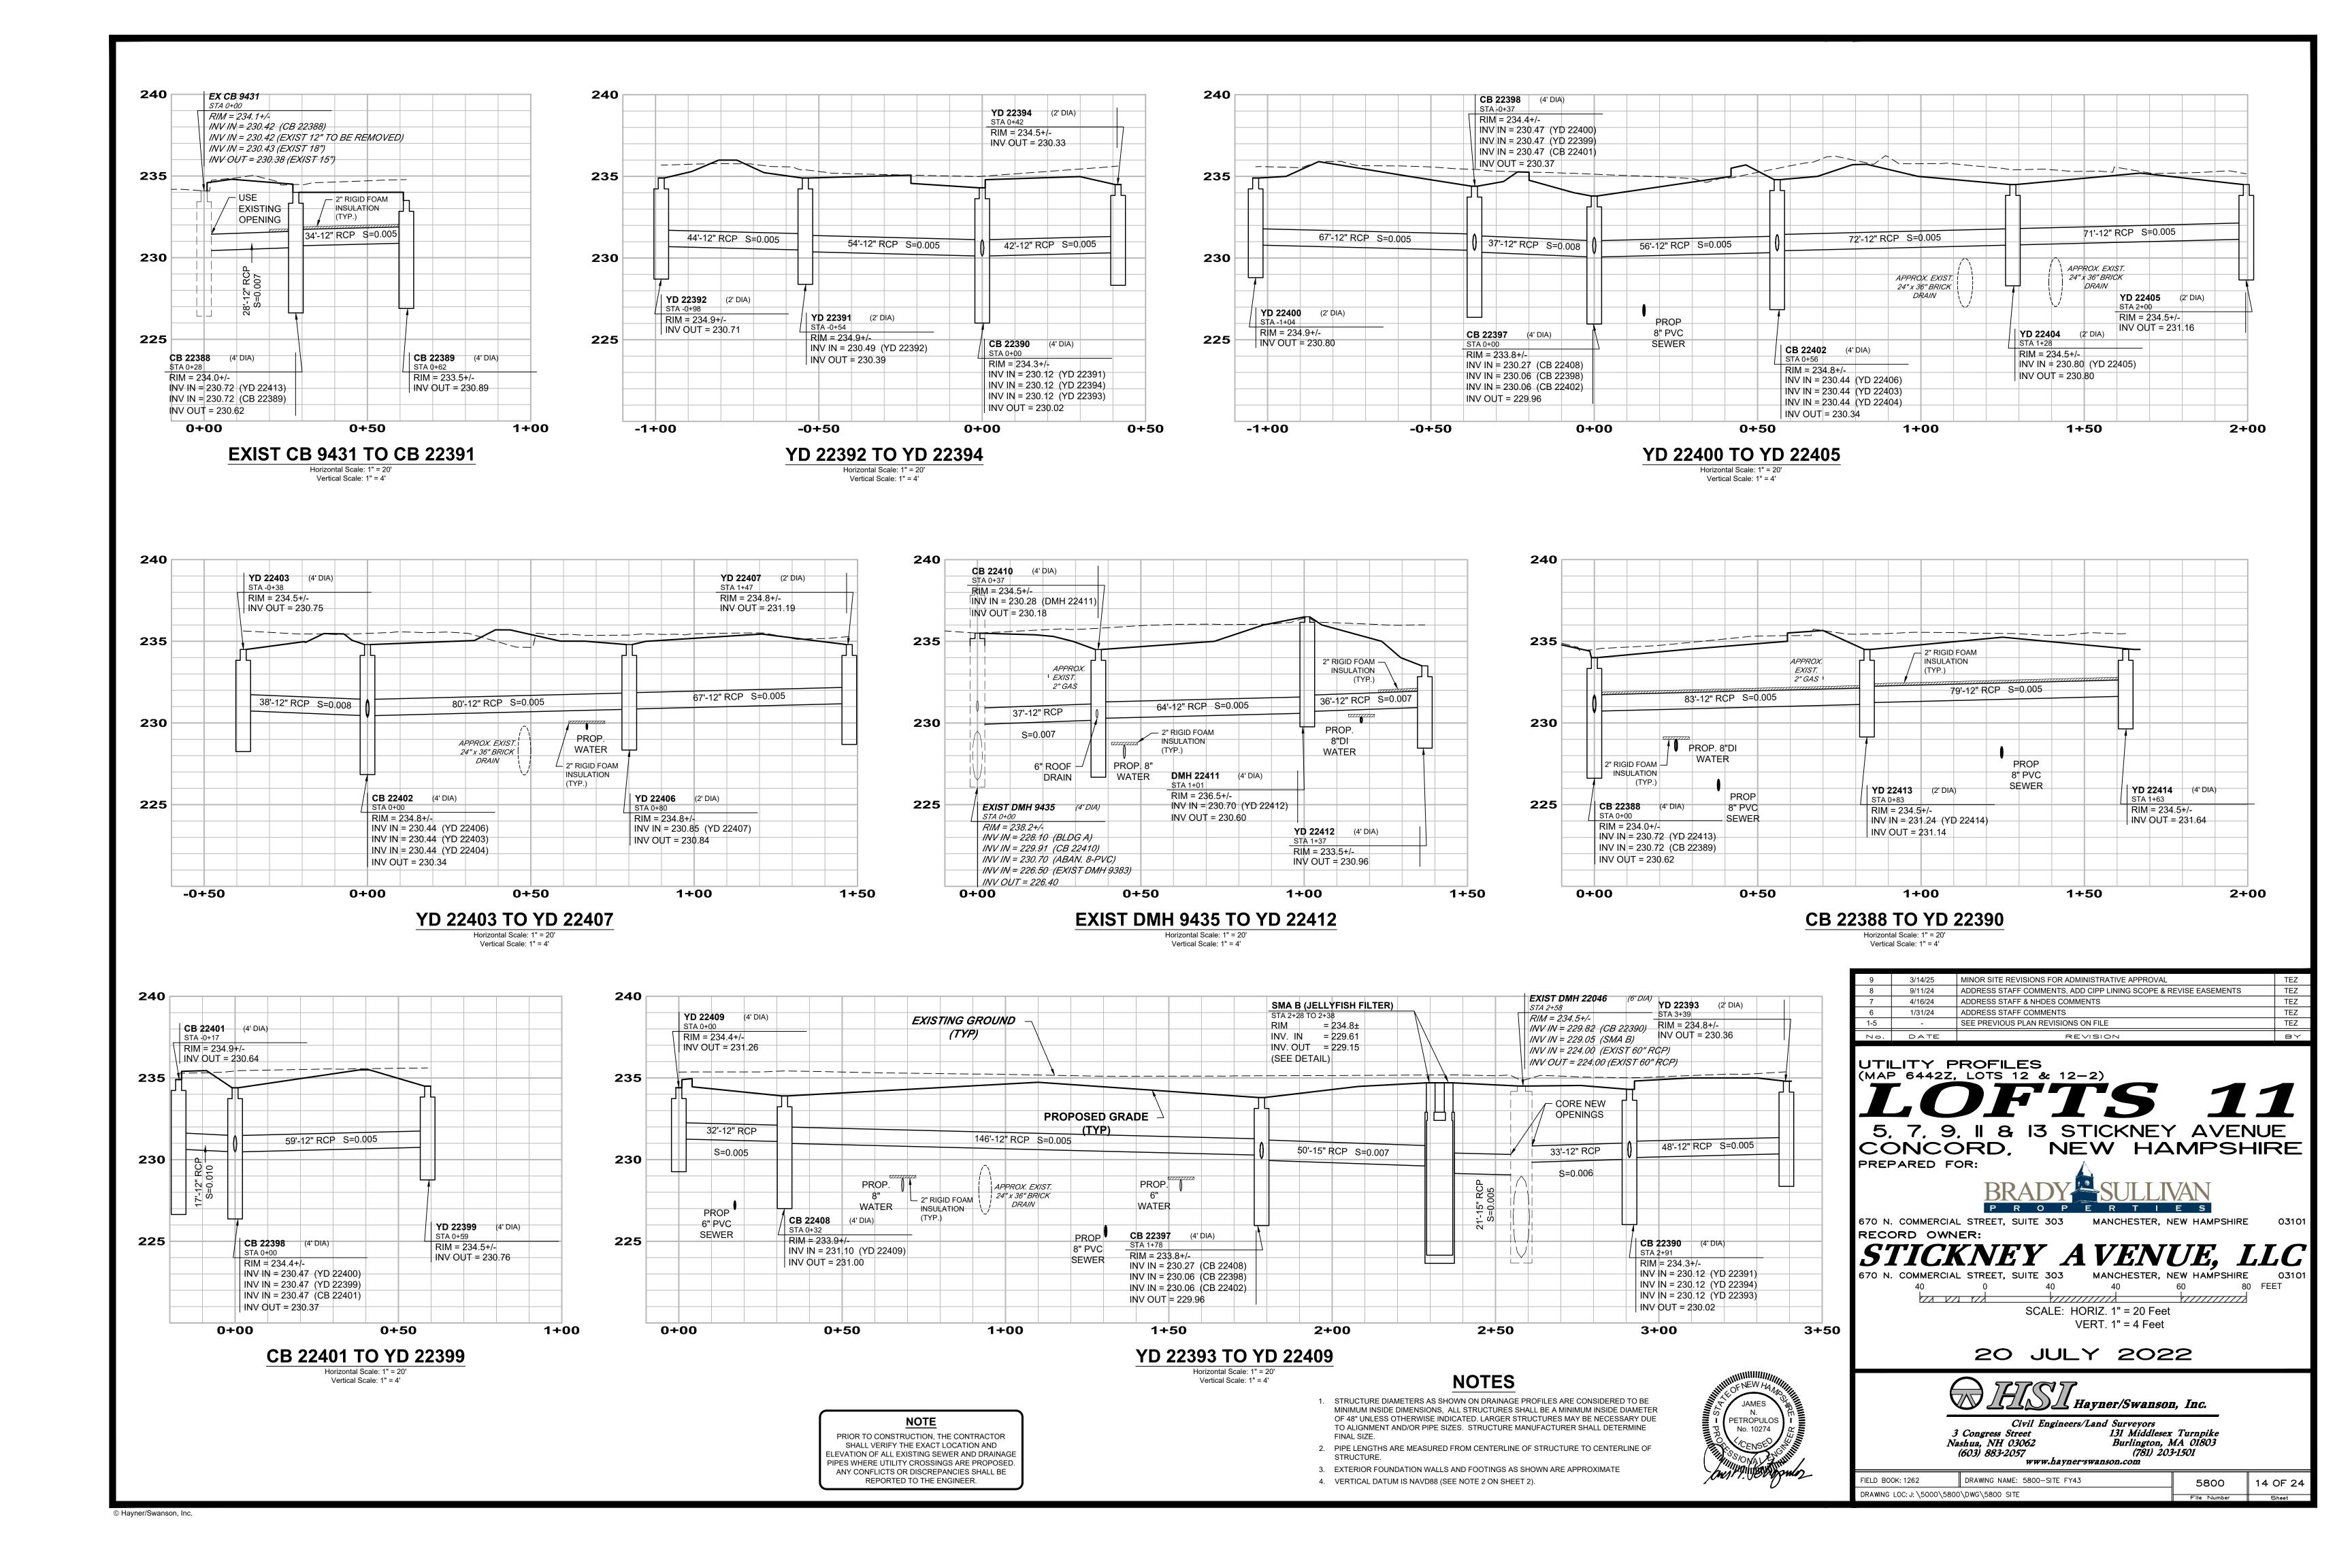

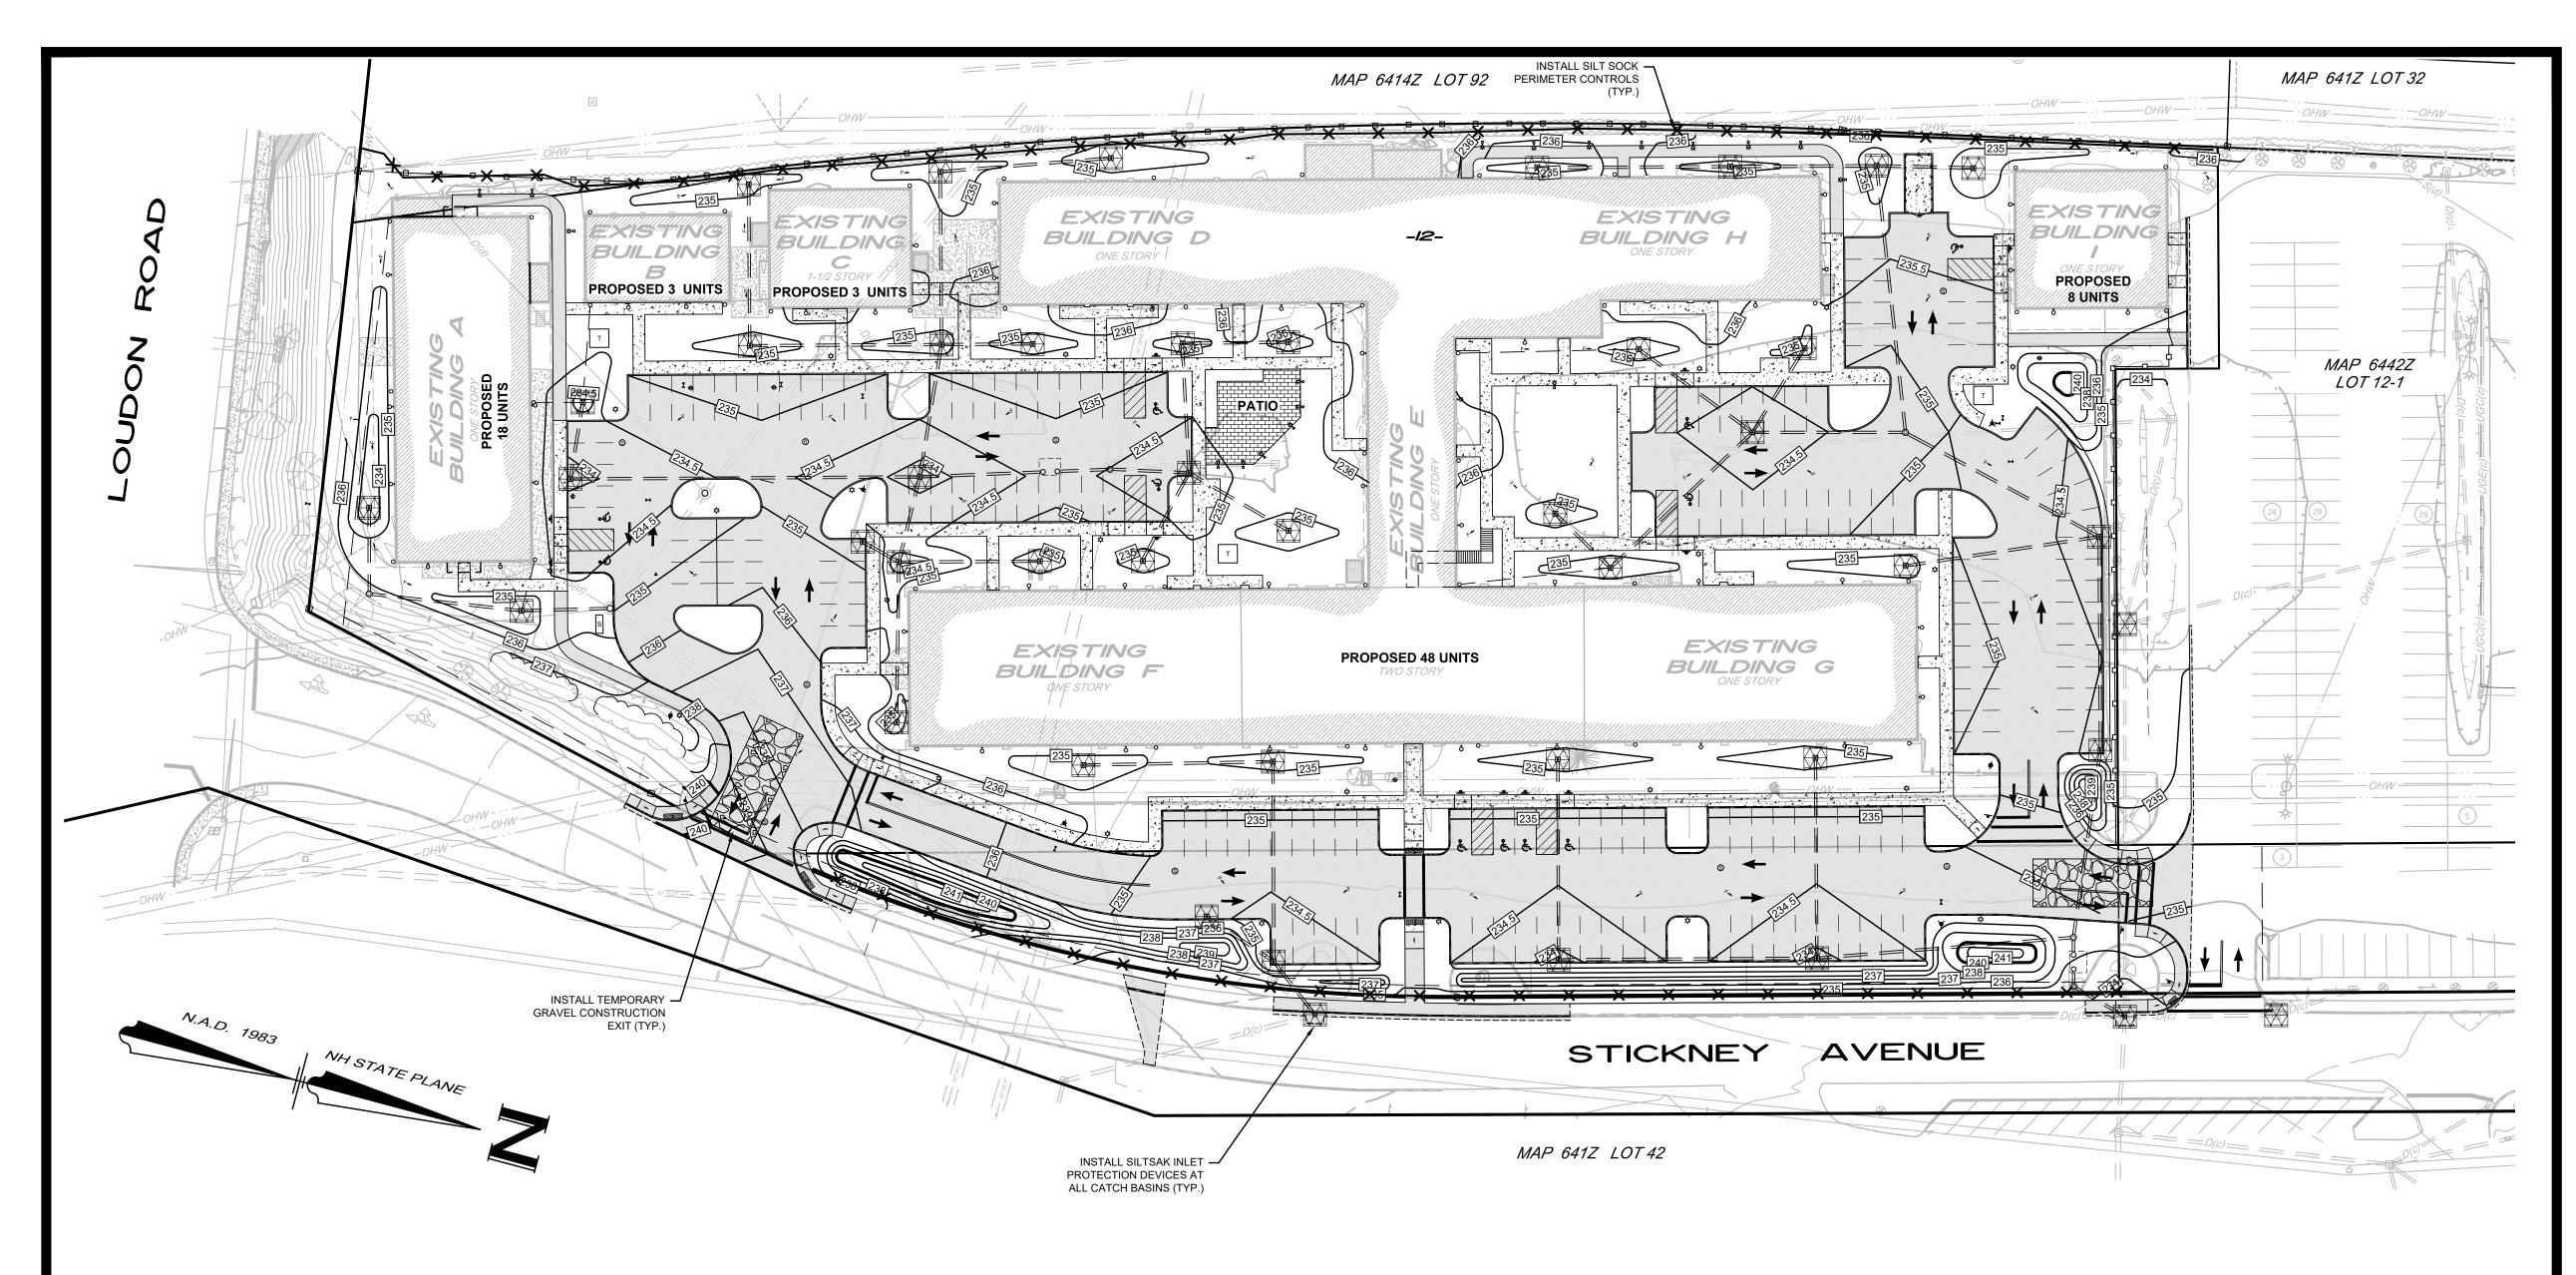

NHDES/NHFG PERMIT CONDITIONS


- 1. COMMON NIGHTHAWK (ENDANGERED), OCCUR WITHIN THE VICINITY OF THE PROJECT AREA. ALL OPERATORS AND PERSONNEL WORKING ON OR ENTERING THE SITE SHALL BE MADE AWARE OF THE POTENTIAL PRESENCE OF THESE SPECIES AND SHALL BE PROVIDED FLYERS THAT HELP TO IDENTIFY THESE SPECIES, ALONG WITH NHFG CONTACT INFORMATION. SEE THIS SHEET.
- 2. RARE WILDLIFE SPECIES INFORMATION (E.G. IDENTIFICATION, OBSERVATION AND REPORTING OF OBSERVATIONS, WHEN TO CONTACT NHFG IMMEDIATELY AND NHFG CONTACT INFORMATION) SHALL BE COMMUNICATED DURING MORNING TAILGATE MEETINGS PRIOR TO WORK COMMENCEMENT DURING THE CONSTRUCTION PHASE OF THE
- 3. ALL MANUFACTURED EROSION AND SEDIMENT CONTROL PRODUCTS, WITH THE EXCEPTION OF TURF REINFORCEMENT MATS, UTILIZED FOR, BUT NOT LIMITED TO, SLOPE PROTECTION, RUNOFF DIVERSION, SLOPE INTERRUPTION, PERIMETER CONTROL, INLET PROTECTION, CHECK DAMS, AND SEDIMENT TRAPS SHALL NOT CONTAIN PLASTIC, OR MULTIFILAMENT OR MONOFILAMENT POLYPROPYLENE NETTING OR MESH WITH AN OPENING SIZE OF
- 4. ALL OBSERVATIONS OF THREATENED OR ENDANGERED SPECIES ON THE PROJECT SITE SHALL BE REPORTED IMMEDIATELY TO THE NHFG NONGAME AND ENDANGERED WILDLIFE ENVIRONMENTAL REVIEW PROGRAM BY PHONE AT 603-271-2461 AND BY EMAIL AT NHFGREVIEW@WILDLIFE.NH.GOV, WITH THE EMAIL SUBJECT LINE CONTAINING THE NHB DATACHECK TOOL RESULTS LETTER ASSIGNED NUMBER, THE PROJECT NAME, AND THE TERM WILDLIFE
- 5. PHOTOGRAPHS OF THE OBSERVED SPECIES AND NEARBY ELEMENTS OF HABITAT OR AREAS OF LAND DISTURBANCE SHALL BE PROVIDED TO NHFG IN DIGITAL FORMAT AT THE ABOVE EMAIL ADDRESS FOR VERIFICATION, AS FEASIBLE. 6. IN THE EVENT A THREATENED OR ENDANGERED SPECIES IS OBSERVED ON THE PROJECT SITE DURING THE TERM OF
- THE PERMIT, THE SPECIES SHALL NOT BE DISTURBED, HANDLED, OR HARMED IN ANY WAY PRIOR TO CONSULTATION WITH NHFG AND IMPLEMENTATION OF CORRECTIVE ACTIONS RECOMMENDED BY NHFG. 7. ALL CONSTRUCTION MATERIALS AND MATERIALS RELATED TO CONSTRUCTION SHALL BE REMOVED FROM THE
- PROPERTY UPON COMPLETION OF WORK.
- 8. THE NHFG, INCLUDING ITS EMPLOYEES AND AUTHORIZED AGENTS, SHALL HAVE ACCESS TO THE PROPERTY DURING THE TERM OF THE PERMIT

LEGEND

EXISTING GROUND CONTOUR PROPOSED GRADE RUNOFF DIRECTION F-SILT SOCK PERIMETER BARRIER GRAVEL CONSTRUCTION EXIT

SILT-SACK INLET PROTECTION DEVICES MA.ME.NH.RI.VT CONTACT DIG SAFE 72 HOURS PRIOR TO CONSTRUCTION digsafe.com STABILIZATION MATTING DIAL 811 or 1-888-DIG-SAFE TEMPORARY STONE CHECK DAM



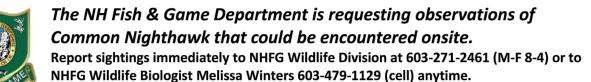





- Nests protected Medium-sized bird (about the size of a
- dove) ~ 9 inches from tip to end of tail Wingspan is 21-22 inches

Well camouflaged with mottling


- pattern of browns, black and grey Distinct, broad, white patch on underside of each outer wing (visible when flying)
- "peent" sounding call



- Nesting occurs typically between mid-late May and early Nests usually consists of 2 eggs that are dark and speckled
- May have more than 1 nest in a season
- Nest is not "built" but rather eggs are laid directly on the ground in an open area (gravel, bare dirt, pea stone,
- Incubation is for 16-20 days another 30 plus days for



- An adult doing a broken wing display if driven from
- Adults may also hiss and open their mouth at you if

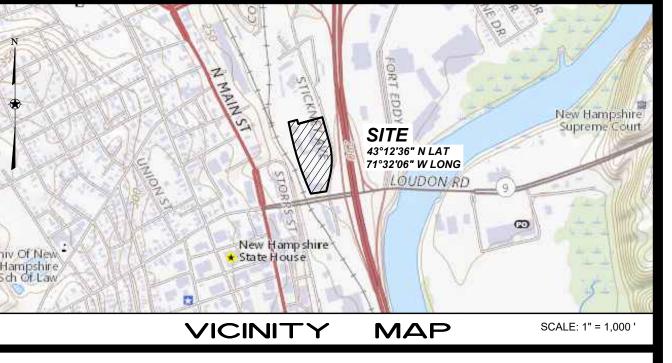

GENERAL NOTES:

- ALL CONTRACTORS AND SUBCONTRACTORS INVOLVED WITH STORMWATER POLLUTION PREVENTION SHALL OBTAIN A COPY OF THE STORMWATER POLLUTION PREVENTION PLAN (SWPPP) AND NATIONAL POLLUTION DISCHARGE ELIMINATION SYSTEM (NPDES) CONSTRUCTION GENERAL PERMIT (CGP) AND BECOME FAMILIAR WITH THEIR CONTENTS.
- SWPPP. ADDITIONAL BEST MANAGEMENT PRACTICES SHALL BE IMPLEMENTED AS DICTATED BY SITE CONDITIONS AT NO ADDITIONAL COST OF OWNER THROUGHOUT ALL PHASES OF CONSTRUCTION.


THE CONTRACTOR SHALL IMPLEMENT BEST MANAGEMENT PRACTICES AS REQUIRED BY THE

- BEST MANAGEMENT PRACTICES (BMP'S) AND CONTROLS SHALL CONFORM TO FEDERAL STATE, OR LOCAL REQUIREMENTS OR MANUAL OF PRACTICE, AS APPLICABLE. CONTRACTOR SHALL IMPLEMENT ADDITIONAL CONTROLS AS DIRECTED BY PERMITTING AGENCY OR OWNER.
- EARTH MATERIAL STOCKPILE AREAS SHALL BE SURROUNDED BY SILT SOCKS AND STABILIZED IF THEY WILL BE UNUSED FOR FOURTEEN (14) DAYS OR MORE.
- ALL MEASURES STATED ON THIS EROSION CONTROL PLAN, AND IN THE STORMWATER POLLUTION PREVENTION PLAN, SHALL BE MAINTAINED IN FULLY FUNCTIONAL CONDITION UNTIL NO LONGER REQUIRED FOR A COMPLETE PHASE OF WORK OR FINAL STABILIZATION OF THE SITE. ALL EROSION CONTROL MEASURES SHALL BE CHECKED BY A QUALIFIED PERSON IN ACCORDANCE WITH THE CONTRACT DOCUMENTS OR THE APPLICABLE PERMIT, WHICHEVER IS
 - SILT SOCKS SHALL BE REPAIRED TO THEIR ORIGINAL CONDITIONS IF DAMAGED. SEDIMENT SHALL BE REMOVED FROM SILT SOCKS WHEN IT REACHES ONE-QUARTER THE HEIGHT OF THE
- INLET PROTECTION DEVICES AND BARRIERS SHALL BE REPAIRED OR REPLACED IF THEY SHOW SIGNS OF UNDERMINING OR DETERIORATION.
- ALL SEEDED AREAS SHALL BE CHECK REGULARLY TO SEE THAT A GOOD STAND IS MAINTAINED. AREAS SHOULD BE FERTILIZED, WATERED AND RESEEDED AS NEEDED.
- THE TEMPORARY GRAVEL CONSTRUCTION EXITS SHALL BE MAINTAINED IN A CONDITION WHICH WILL PREVENT TRACKING OR FLOW OF MUD ONTO PUBLIC RIGHT-OF WAY. THIS MAY REQUIRE PERIODIC TOP DRESSING AS CONDITIONS DEMAND.
- PROPER CONSTRUCTION DEWATERING PRACTICES MUST BE USED IN ORDER TO PREVENT DISCHARGED WATER FROM ERODING SOIL ON SITE AND THE SEDIMENTATION OF DOWNSTREAM WATER RESOURCES. METHODS FOR SETTLING OR FILTERING SEDIMENT FROM DEWATERING INCLUDE TEMPORARY BASIN/SEDIMENT TRAPS AND MANUFACTURED FABRIC BAGS DESIGNED FOR FILTERING PUMPED DISCHARGES. DURING DEWATERING ACTIVITIES, INSPECTION OF THE DEWATERING FACILITY SHOULD BE PERFORMED DAILY OR MORE FREQUENTLY AS WARRANTED BY SITE CONDITIONS.

CONSTRUCTION SEQUENCE:

- INSTALL GRAVEL CONSTRUCTION EXIT AND SILT SOCK PERIMETER CONTROLS PRIOR TO COMMENCING EARTH DISTURBANCE ACTIVITIES.
- INSTALL SILT SACK INLET PROTECTION AROUND EXISTING STORM DRAIN STRUCTURES ON SITE. THE CONTROL SHALL REMAIN UNTIL THE SITE IS SUFFICIENTLY STABILIZED.
- PERFORM SITE DEMOLITION, INCLUDING REMOVAL OF EXISTING PAVEMENT AND UTILITIES.
- PERFORM SITE GRADING OF PARKING AREAS. STORMWATER BMP'S AND DRAINAGE SWALES MUST BE INSTALLED PRIOR TO ROUGH GRADING OF THE SITE. RUNOFF SHALL BE DIRECTED TO TEMPORARY PRACTICES UNTIL STORMWATER BMP'S ARE STABILIZED. ALL SLOPE AREAS SHALL BE LOAMED AND SEEDED AND MULCHED IMMEDIATELY AFTER BEING CONSTRUCTED
- INSTALL SITE UTILITIES IN ACCORDANCE WITH THE PLAN.
- PREPARE SITE FOR PAVING.
- LOAM AND SEED ALL DISTURBED AREAS. COMPLETED AREAS SHALL BE STABILIZED 72 HOURS AFTER COMPLETION.
- ALL PERMANENT STORMWATER MANAGEMENT MEASURES SHALL HAVE A HEALTHY STAND OF VEGETATION ESTABLISHED PRIOR TO DIRECTING RUNOFF INTO THEM.
- FINAL PAVING OF PARKING AND DRIVEWAYS.
 - INSPECTION OF ALL SEDIMENT AND EROSION CONTROL MEASURES.
- INSTALL SITE LANDSCAPING ALONG WITH PERMANENT SEEDING OF DISTURBED AREAS.
- REMOVE ANY TEMPORARY EROSION CONTROL MEASURES NOT NEEDED.

9	3/14/25	MINOR SITE REVISIONS FOR ADMINISTRATIVE APPROVAL	TEZ
8	9/11/24	ADDRESS STAFF COMMENTS, ADD CIPP LINING SCOPE & REVISE EASEMENTS	TEZ
7	4/16/24	ADDRESS STAFF & NHDES COMMENTS	TEZ
6	1/31/24	ADDRESS STAFF COMMENTS	TEZ
1-5	-	SEE PREVIOUS PLAN REVISIONS ON FILE	TEZ
Νο.	DATE	REVISION	BY
170.		RE VISION	

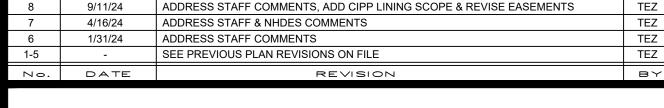

EROSION CONTROL PLAN

5, 7, 9, II & I3 STICKNEY AVENUE

CONCORD, NEW HAMPSHIRE PREPARED FOR:



670 N. COMMERCIAL STREET, SUITE 303 MANCHESTER, NEW HAMPSHIRE RECORD OWNER:

40 METERS SCALE: 1"=40 Feet

20 JULY 2022





3 Congress Street Nashua, NH 03062 (603) 883-2057

131 Middlesex Turnpike (781) 203-1501 www.havner-swanson.com

DRAWING NAME: 5800-SITE ER42 TELD BOOK: 1262 RAWING LOC: J: \5000\5800\DWG\5800 SITE

15 OF 24

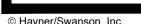

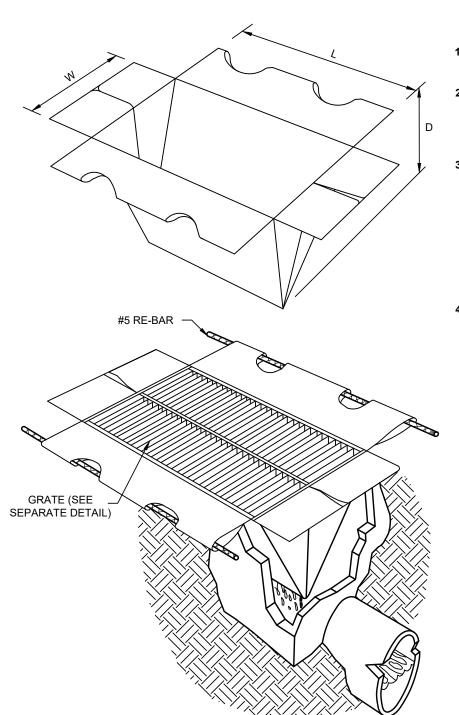

SILTSAK® NOTES:


- 1.0 THE SILTSAK® SHALL BE MANUFACTURED FROM WOVEN POLYPROPYLENE AND SEWN BY A DOUBLE NEEDLE MACHINE, USING A HIGH STRENGTH NYLON THREAD.
- 2.0 THE SILTSAK® SEAMS SHALL HAVE A CERTIFIED AVERAGE WIDE WIDTH STRENGTH PER ASTM D-4884 STANDARDS AS FOLLOWS: SILTSAK® STYLE TEST METHOD TEST METHOD REGULAR FLOW ASTM D-4884 165.O LBS/IN
- HI-FLOW ASTM D-4884 114.6 LBS/IN THE SILTSAK® WILL BE MANUFACTURED TO FIT THE OPENING OF THE CATCH BASIN OR DROP INLET. THE SILTSAK® WILL HAVE THE FOLLOWING FEATURES: TWO DUMP STRAPS ATTACHED AT THE BOTTOM TO FACILITATE THE EMPTYING OF THE SILTSAK®: THE SILTSAK® SHALL HAVE LIFTING LOOPS AS AN INTEGRAL PART OF THE SYSTEM TO BE USED TO LIFT THE SILTSAK® FROM THE BASIN; THE SILTSAK® SHALL HAVE A RESTRAINT CORD APPROXIMATELY HALFWAY UP THE SACK TO KEEP THE SIDES AWAY FROM THE CATCH BASIN WALLS, THIS YELLOW CORD IS ALSO A VISIBLE MEANS OF INDICATING WHEN THE SACK SHOULD BE EMPTIED,
- CLEANED, AND PLACED BACK INTO THE BASIN. 4.0 THE GEOTEXTILE FABRIC SHALL BE WOVEN POLYPROPYLENE


	RIC WITH THE FOLLOW		POLYPROPYLENE
ΛL			
	SILTSAK® REGULAR FL	LOVV	
	PROPERTY	TEST METHOD	TEST RESULT
	GRAB TENSILE	ASTM D-4632	300 LBS
	GRAB ELONGATION	ASTM D-4631	20%
	PUNCTURE	ASTM D-4833	120 LBS
	MULLEN BURST	ASTM D-3786	800 PSI
	TRAPEZOID TEAR	ASTM D-4533	120 LBS
	UV RESISTANCE	ASTM D-4355	80%
	APPARENT OPENING	ASTM D-4751	40 US SIEVE
	FLOW RATE	ASTM D-4491	40 GAL/MIN/FT2
	PERMITTIVITY	ASTM D-4491	0.55 SEC

OR SILTSAK® HI-FLOW		
PROPERTY	TEST METHOD	TEST RESULT
GRAB TENSILE	ASTM D-4632	265 LBS
GRAB ELONGATION	ASTM D-4632	20%
PUNCTURE	ASTM D-4833	135 LBS
MULLEN BURST	ASTM D-3786	420 PSI
TRAPEZOID TEAR	ASTM D-4533	45 LBS
UV RESISTANCE	ASTM D-4355	90%
APPARENT OPENING	ASTM D-4751	20 US SIEVE
FLOW RATE	ASTM D-4491	200 GAL/MIN/FT2

ASTM D-4491

1.5 SEC

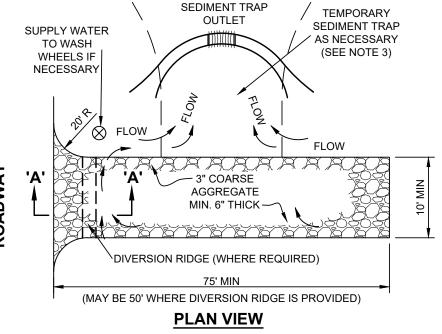

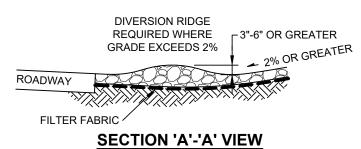

PERMITTIVITY

- THE EXIT SHALL BE MAINTAINED IN A CONDITION THAT WILL PREVENT THIS MAY REQUIRE TOP DRESSING, REPAIR AND/OR CLEAN OUT OF ANY MEASURES USED TO TRAP SEDIMENT
- THE SITE ONTO A PUBLIC RIGHT-OF-WAY
- WHEN WASHING IS REQUIRED, IT SHALL BE DONE ON AN AREA STABILIZED WITH CRUSHED STONE THAT DRAINS INTO AN APPROVED SEDIMENT TRAP OR SEDIMENT BASIN
- CONSTRUCTION SPECIFICATIONS AND MAINTENANCE REQUIREMENTS

- WHEN NECESSARY, WHEELS SHALL BE CLEANED PRIOR TO EXITING
- SHOWN IN NHDES STORMWATER MANUAL VOLUME 3.

TEMPORARY GRAVEL CONSTRUCTION EXIT

2"x2" WOODEN

WORK ARFA

EROSION CONTROL FILTER SHALL BE FILTERMITT OR SILTSOXX OR APPROVED EQUAL.

3. COMPOST TO BE REMOVED OR DISPOSED ON-SITE AS DETERMINED BY THE ENGINEER.

2. EROSION CONTROL FILTER SHALL BE INSTALLED IN ACCORDANCE WITH

MANUFACTURER'S RECOMMENDATIONS.

1. SILT SOCK BARRIER SHALL BE INSPECTED IMMEDIATELY AFTER EACH RAINFALL AND AT LEAST DAILY DURING

2. IF THE SILT SOCK SHOULD DECOMPOSE OR BECOME INEFFECTIVE DURING THE EXPECTED LIFE OF THE FENCE, THE

4. SEDIMENT DEPOSITS THAT ARE REMOVED OR LEFT IN PLACE AFTER THE BARRIER HAS BEEN REMOVED SHALL BE

3. SEDIMENT DEPOSITS SHOULD BE INSPECTED AFTER EVERY STORM EVENT. THE DEPOSITS SHOULD BE REMOVED WHEN

CONSTRUCTION SPECIFICATIONS

2. THE FABRIC SHALL BE EMBEDDED A MINIMUM OF 8 INCHES INTO THE GROUND AND THE SOIL COMPACTED OVER THE

4. FILTER CLOTH SHALL BE FASTENED SECURELY TO THE WOVEN WIRE FENCE WITH TIES SPACED EVERY 24 INCHES AT

6. FENCE POSTS SHALL BE A MINIMUM OF 36 INCHES LONG AND DRIVEN A MINIMUM OF 16 INCHES INTO THE GROUND.

7. MAINTENANCE SHALL BE PERFORMED AS NEEDED TO PREVENT BULGES IN THE SILT FENCE DUE TO DEPOSITION OF

5. WHEN TWO SECTIONS OF FILTER CLOTH ADJOIN EACH OTHER, THEY SHALL BE OVERLAPPED BY 6 INCHES, FOLDED, AND

WOOD POSTS SHALL BE OF SOUND QUALITY HARDWOOD AND SHALL HAVE A MINIMUM CROSS SECTIONAL AREA OF 3.0

3. WOVEN WIRE FENCE SHALL BE FASTENED SECURELY TO THE FENCE POSTS WITH WIRE TIES OR STAPLES.

PROLONGED RAINFALL. ANY REPAIRS THAT ARE REQUIRED SHALL BE MADE IMMEDIATELY.

THEY REACH APPROXIMATELY ONE-THIRD THE HEIGHT OF THE BARRIER.

GRADED TO CONFORM WITH THE EXISTING TOPOGRAPHY AND VEGETATED.

1. THE GEOTEXTILE FABRIC SHALL MEET THE DESIGN CRITERIA FOR SILT FENCES.

BARRIER SHALL BE REPLACED PROMPTLY.

THE TOP, MID-SECTION, AND BOTTOM.

EMBEDDED FABRIC.

SEDIMENT

MAINTENENCE

SECTION VIEW

AREA TO BE PROTECTED

EROSION CONTROL FILTER -


AREA TO BE


PROTECTED

(12"-18" TYPICAL)

ON CENTER

- STABILIZATION MATTING BY NORTH AMERICAN GREEN BIONET S150BN, OR APPROVED EQUAL

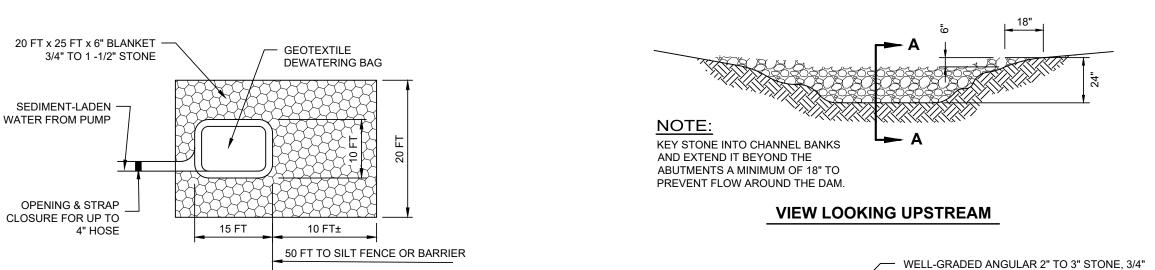


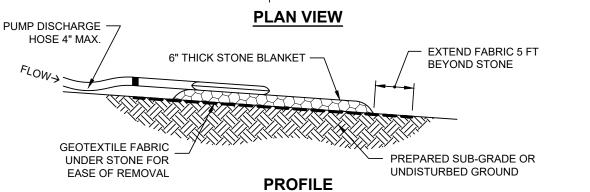

© Hayner/Swanson, Inc

- 1. GEOTEXTILE BAG MATERIAL BASED ON PARTICLE SIZE IN PUMPED WATER, I.E., FOR COARSE PARTICLES A WOVEN MATERIAL; FOR SILT/CLAYS A NON-WOVEN MATERIAL. 2. DO NOT OVER PRESSURIZE BAG OR USE BEYOND CAPACITY.
- 3. LOCATE DISCHARGE SITE ON FLAT UPLAND AREAS AS FAR AWAY AS POSSIBLE FROM STREAMS, WETLANDS, OTHER RESOURCES AND POINTS OF CONCENTRATED FLOW.
- 4. DOWNGRADIENT FROM RECEIVING AREA MUST BE WELL VEGETATED OR OTHERWISE
- STABILE FROM EROSION, E.G. FOREST FLOOR OR COARSE GRAVEL/STONE. 5. DISCHARGE LOCATION SHALL MEET ALL REGULATORY SETBACKS FROM WETLANDS AND OTHER WATER COURSES.

GEOTEXTILE DEWATERING BAG DETAIL

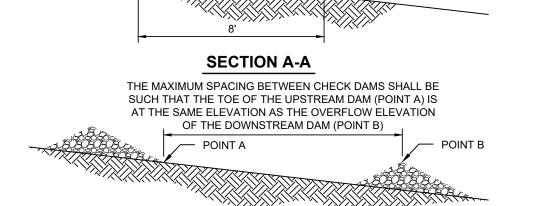

STONE ON THE UPGRADIENT FACE IS

RECOMMENDED FOR BETTER FILTERING

TEMPORARY STONE CHECK DAM TYPICAL SECTION

NOT TO SCALE

SPACING BETWEEN CHECK DAMS

2 BEGIN AT THE TOP OF THE SLOPE BY ANCHORING THE BLANKET IN A 6" DEEP X 6" WIDE TRENCH WITH APPROXIMATELY 12" OF BLANKET EXTENDED BEYOND THE UP-SLOPE PORTION OF THE TRENCH.

1. PREPARE SOIL BEFORE INSTALLING BLANKETS, INCLUDING ANY NECESSARY APPLICATION OF LIME,

- ANCHOR THE BLANKET WITH A ROW OF STAPLES/STAKES APPROXIMATELY 12" APART IN THE BOTTOM OF THE TRENCH. BACKFILL AND COMPACT THE TRENCH AFTER STAPLING. APPLY SEED TO COMPACTED SOIL AND FOLD REMAINING 12" PORTION OF BLANKET BACK OVER SEED AND COMPACTED SOIL. SECURE BLANKET OVER COMPACTED SOIL WITH A ROW OF STAPLES/STAKES SPACED APPROXIMATELY 12" APART ACROSS THE WIDTH OF THE BLANKET.
- 3. ROLL THE BLANKETS (A.) DOWN OR (B.) HORIZONTALLY ACROSS THE SLOPE. BLANKETS WILL UNROLL WITH APPROPRIATE SIDE AGAINST THE SOIL SURFACE. ALL BLANKETS MUST BE SECURELY FASTENED TO SOIL SURFACE BY PLACING STAPLES/STAKES IN APPROPRIATE LOCATIONS AS PER MANUFACTURES
- 4. 4. THE EDGES OF PARALLEL BLANKETS MUST BE STAPLED WITH MINIMUM 6" OVERLAP. TO ENSURE PROPER SEAM ALIGNMENT, PLACE THE EDGE OF THE OVERLAPPING BLANKET (BLANKET BEING INSTALLED ON TOP) EVEN WITH THE SEAM STITCH ON THE PREVIOUSLY INSTALLED BLANKET.
- 5. CONSECUTIVE BLANKETS SPLICED DOWN THE SLOPE MUST BE PLACED END OVER END (SHINGLE STYLE) WITH AN APPROXIMATE 3" OVERLAP. STAPLE THROUGH OVERLAPPED AREA, APPROXIMATELY 12" APART ACROSS ENTIRE BLANKET WIDTH
- 6. PLACE STAPLES/STAKES PER MANUFACTURE RECOMMENDATION FOR THE APPROPRIATE SLOPE BEING

NOTE: IN LOOSE SOIL CONDITIONS, THE USE OF STAPLE OR STAKE LENGTHS GREATER THAN 6"

STABILIZATION MATTING DETAIL

NOT TO SCALE

GENERAL NOTES

- ALL SOIL EROSION AND SEDIMENT CONTROL MEASURES SHALL BE IN ACCORDANCE WITH STANDARDS AND SPECIFICATIONS THEREOF IN NEW HAMPSHIRE DEPARTMENT OF ENVIRONMENTAL SERVICES STORMWATER MANUALS, VOLUME 1-3, LATEST EDITION.
- THE WORK AREA SHALL BE GRADED, SHAPED, AND OTHERWISE DRAINED IN SUCH A MANNER AS TO MINIMIZE SOIL EROSION, SILTATION OF DRAINAGE CHANNELS, DAMAGE TO EXISTING VEGETATION, AND DAMAGE TO PROPERTY OUTSIDE THE LIMITS OF THE WORK AREA. SILT FENCES, STRAW BALES AND/OR DETENTION BASINS WILL BE NECESSARY TO ACCOMPLISH THIS END.
- STRIPPED TOPSOIL SHALL BE STOCKPILED, WITHOUT COMPACTION, AND STABILIZED AGAINST EROSION IN ACCORDANCE WITH "TEMPORARY STABILIZATION OF DISTURBED AREAS", AS OUTLINED IN NOTE No. 4.
- TEMPORARY STABILIZATION OF DISTURBED AREAS SEED BED PREPARATION: 10-10-10 FERTILIZATION TO BE SPREAD AT THE RATE OF 7 LBS PER 1,000 SF AND AGRICULTURAL LIMESTONE AT A RATE OF 90 LBS PER 1,000 SF AND INCORPORATED INTO THE SOIL. THE

SOIL, FERTILIZER AND LIMESTONE SHALL BE TILLED TO PREPARE FOR SEEDING. A. SEED MIXTURE: USE ANY OF THE FOLLOWING:

SPECIES RATE PER 1,000 SF DEPTH SEEDING DATES WINTER RYE 08/15 TO 09/15 2.5 LBS OATS 2.5 LBS 04/15 TO 10/15 1.0 LBS 0.25" 08/15 TO 09/15 ANNUAL RYE GRASS

B. MULCHING: MULCH SHOULD BE USED ON HIGHLY ERODABLE AREAS, AND WHERE CONSERVATION OF MOISTURE WILL FACILITATE PLANT ESTABLISHMENT AS FOLLOWS

RATE PER 1,000 SF **USE & COMMENTS** MAY BE USED WITH PLANTINGS, MUST BE STRAW 70 TO 90 LBS ANCHORED TO BE USED ALONE WOOD CHIPS OR 460 TO 920 LBS USED WITH TREE AND SHRUB PLANTINGS BARK MULCH FIBROUS MATTING AS RECOMMENDED MUST BE BIODEGRADABLE. USE IN SLOPE AREAS AND AREAS DIFFICULT TO BY MANUFACTURER VEGETATE.

PERMANENT STABILIZATION OF DISTURBED AREAS

CRUSHED STONE

ALL ROADWAYS SHALL BE STABILIZED WITHIN 72 HOURS OF ACHIEVING FINISHED GRADE. ALL CUT AND FILL SLOPES SHALL BE SEEDED/LOAMED WITHIN 72 HOURS OF ACHIEVING FINISHED

USE IN SPECIFIC AREAS AS SHOWN ON

PLAN OR AS NEEDED.

AN AREA SHALL BE CONSIDERED STABILIZED IF ONE OF THE FOLLOWING HAS OCCURRED:

SPREAD TO GREATER

THAN 1/2" THICKNESS

A. BASE COURSE GRAVELS HAVE BEEN INSTALLED IN AREAS TO BE PAVED. A MINIMUM OF 85% VEGETATED GROWTH HAS BEEN ESTABLISHED.

A MINIMUM OF 3 INCHES OF NON-EROSIVE MATERIAL SUCH AS STONE OR RIPRAP HAS BEEN

OR, EROSION CONTROL BLANKETS HAVE BEEN PROPERLY INSTALLED

7. ALL AREAS SHALL BE STABILIZED WITHIN 45 DAYS OF INITIAL DISTURBANCE.

NEW HAMPSHIRE DEPARTMENT OF ENVIRONMENTAL SERVICES ALTERATION OF TERRAIN PERMIT No: AOT-2471

43° 12' 36" N LATITUDE, 71° 32' 06" W LONGITUDE (PER GOOGLE EARTH)

10. TOTAL AREA OF DISTURBED SOILS: 184,000± SF.

- REFERENCE IS MADE TO THE LATEST EDITION OF THE FEDERAL REGISTER (63 FR 7857), ENVIRONMENTAL PROTECTION AGENCY NPDES GENERAL PERMITS FOR STORMWATER DISCHARGES FROM CONSTRUCTION ACTIVITIES. FOR ADDITIONAL INFORMATION CONTACT (202) 564-9545 OR www.epa.gov/npdes/stormwater.
- 12. THE ENTIRE CONTENTS OF THE STORMWATER POLLUTION PREVENTION PLAN (SWPPP) SHALL BE RETAINED ON-SITE FOR THE DURATION OF THE CONTRACT AND BE MADE AVAILABLE TO LOCAL, STATE AND FEDERAL CODE ENFORCEMENT PERSONNEL
- 13. THIS PROJECT SHALL BE MANAGED TO MEET THE REQUIREMENTS AND INTENT OF RSA 430:63 AND AGR 3800 RELATIVE TO INVASIVE SPECIES: AND FUGITIVE DUST IS CONTROLLED IN ACCORDANCE WITH ENV-A 1000.
- THERE SHALL BE NO PLASTIC, OR MULTI-FILAMENT OR MONOFILAMENT POLYPROPYLENE NETTING OR MESH WITH AN OPENING SIZE OF GREATER THAN 1/8 INCHES MATERIAL UTILIZED (NOT APPLICABLE TO TURF

THE FOLLOWING PROVIDES AN ITEMIZATION OF SPECIFIC SITE MAINTENANCE PRACTICES THAT WILL BE EMPLOYED ON THE SITE TO MINIMIZE POLLUTANT GENERATION AND TRANSPORT FROM THE SITE. THE SITE MAINTENANCE "PROGRAM INCLUDES ROUTINE INSPECTIONS, PREVENTATIVE MAINTENANCE AND "GOOD HOUSEKEEPING

SITE MAINTENANCE/INSPECTION PROGRAM

ROUTINE INSPECTIONS

THE CONTRACTOR SHALL INSPECT ALL CONTROL MEASURES AT LEAST ONCE A WEEK AND WITHIN TWENTY FOUR (24) HOURS OF THE END OF A STORM WITH RAINFALL AMOUNT GREATER THAN 0.25 INCHES. THE INSPECTIONS WILL VERIFY THAT THE STRUCTURAL BMPs DESCRIBED IN THE PLANS ARE IN GOOD CONDITION AND ARE MINIMIZING FROSION A MAINTENANCE INSPECTION REPORT WILL BE MADE WITH EACH INSPECTION COMPLETED INSPECTION FORMS SHALL BE KEPT ON-SITE FOR THE DURATION OF THE PROJECT. FOLLOWING CONSTRUCTION, THE COMPLETED FORMS SHALL BE RETAINED AT THE CONTRACTOR'S OFFICE FOR A MINIMUM OF ONE YEAR.

<u>PREVENTATIVE MAINTENANCE</u>

- THE CONTRACTOR SHALL BE RESPONSIBLE FOR MAINTENANCE OF ALL TEMPORARY AND PERMANENT CONTROLS THROUGHOUT THE DURATION OF THIS CONTRACT. MAINTENANCE PRACTICES SHALL INCLUDE, BUT ARE NOT LIMITED TO:
- CLEANING OF CATCH BASINS TWICE PER YEAR OR MORE FREQUENTLY AS DICTATED BY QUARTERLY
- CLEANING OF SEDIMENT AND DEBRIS FROM STORMWATER MANAGEMENT AREAS TWICE PER YEAR OR MORE FREQUENTLY AS DICTATED BY MONTHLY INSPECTIONS.
- IMPLEMENTATION OF OTHER MAINTENANCE OR REPAIR ACTIVITIES AS DEEMED NECESSARY BASED UPON
- REMOVAL OF BUILT UP SEDIMENT ALONG SILT SOCKS AND/OR STONE CHECK DAMS.
- REMOVAL OF BUILT UP SEDIMENT IN BOTH TEMPORARY AND PERMANENT CONTROLS SUCH AS GRASS SWALES, SEDIMENT FOREBAYS AND RECHARGE/DETENTION BASINS.
- RECONSTRUCTING THE TEMPORARY GRAVEL CONSTRUCTION EXIT IF NOT WORKING PROPERLY.
- TREATMENT OF NON-STORM WATER DISCHARGES SLICH AS WATER FROM WATER LINE FLUSHINGS OR GROUNDWATER FROM DEWATERING EXCAVATIONS. SUCH FLOWS SHOULD BE DIRECTED TO A TEMPORARY SEDIMENTATION BASIN OR STORMWATER MANAGEMENT AREA.
- SWEEP PARKING LOTS AND DRIVES REGULARLY TO MINIMIZE SEDIMENT ACCUMULATION, FREQUENCY WILL VARY SEASONALLY ACCORDING TO SEDIMENT ACCUMULATION ON PAVE SURFACES (E.G., MORE FREQUENT

SWEEPING DURING THE WINTER AND SPRING). GOOD HOUSEKEEPING PRACTICES

- THE CONTRACTOR SHALL EMPLOY MEASURES AND PRACTICES TO REDUCE THE RISK OF SPILLS OR OTHER ACCIDENTAL EXPOSURE OF MATERIALS TO STORM AND WATER RUNOFF. THE CONTRACTOR SHALL PAY SPECIAL ATTENTION TO THE HANDLING, USE AND DISPOSAL OF MATERIALS SUCH AS PETROLEUM PRODUCTS, FERTILIZERS AND PAINTS TO ENSURE THAT THE RISK ASSOCIATED WITH THE USE OF THESE PRODUCTS IS MINIMIZED. THE FOLLOWING "GOOD HOUSEKEEPING" PRACTICES SHALL BE FOLLOWED DURING
- CONSTRUCTION OF THE PROJECT: A. AN EFFORT SHALL BE MADE TO STORE ONLY ENOUGH PRODUCT REQUIRED TO DO THE JOB.
- B. ALL MATERIALS STORED ON-SITE SHALL BE STORED IN A NEAT, ORDERLY MANNER IN THEIR APPROPRIATE CONTAINERS AND, IF POSSIBLE, UNDER A ROOF OR OTHER ENCLOSURE.
- C. PRODUCTS SHALL BE KEPT IN THEIR ORIGINAL CONTAINERS WITH THEIR MANUFACTURERS' LABELS. D. WHENEVER POSSIBLE, ALL OF A PRODUCT SHALL BE USED BEFORE DISPOSING OF THE CONTAINER.
- E. MANUFACTURERS' RECOMMENDATIONS FOR PROPER USE AND DISPOSAL SHALL BE FOLLOWED. F. THE CONTRACTOR SHALL INSPECT DAILY TO ENSURE PROPER USE AND DISPOSAL OF MATERIALS.

SPILL PREVENTION AND CLEANUP PRACTICES

- MANUFACTURERS' RECOMMENDED METHODS FOR SPILL CLEANUP WILL BE CLEARLY POSTED AND SITE PERSONNEL WILL BE MADE AWARE OF THE PROCEDURES AND THE LOCATION OF THE INFORMATION AND CLEANUP SUPPLIES.
- MATERIALS AND EQUIPMENT NECESSARY FOR SPILL CLEANUP WILL BE KEPT IN THE MATERIAL STORAGE AREA ON-SITE FOUIPMENT AND MATERIAL WILL INCLUDE BUT NOT BE LIMITED TO BROOMS DUSTPANS MOPS, RAGS, GLOVES, GOGGLES, KITTY LITTER, SAND, SAWDUST, AND PLASTIC AND METAL TRASH
- CONTAINERS SPECIFICALLY FOR THIS PURPOSE ALL SPILLS WILL BE CLEANED UP IMMEDIATELY AFTER DISCOVERY.
- THE SPILL AREA WILL BE KEPT WELL VENTILATED AND PERSONNEL WILL WEAR APPROPRIATE PROTECTIVE
- CLOTHING TO PREVENT INJURY FROM CONTACT WITH A HAZARDOUS SUBSTANCE. SPILLS OF TOXIC OR HAZARDOUS MATERIAL WILL BE REPORTED TO THE APPROPRIATE STATE OR LOCAL GOVERNMENT AGENCY, REGARDLESS OF THE SIZE
- THE SPILL PREVENTION PLAN WILL BE ADJUSTED TO INCLUDE MEASURES TO PREVENT THIS TYPE OF SPILL FROM REOCCURRING AND HOW TO CLEAN UP THE SPILL IF THERE IS ANOTHER ONE. A DESCRIPTION OF THE SPILL, WHAT CAUSED IT, AND THE CLEANUP MEASURES WILL ALSO BE INCLUDED.

WINTER CONDITION NOTES

- ALL PROPOSED POST-DEVELOPMENT VEGETATED AREAS WHICH DO NOT EXHIBIT A MINIMUM OF 85% VEGETATIVE GROWTH BY OCTOBER 15TH, OR WHICH ARE DISTURBED AFTER OCTOBER 15TH, SHALL BE STABILIZED BY SEEDING AND INSTALLING EROSION CONTROL BLANKETS ON SLOPES GREATER THAN 3:1. AND SEEDING AND PLACING 3 TO 4 TONS OF MULCH PER ACRE. SECURED WITH ANCHORED NETTING, ELSEWHERE. THE PLACEMENT OF EROSION CONTROL BLANKETS OR MULCH AND NETTING SHALL NOT OCCUR OVER ACCUMULATED SNOW OR ON FROZEN GROUND AND SHALL BE COMPLETED IN ADVANCE OF THAW OR SPRING MELT EVENTS.
- ALL DITCHES OR SWALES WHICH DO NOT EXHIBIT A MINIMUM OF 85% VEGETATIVE GROWTH BY OCTOBER 15 $^{ ext{TH}}$ OR WHICH ARE DISTURBED AFTER OCTOBER 15 $^{ ext{TH}}$ SHALL BE STABILIZED WITH STONE OR EROSION CONTROL BLANKETS APPROPRIATE FOR THE DESIGN FLOW CONDITIONS.
- AFTER OCTOBER 15TH, INCOMPLETE ROAD OR PARKING SURFACES SHALL BE PROTECTED WITH A MINIMUM OF 3-INCHES OF CRUSHED GRAVEL PER NHDOT ITEM 304.3

9	3/14/25	MINOR SITE REVISIONS FOR ADMINISTRATIVE APPROVAL	TEZ
8	9/11/24	ADDRESS STAFF COMMENTS, ADD CIPP LINING SCOPE & REVISE EASEMENTS	TEZ
7	4/16/24	ADDRESS STAFF & NHDES COMMENTS	TEZ
6	1/31/24	ADDRESS STAFF COMMENTS	TEZ
1-5	-	SEE PREVIOUS PLAN REVISIONS ON FILE	TEZ
o Z	DATE	REVISION	BY

DETAIL SHEET - EROSION CONTROL 7, 9, II & I3 STICKNEY AVENUE



670 N. COMMERCIAL STREET, SUITE 303 MANCHESTER, NEW HAMPSHIRE RECORD OWNER:

SCALE AS SHOWN

20 JULY 2022




3 Congress Street Nashua, NH 03062 (603) 883-2057


131 Middlesex Turnpike Burlington, MA 01803 (781) 203-1501


www.hayner-swanson.com TELD BOOK: 1262 DRAWING NAME: 5800-SITE DET1


16 OF 24 PRAWING LOC: J: \5000\5800\DWG\5800 SITE

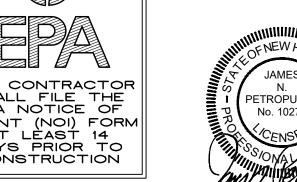


THE CONTRACTOR SHALL FILE THE EPA NOTICE OF INTENT (NOI) FORM
AT LEAST 14
DAYS PRIOR TO
CONSTRUCTION

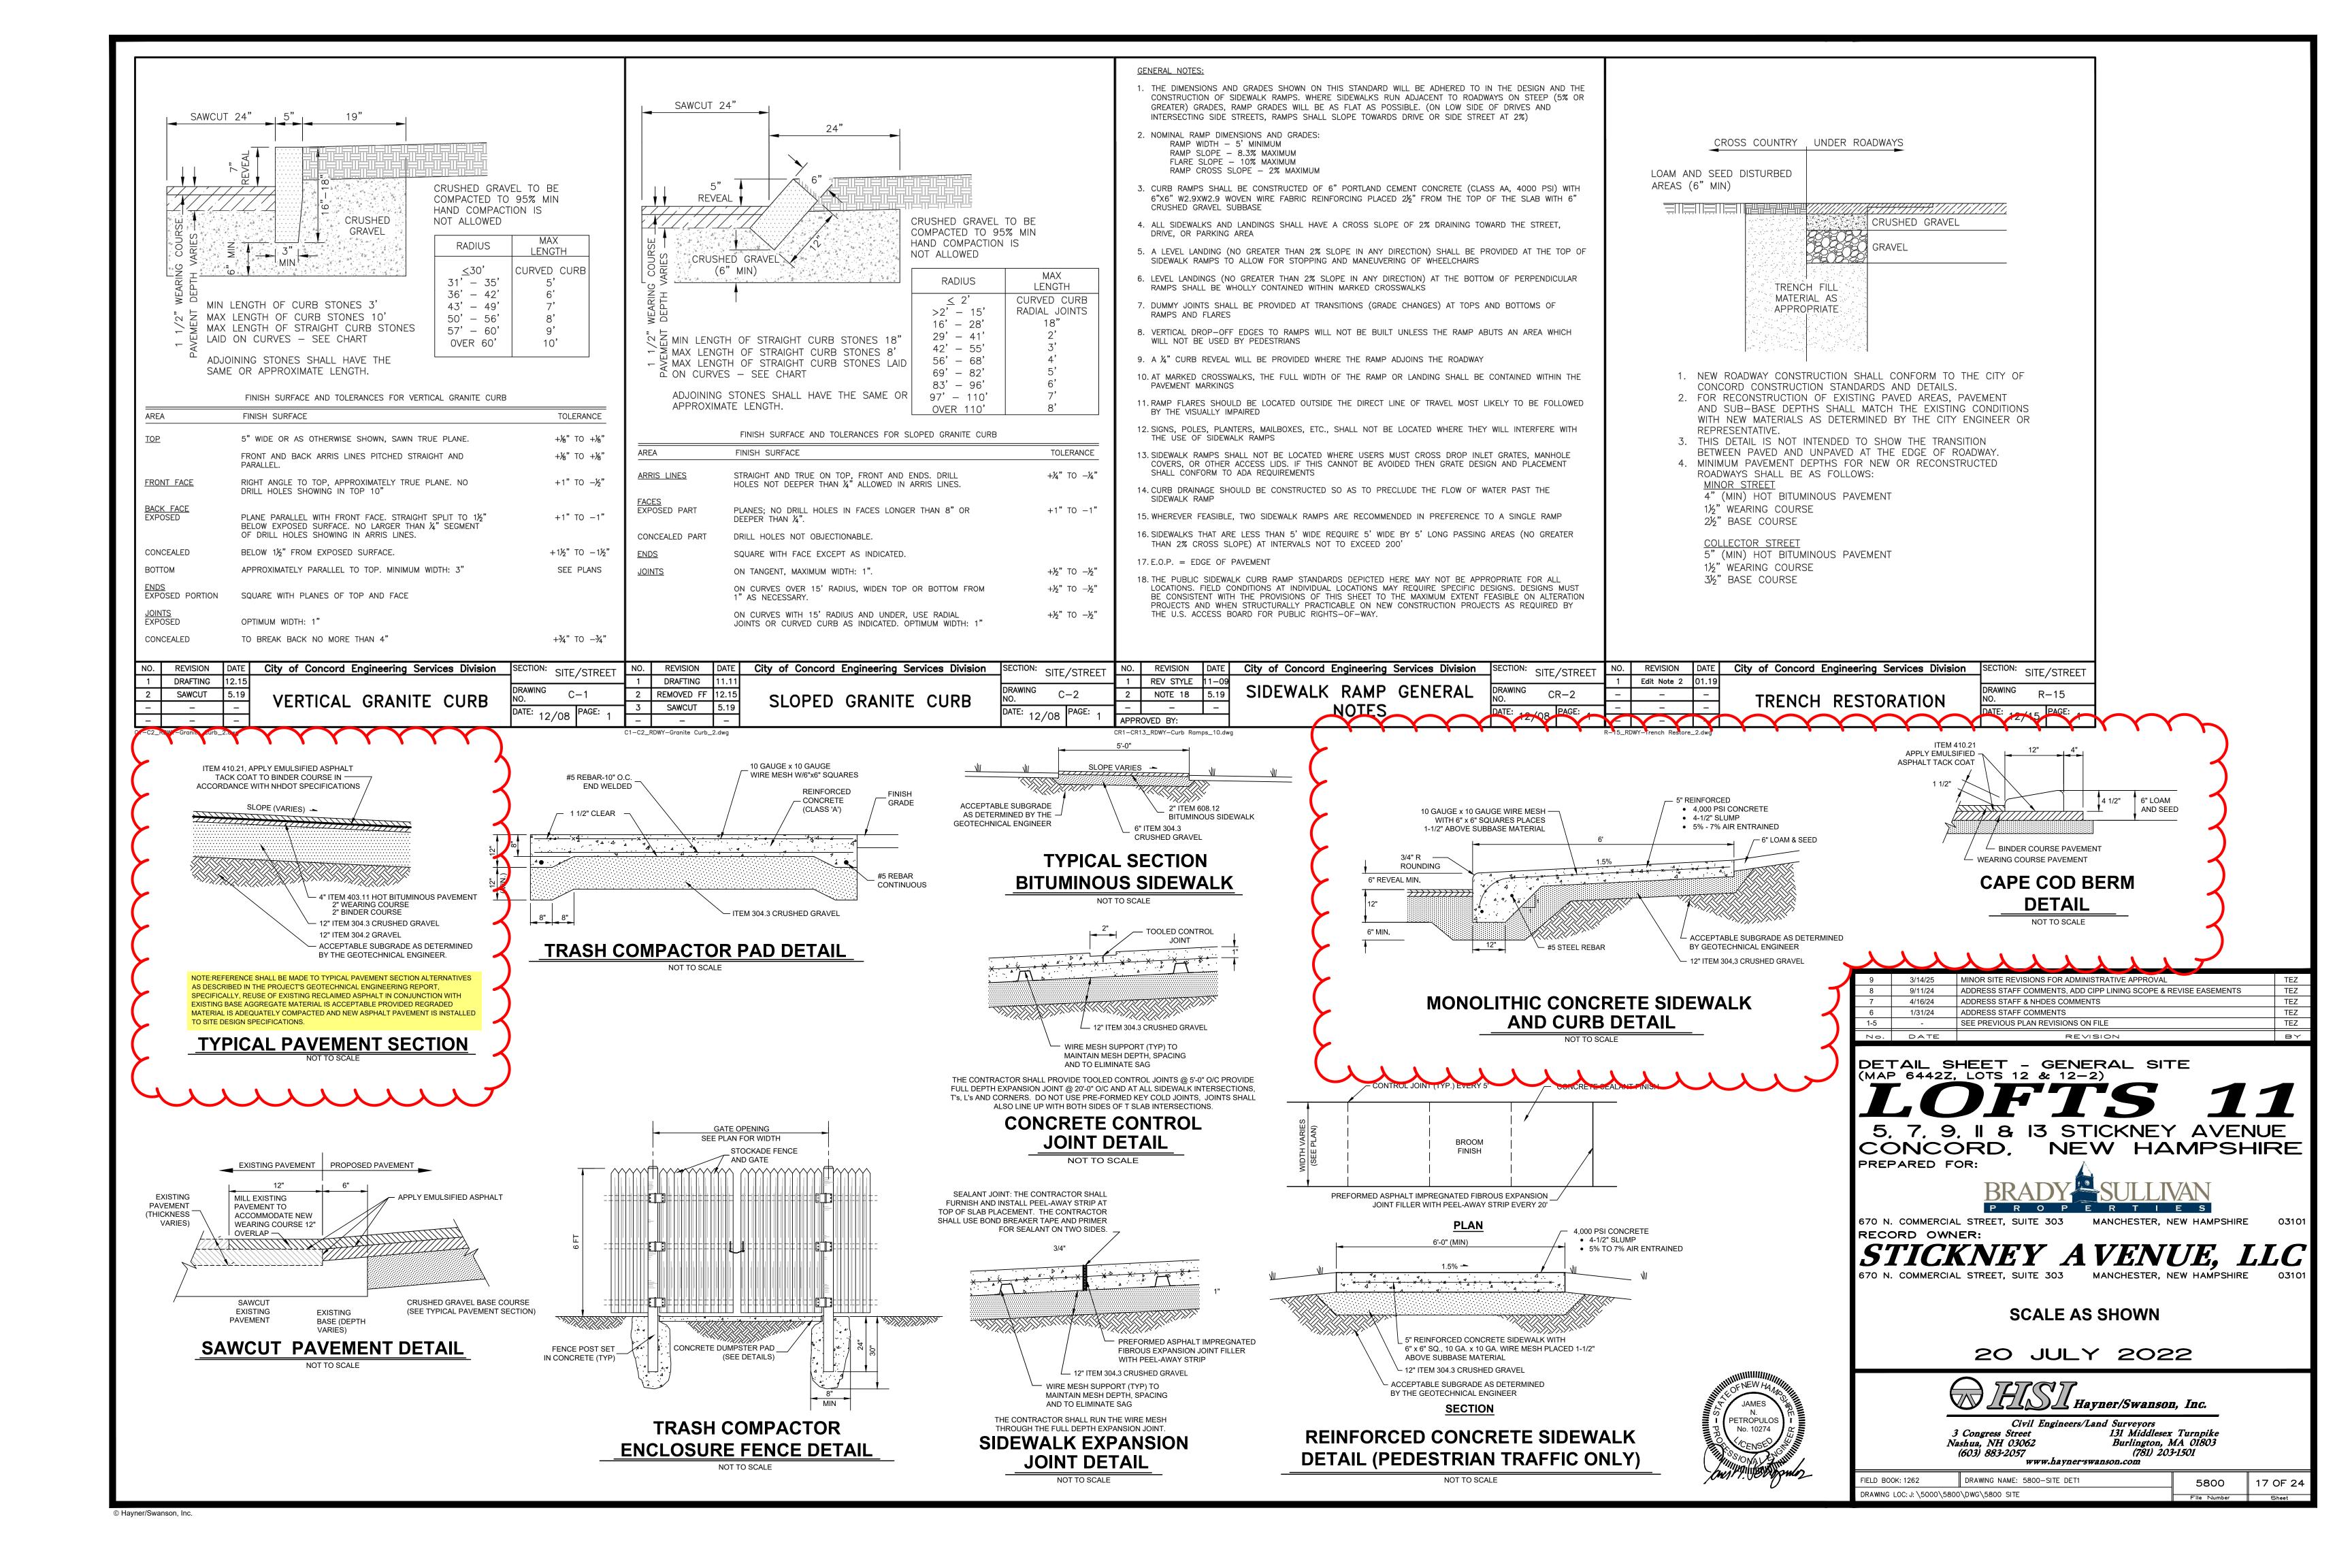

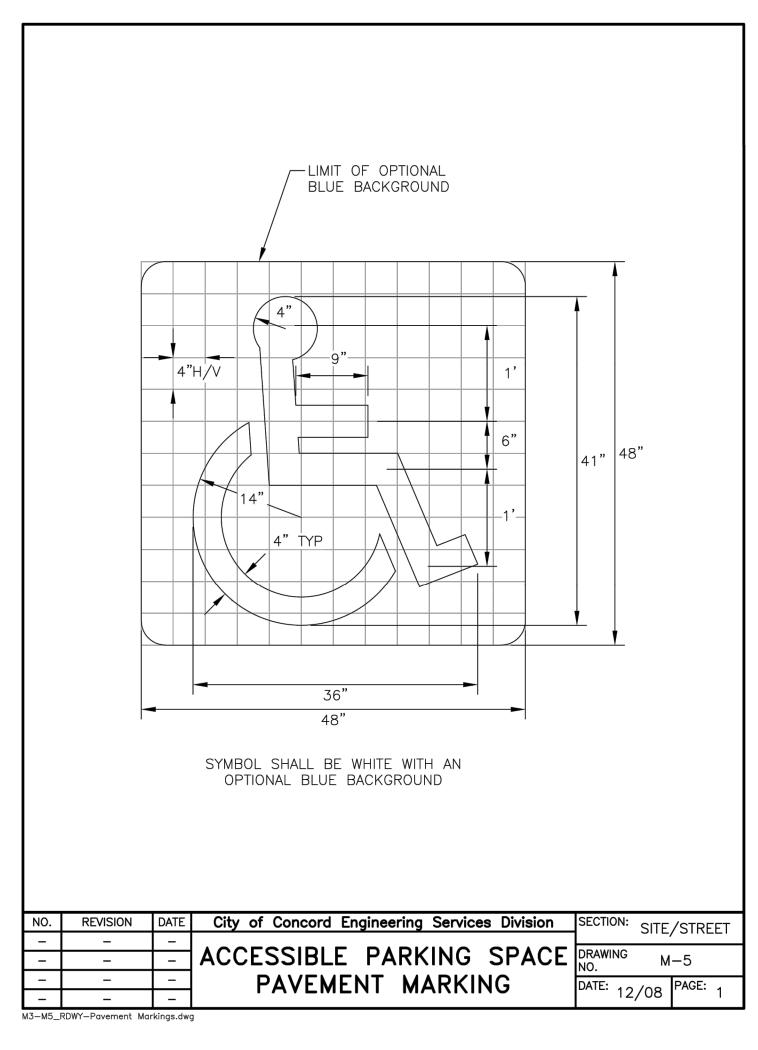


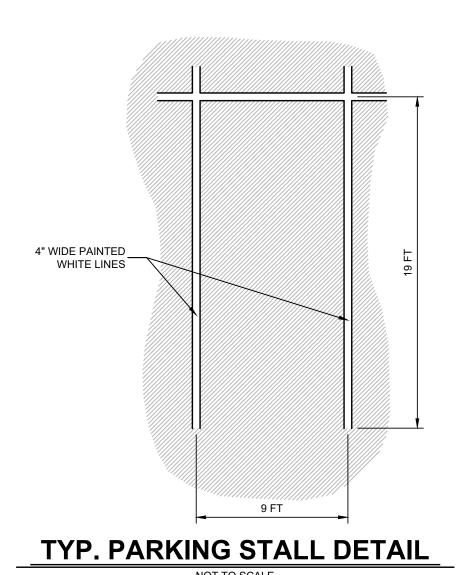


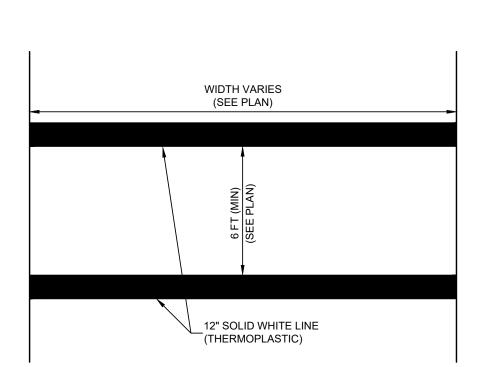

TYPICAL CROSSWALK DETAIL


R7-8 & R7-8P ACCESSIBLE

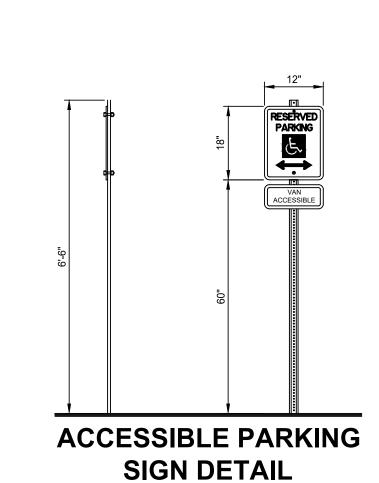

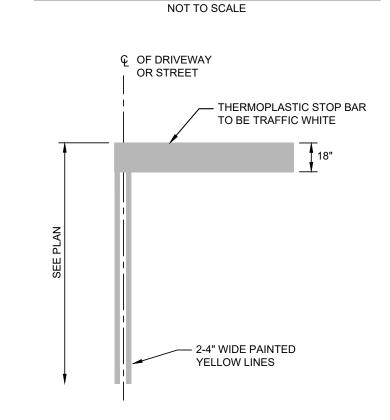


STOP BAR DETAIL NOT TO SCALE

TIP DOWN CURB & -SIDEWALK RAMP

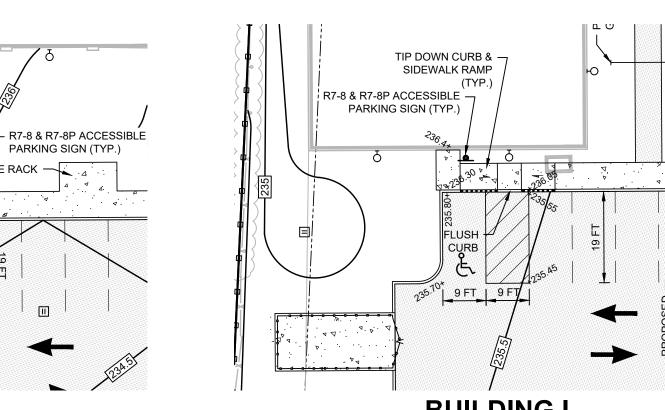



BUILDING I ACCESSIBLE PARKING AREA

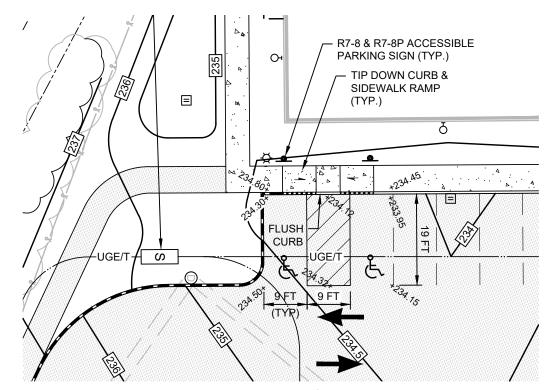

BUILDING A ACCESSIBLE PARKING AREA

ACCESSIBLE PARKING AREA

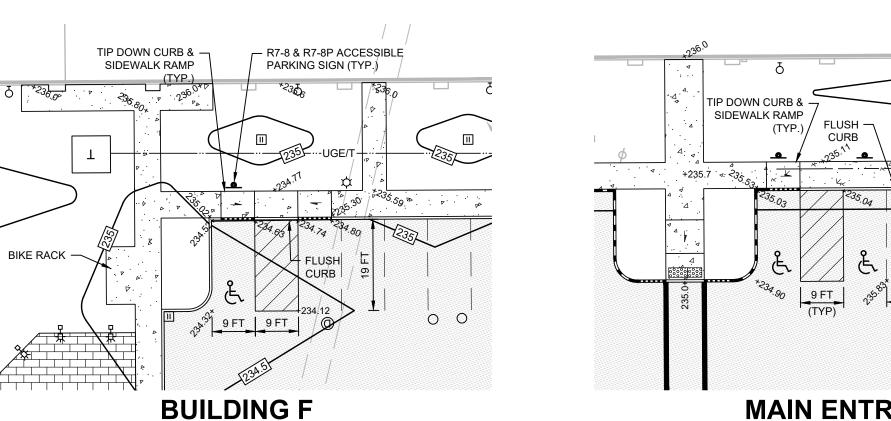

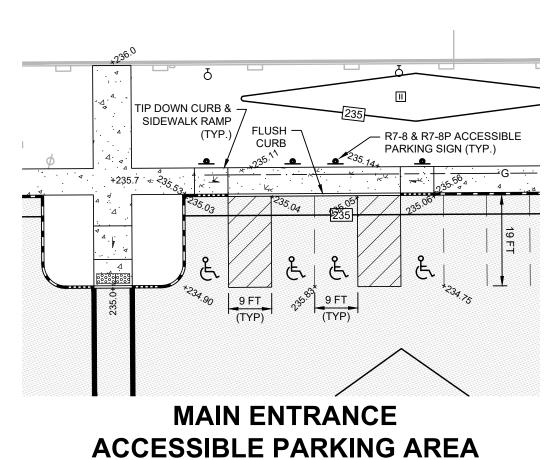


9 FT 9 FT

BUILDING D


ACCESSIBLE PARKING AREA

SIDEWALK RAMP

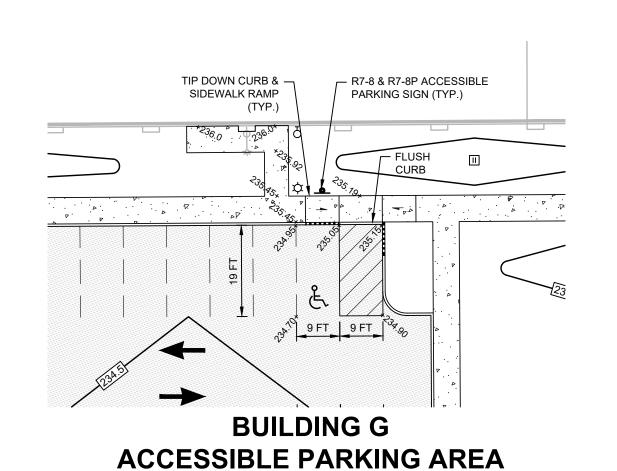

BUILDING H

ACCESSIBLE PARKING AREA

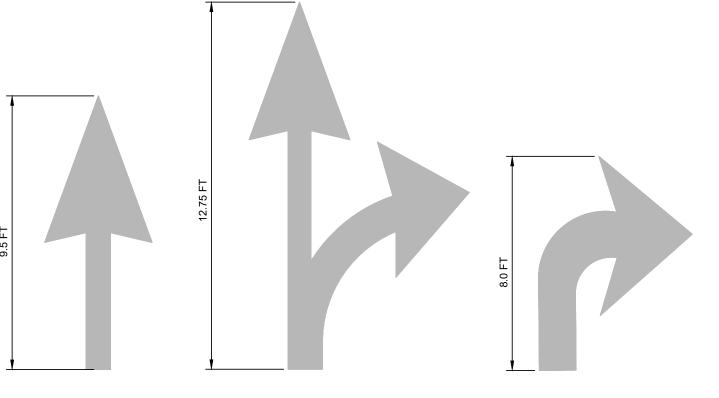

- 1. ALL FLOW ARROWS TO BE SOLID WHITE REFLECTIVE THERMOPLASTIC AS PER DIMENSIONS SHOWN.
- 2. REVERSE ARROWS FOR OPPOSITE DIRECTIONS OF FLOW.

PAINTED TRAFFIC ARROWS DETAIL

5-Loop Wave Style Bike Rack - 7 Bike Capacity, Black




More images


- Upscale stylish look for downtown shopping and business districts. For stadiums, parks and athletic fields.
- 10-gauge steel with attractive powder coating.
- 2 3/8" diameter bar. · Bike rack mounting hardware included.


ULINE MODEL H-2544BL, 2-SIDED, 7-BIKE RACK CAPACITY (OR APPROVED EQUAL)


							SPECIFY COL	OR:	
MODEL NO.	DESCRIPTION	SIZE	BIKE CAP.	WT.	PRICE EACH		00100	IN STOCK	
		LxWxH		(LBS.)	1	3+	COLOR	SHIPS TODAY	
l-2544BL	5-Loop	68 x 2 ¹ / ₂ x 39"	7	80	\$450	\$430	■ Black -	1 ADD	

BICYCLE RACK DETAIL

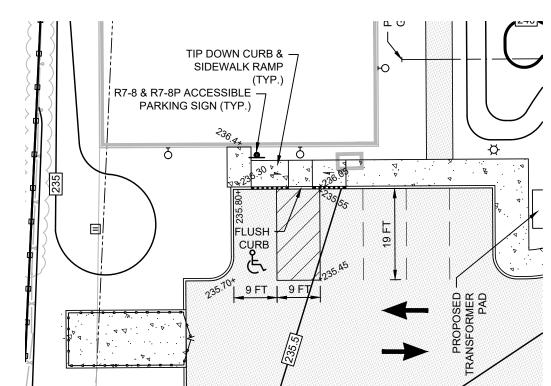

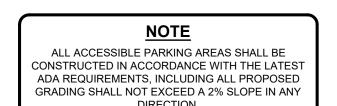

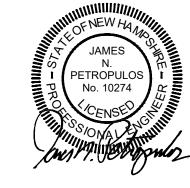

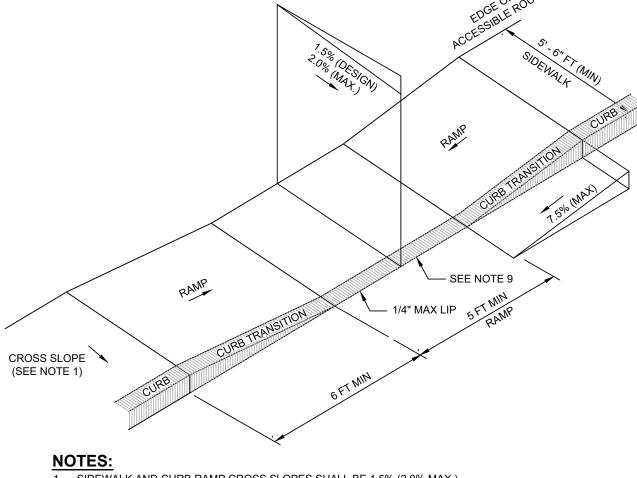


- 1. SIDEWALK AND CURB RAMP CROSS SLOPES SHALL BE 1.5% (2.0% MAX.).
- 2. THE MAXIMUM ALLOWABLE LONGITUDINAL SLOPE OF ACCESSIBLE ROUTE EXCLUDING CURB RAMPS
- 3. THE MAXIMUM ALLOWABLE LONGITUDINAL SLOPE OF ACCESSIBLE ROUTE CURB RAMPS SHALL BE 7.5%.
- 4. A MINIMUM OF 3 FEET CLEAR SHALL BE MAINTAINED AT ANY PERMANENT OBSTACLE IN ACCESSIBLE ROUTE (I.E., HYDRANTS, UTILITY POLES, TREE WELLS, SIGNS, ETC.)
- 5. CURB TREATMENT VARIES, SEE PLANS FOR CURB TYPE.
- 6. BASE OF RAMP SHALL BE GRADED TO PREVENT PONDING.
- 7. SEE TYPICAL SIDEWALK SECTION FOR RAMP CONSTRUCTION.
- 8. WHERE ACCESSIBLE ROUTES ARE LESS THAN 5 FT IN WIDTH (EXCLUDING CURB) A 5 FT x 5 FT PASSING AREA SHALL BE PROVIDED AT INTERVALS NOT TO EXCEED 200 FEET.
- 9. ELIMINATE ALL CURBING AT RAMP (OTHER THAN VERTICAL CURBING, WHICH SHALL BE SET FLUSH)

HANDICAP ACCESSIBLE

CURB RAMP DETAIL

9	3/14/25	MINOR SITE REVISIONS FOR ADMINISTRATIVE APPROVAL	TEZ
8	9/11/24	ADDRESS STAFF COMMENTS, ADD CIPP LINING SCOPE & REVISE EASEMENTS	TEZ
7	4/16/24	ADDRESS STAFF & NHDES COMMENTS	TEZ
6	1/31/24	ADDRESS STAFF COMMENTS	TEZ
1-5	-	SEE PREVIOUS PLAN REVISIONS ON FILE	TEZ
NO	DATE	REVISION	BY

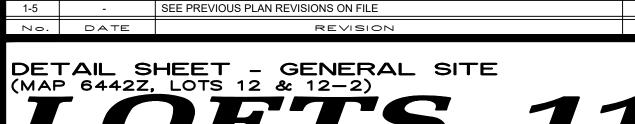

& 13 STICKNEY AVENUE CONCORD, NEW HAMPSHIRE



670 N. COMMERCIAL STREET, SUITE 303 MANCHESTER, NEW HAMPSHIRE RECORD OWNER:

SCALE AS SHOWN

20 JULY 2022





131 Middlesex Turnpike Burlington, MA 01803 (781) 203-1501 3 Congress Street Nashua, NH 03062 (603) 883-2057 www.hayner-swanson.com


DRAWING NAME: 5800-SITE DET1 FIELD BOOK: 1262 DRAWING LOC: J: \5000\5800\DWG\5800 SITE


18 OF 24

© Hayner/Swanson, Inc.

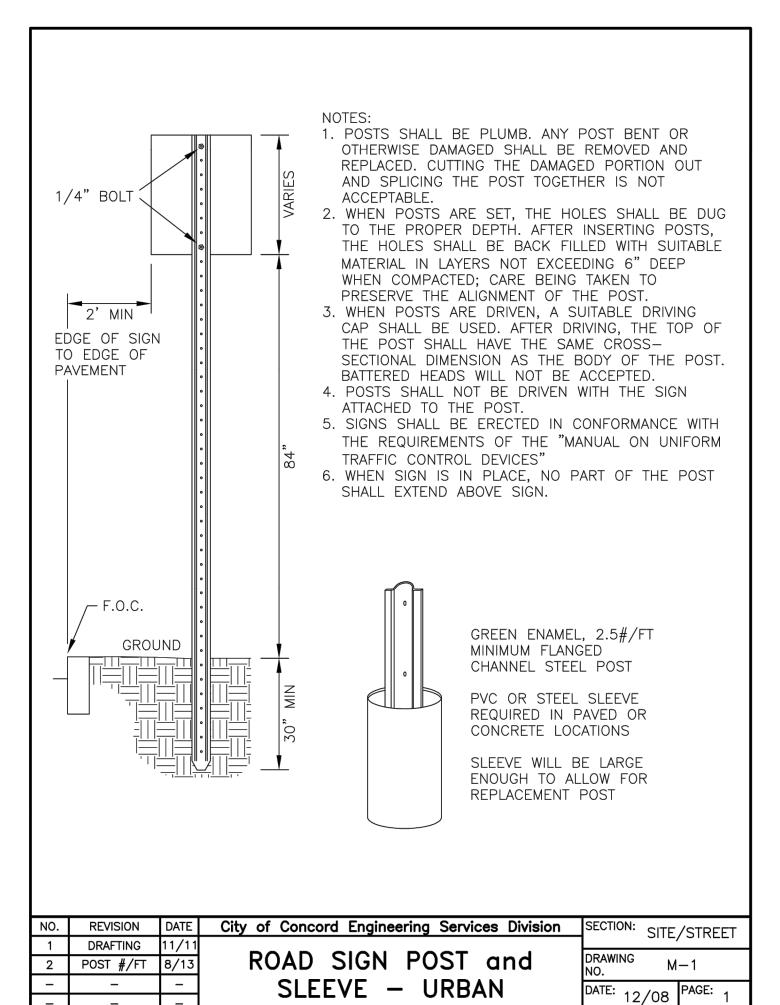


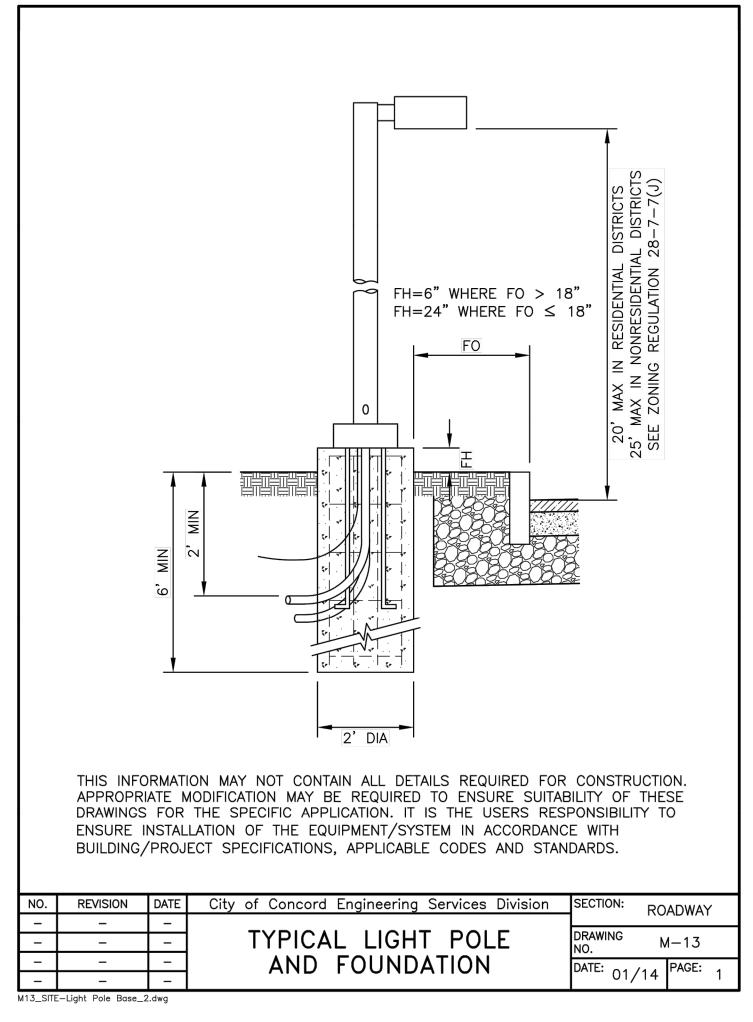

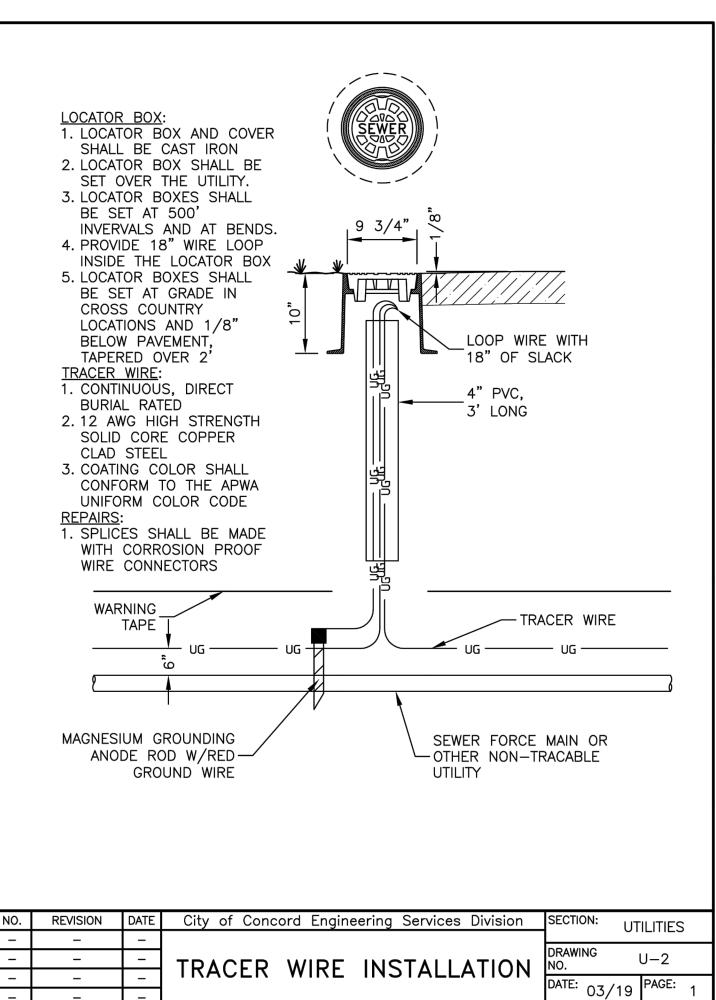


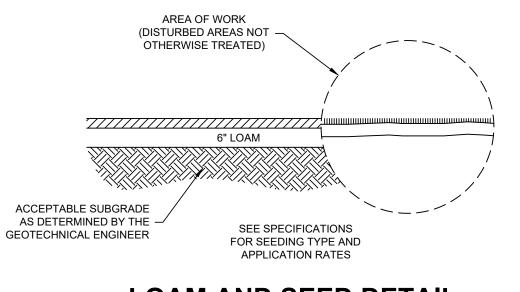


LOAM AND SEED DETAIL

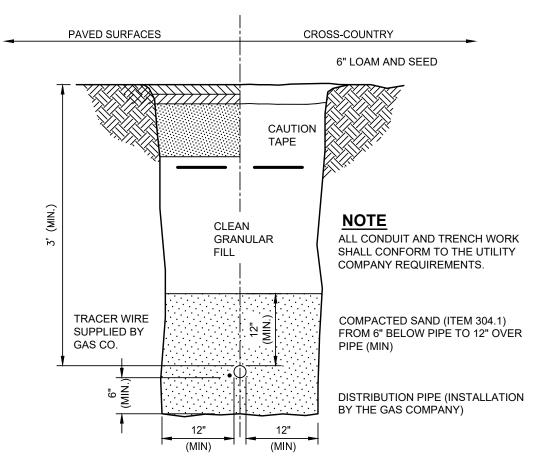



GAS MAIN TRENCH SECTION

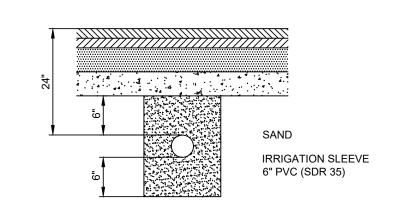

IRRIGATION SLEEVE DETAIL

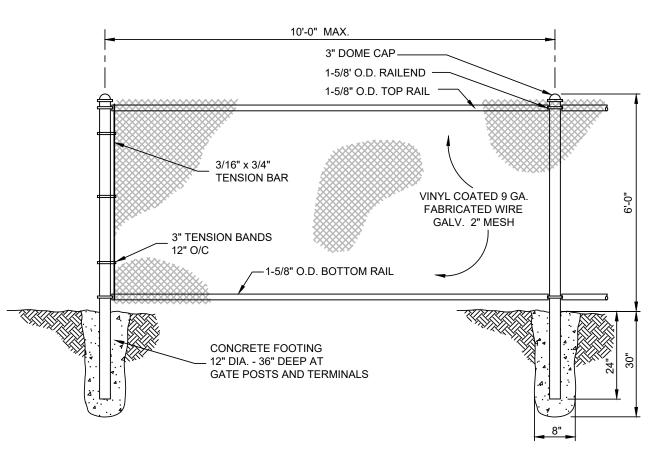


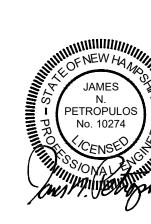

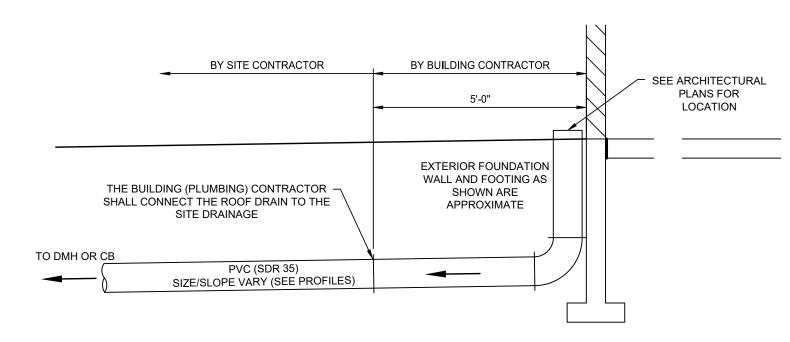

ROOF DRAIN DOWNSPOUT (DS) CONNECTION DETAIL

NOT TO SCALE

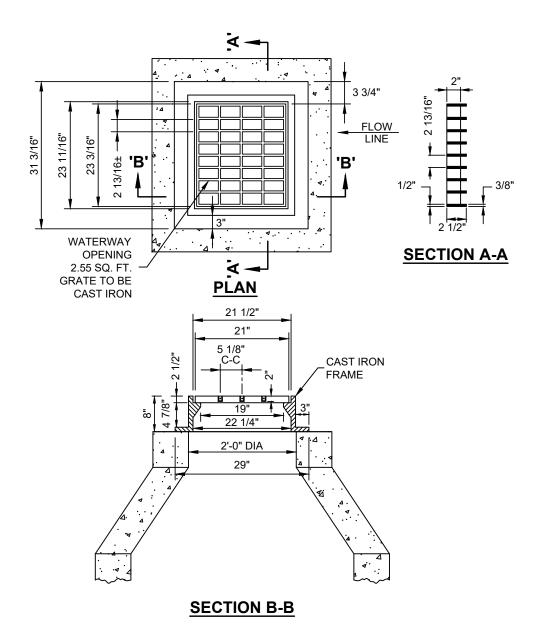

CATCH BASIN - TYPE B FRAME AND COVER DETAIL NOT TO SCALE

9	3/14/25	MINOR SITE REVISIONS FOR ADMINISTRATIVE APPROVAL	TEZ
8	9/11/24	ADDRESS STAFF COMMENTS, ADD CIPP LINING SCOPE & REVISE EASEMENTS	TEZ
7	4/16/24	ADDRESS STAFF & NHDES COMMENTS	TEZ
6	1/31/24	ADDRESS STAFF COMMENTS	TEZ
1-5	-	SEE PREVIOUS PLAN REVISIONS ON FILE	TEZ
0 ·	DATE	REVISION	BY
		HEET - GENERAL SITE LOTS 12 & 12-2)	

5, 7, 9, II & I3 STICKNEY AVENUE CONCORD. NEW HAMPSHIRE

PREPARED FOR: 670 N. COMMERCIAL STREET, SUITE 303 MANCHESTER, NEW HAMPSHIRE

RECORD OWNER: STICKNEY AVENUE, LLC

SCALE AS SHOWN

20 JULY 2022



19 OF 24

5800

131 Middlesex Turnpike Burlington, MA 01803 3 Congress Street Nashua, NH 03062 (781) 203-1501 (603) 883-2057 www.hayner-swanson.com

DRAWING NAME: 5800-SITE DET1 FIELD BOOK: 1262 DRAWING LOC: J: \5000\5800\DWG\5800 SITE

CHAINLINK FENCE DETAIL NOT TO SCALE

TYPICAL UTILITY CONDUIT U-1**INSTALLATION** _

UNDERGROUND CONDUIT INSTALLATIONS SHALL BE COORDINATED WITH ALL

LOCAL UTILITIES INCLUDING ELECTRIC, TELEPHONE, GAS, CABLE, STEAM, AND

CONDUIT CROSSINGS SHALL BE SWEEPS AT RIGHT ANGLES TO THE STREET.

PROPOSED CONDUITS WITHIN PAVED SECTIONS OF STREETS SHALL BE RIGID

METAL OR SCH 80 PVC CONDUIT. WHEN THE PROPER DEPTH CANNOT BE

ACHIEVED, SCH 40 PVC CONDUIT ENCASED IN CONCRETE SHALL BE USED.

CITY OF CONCORD FIRE ALARM/SIGNAL AND ENGINEERING SERVICES DIVISIONS.

NO. | REVISION | DATE | City of Concord Engineering Services Division | SECTION: SITE/STREET DATE: 03/15 PAGE:

- | -M1-M2_RDWY-Sign Post.dwg

CROSS COUNTRY |

LOAM AND SEED

DISTURBED AREAS

90° BENDS ARE NOT ACCEPTABLE

(MINIMUM 6")

COMMON FILL

WARNING

TAPE (TYP)

MATERIAL

NEW ROADWAY CONSTRUCTION SHALL

CONFORM TO THE CITY OF CONCORD

SHALL EQUAL THE EXISTING MATERIAL

DEPTHS

CONSTRUCTION STANDARDS AND DETAILS

FOR RECONSTRUCTION OF EXISTING PAVED


AREAS, PAVEMENT AND SUB-BASE DEPTHS


CRUSHED GRAVEL

CONCRETE ENCASED

UTILITY CONDUIT BANK

GRAVEL

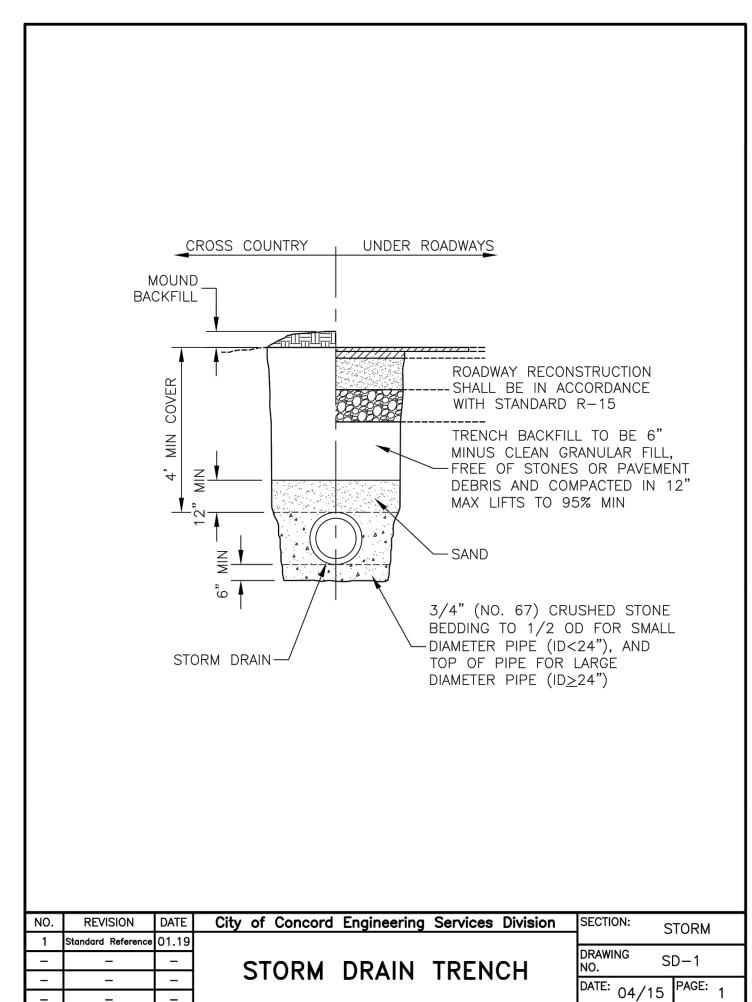


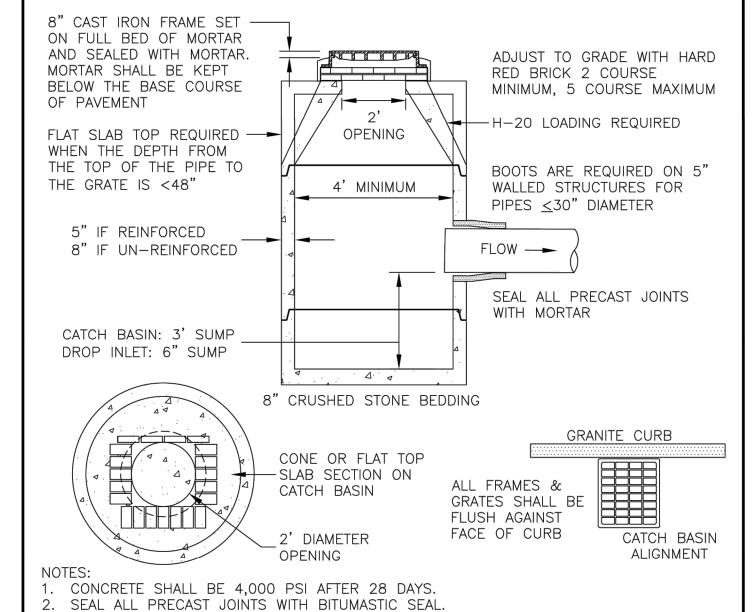

- 3. LIFT HOLES AND BOOT RECESSES ARE TO BE SEALED WITH MORTAR FLUSH TO THE
- OUTSIDE STRUCTURE WALL PRIOR TO BACKFILLING. 4. MINIMUM DEPTH FROM RIM TO INVERT OF THE HIGHEST PIPE SHALL BE:
- $12"\phi=3.7'$, $15"\phi=3.9'$, $18"\phi=4.2'$, $24"\phi=4.8'$, $30"\phi=5.3'$, $36"\phi=5.8'$ 5. ALL STRUCTURES WITH MULTIPLE PIPES SHALL HAVE A MINIMUM OF 12" OF INSIDE SURFACE BETWEEN HOLES. NO MORE THAN 75% OF A HORIZONTAL CROSS-SECTION
- SHALL BE HOLES AND THERE SHALL BE NO HOLES CLOSER THAN 3" TO JOINTS. MANHOLES AND TRAFFIC SIGNAL LOOPS SHALL BE SEPARATED BY A MINIMUM OF 2' TO ALLOW FOR MAINTENANCE OF STRUCTURE.
- THREE FLANGED FRAMES SHALL BE USED FOR INSTALLATIONS ADJACENT TO VERTICAL GRANITE CURB.
- 8. NHDOT TYPE "F" GRATE REQUIRED FOR ROADWAYS HAVING SLOPES EQUAL TO OR GREATER THAN 3%. TYPE "F" SHALL BE BICYCLE SAFE.
- 9. BRICK WORK SHALL BE RECTANGULAR AND CONFORM TO THE DIMENSIONS OF THE GRATE BEING USED. TYPE "B" GRATES SHALL BE ALIGNED WITH THE 22" DIMENSION AGAINST THE CURB.


NO.	REVISION	DATE	City of Concord Engineering Services Division	SECTION: STOP	RM DRAIN
1	DRAFTING	11/11			2.0
2	SUMP DIM.	3/19	CATCH BASIN / DROP INLET	DRAWING S	D-6
_	_	_	CATCH DASIN / DIOI INLLT	DATE:	PAGE: 4
_	_			12/08	1

SD6_STRM-CB_DI_3.dwg

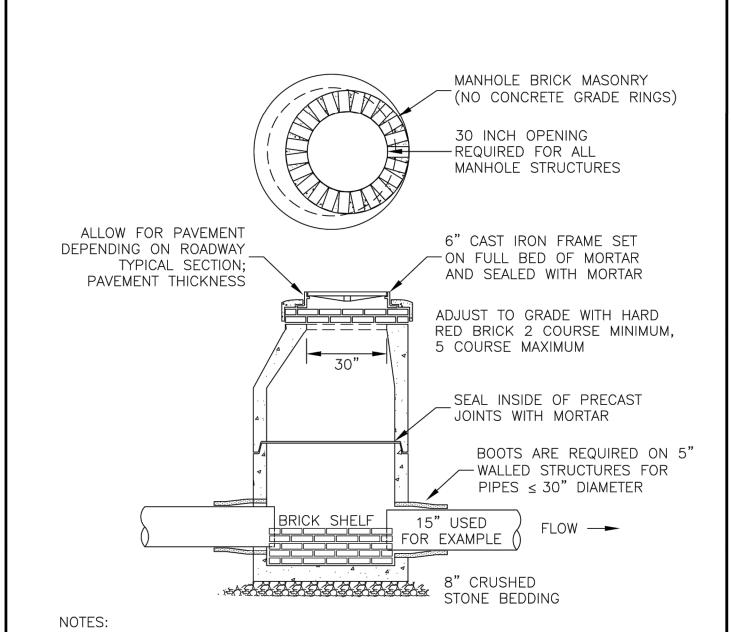

- 1. CONCRETE: 4,000 PSI AFTER 28 DAYS 2. H-20 LOADING REQUIRED
- 3. 5" MINIMUM WALL THICKNESS IF REINFORCED, 8" IF UN-REINFORCED
- 4. SEAL ALL PRECAST JOINTS WITH BITUMASTIC SEAL 5. LIFT HOLES AND BOOT RECESSES ARE TO BE SEALED WITH MORTAR FLUSH TO
- THE OUTSIDE STRUCTURE WALL PRIOR TO BACKFILLING 6. ALL STRUCTURES WITH MULTIPLE PIPES SHALL HAVE A MINIMUM OF 12" OF INSIDE SURFACE BETWEEN HOLES. NO MORE THAN 75% OF A HORIZONTAL CROSS-SECTION SHALL BE HOLES, AND THERE SHALL BE NO HOLES CLOSER
- THAN 3" TO JOINTS 7. MANHOLES AND TRAFFIC SIGNAL LOOPS SHALL BE SEPARATED BY A MINIMUM OF 2' TO ALLOW FOR MAINTENANCE OF STRUCTURE


٥.	REVISION	DATE	City of Concord Engineering Services Division	SECTION: STORM DRAIN
	DRAFTING	11.11		
2	ADDED INLET	12.15	STORM DRAIN MANHOLE	DRAWING SD-2
	-	_	STORM DRAIN MANHOLE	DATE: IDAGE:
-	_	_		DATE: 12/08 PAGE: 1
STR	M-Manhole 3.dwa			

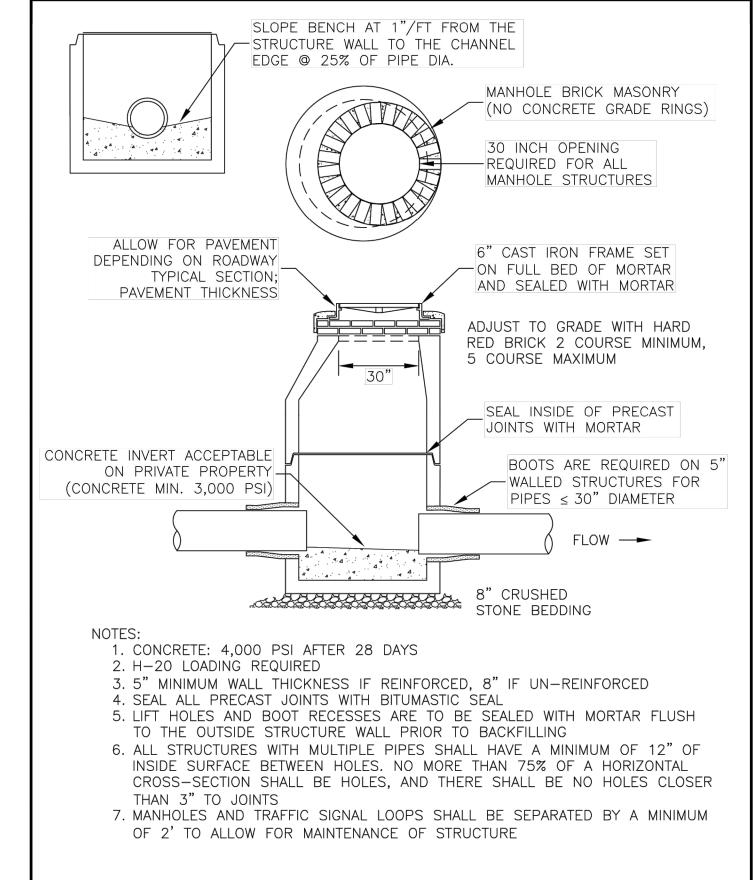


NO. | REVISION | DATE | City of Concord Engineering Services Division | SECTION: STORM DRAIN

STORM DRAIN MANHOLE

(PRIVATE)

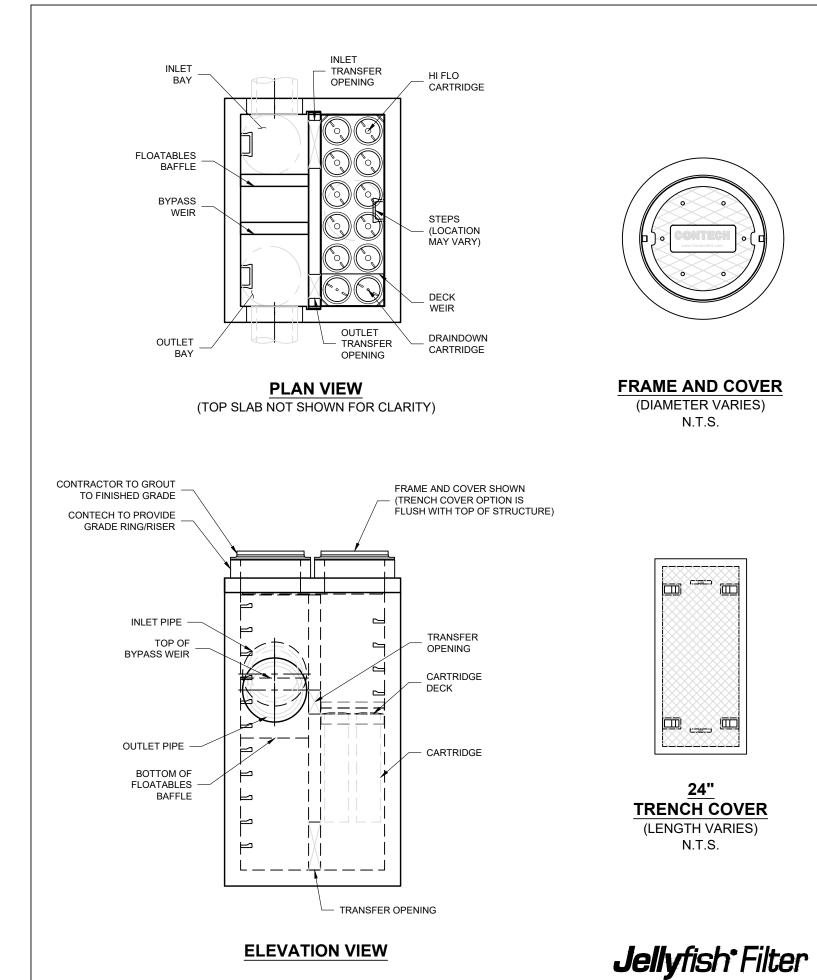

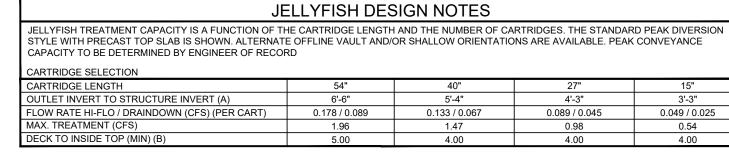

STRUCTURE	· ID				_	SMA A
		A/ DATE /	. .		╀	
WATER QUA			CIS)		╀	1.78
PEAK FLOW					₽	7.02
RETURN PER			.,		╙	25
# OF CARTR	IDGES RE	QUIRED ((HF / DD))		10
CARTRIDGE	LENGTH					54"
PIPE DATA:	I.E.	MAT'L	DIA	SLOPE	%	HGI
INLET #1	228.92	RCP	15"	0.9	ヿ	N/A
INLET #2	N/A	N/A	N/A	N/A	\neg	N/A
OUTLET	228.87	RCP	15"	2.1		N/A
SEE GENER HYDRAULIC RIM ELEVAT	AND SIZI				_	:T 235.0±
ANTI-FLOTA	TION BALI	LAST	WID.	TH	Н	EIGHT
			TBI	n		TBD

STRUCTURE	: ID					SMA B
WATER QUA	LITY FLO	W RATE (cfs)			1.25
PEAK FLOW	RATE (cfs	s)				6.07
RETURN PER	RIOD OF F	PEAK FLO	W (yrs)			25
# OF CARTR	IDGES RE	QUIRED ((HF / DD))		7
CARTRIDGE	LENGTH					54"
PIPE DATA:	I.E.	MAT'L	DIA	SLOPE	%	HGL
INLET #1	228.75	RCP	15"	1.0	70	N/A
INLET #2	N/A	N/A	N/A	N/A	\dashv	N/A
OUTLET	228.29	RCP	15"	1.0		N/A
SEE GENER HYDRAULIC					ΓLE	Т
RIM ELEVAT	ION					234.8±
ANTI-FLOTA	TION BALI	LAST	WID.	TH	Н	EIGHT
			TBI)		TBD

- ENERAL NOTES:

 CONTECH TO PROVIDE ALL MATERIALS UNLESS NOTED OTHERWISE. 2. FOR SITE SPECIFIC DRAWINGS WITH DETAILED STRUCTURE DIMENSIONS AND WEIGHT, PLEASE CONTACT YOUR CONTECH ENGINEERED SOLUTIONS REPRESENTATIVE. www.ContechES.com
- 3. JELLYFISH WATER QUALITY STRUCTURE SHALL BE IN ACCORDANCE WITH ALL DESIGN DATA AND INFORMATION CONTAINED IN THIS DRAWING. CONTRACTOR TO CONFIRM STRUCTURE MEETS REQUIREMENTS OF PROJECT. 4. STRUCTURE SHALL MEET AASHTO HS-20 OR PER APPROVING JURISDICTION REQUIREMENTS, WHICHEVER IS MORE STRINGENT, ASSUMING EARTH COVER OF 0' - 10'. AND GROUNDWATER ELEVATION AT, OR BELOW, THE OUTLET PIPE INVERT ELEVATION. ENGINEER OF RECORD TO CONFIRM ACTUAL GROUNDWATER ELEVATION. CASTINGS SHALL MEET AASHTO M306 LOAD RATING AND BE CAST WITH THE CONTECH LOGO. 5. STRUCTURE SHALL BE PRECAST CONCRETE CONFORMING TO ASTM C-857, ASTM C-918, AND AASHTO LOAD FACTOR DESIGN METHOD.
- 6. OUTLET PIPE INVERT IS EQUAL TO THE CARTRIDGE DECK ELEVATION. 7. THE OUTLET PIPE DIAMETER FOR NEW INSTALLATIONS IS RECOMMENDED TO BE ONE PIPE SIZE LARGER THAN THE INLET PIPE AT EQUAL OR
- 8. NO PRODUCT SUBSTITUTIONS SHALL BE ACCEPTED UNLESS SUBMITTED 10 DAYS PRIOR TO PROJECT BID DATE, OR AS DIRECTED BY THE


INSTALLATION NOTES
A. ANY SUB-BASE, BACKFILL DEPTH, AND/OR ANTI-FLOTATION PROVISIONS ARE SITE-SPECIFIC DESIGN CONSIDERATIONS AND SHALL BE SPECIFIED B. CONTRACTOR TO PROVIDE EQUIPMENT WITH SUFFICIENT LIFTING AND REACH CAPACITY TO LIFT AND SET THE STRUCTURE.

C. CONTRACTOR WILL INSTALL AND LEVEL THE STRUCTURE, SEALING THE JOINTS, LINE ENTRY AND EXIT POINTS (NON-SHRINK GROUT WITH

D. CARTRIDGE INSTALLATION, BY CONTECH, SHALL OCCUR ONLY AFTER SITE HAS BEEN STABILIZED AND THE JELLYFISH UNIT IS CLEAN AND FREE OF DEBRIS. CONTACT CONTECH TO COORDINATE CARTRIDGE INSTALLATION WITH SITE STABILIZATION



JELLYFISH JFPD0806 STANDARD DETAIL PEAK DIVERSION CONFIGURATION

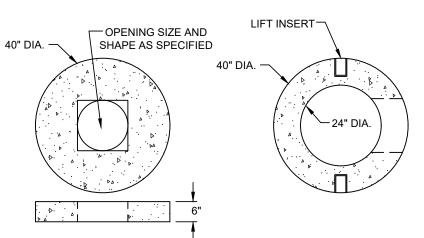

AVAILABLE TOP SLABS

DIM 'B' EST. WEIGHT

60" 4,343 LBS


	_		
12"	825 LBS	<u> </u>	
18"	1,235 LBS		
24"	1,645 LBS		
30"	2,055 LBS		
36"	2,470 LBS		
42"	2,880 LBS	20° MAX,	(//////////////////////////////////////
48"	3,290 LBS		F\$//////////
54"	3,700 LBS		<u> </u>
60"	4,115 LBS		CAST IRON
	1,110 250	DROP INLET RISER	EDAME O
	1,110 230	DROP INLET RISER	FRAME & GRATE
DIM 'A'	EST. WEIGHT		
		8"	
DIM 'A'	EST. WEIGHT	8"	
DIM 'A'	EST. WEIGHT	8" MORTARED OR BOOTED CONNECTION	
DIM 'A' 24" 30"	EST. WEIGHT 1,880 LBS 2,290 LBS	8" MORTARED OR BOOTED CONNECTION	
DIM 'A' 24" 30" 36"	EST. WEIGHT 1,880 LBS 2,290 LBS 2,700 LBS	O MORTARED OR BOOTED CONNECTION	

DROP INLET BASE

GENERAL NOTES

- 1. CONCRETE: Fc = 4,000 PSI AT 28 DAYS MINIMUM. 2. DESIGN LOADING: AASHTO-HS20-44.
- 3. SUMP SHALL BE 2 FT.

YARD DRAIN DETAIL NOT TO SCALE

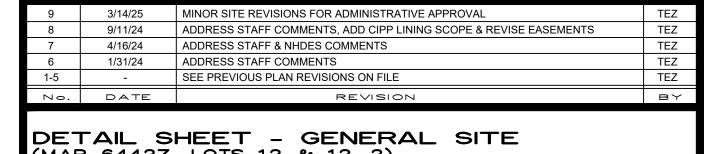

DRAWING

SD-3

DATE: 02/19 PAGE: 1

5, 7, 9, II & I3 STICKNEY AVENUE

CONCORD, NEW HAMPSHIRE PREPARED FOR:

670 N. COMMERCIAL STREET, SUITE 303 MANCHESTER, NEW HAMPSHIRE RECORD OWNER:

STICKNEY AVENUE, LLC

SCALE AS SHOWN

20 JULY 2022




131 Middlesex Turnpike


Burlington, MA 01803 (781) 203-1501 (603) 883-2057 www.hayner-swanson.com

3 Congress Street Nashua, NH 03062 DRAWING NAME: 5800-SITE DET1 FIELD BOOK: 1262

DRAWING LOC: J: \5000\5800\DWG\5800 SITE


SD1_Storm Drain Trench.dwg

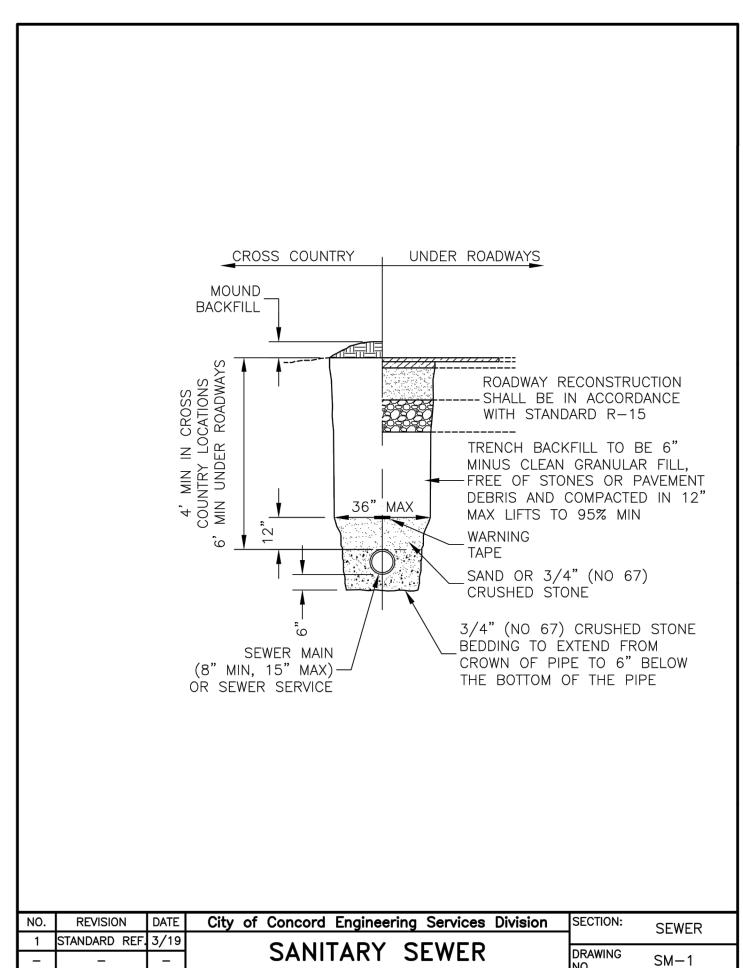

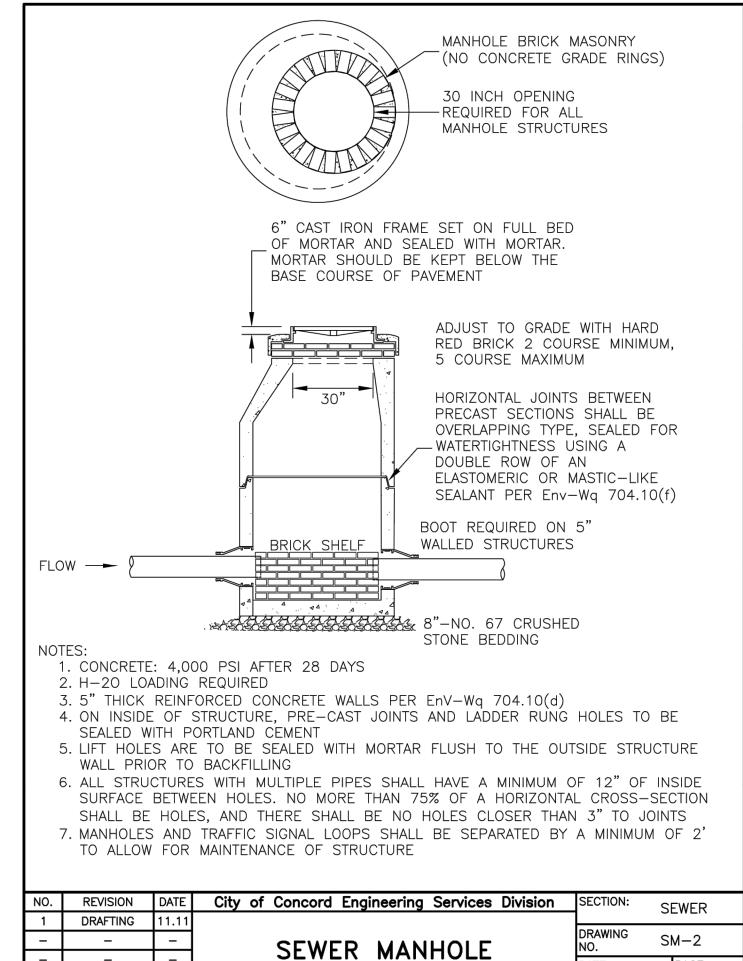

PRIOR TO CONSTRUCTION THE CONTRACTOR SHALL SUBMIT SHOP DRAWINGS AND PRODUCT MATERIAL SPECIFICATIONS TO THE ENGINEER FOR REVIEW AND APPROVAL. CASING SPACER - RUBBER END SEAL (BWM SS MODEL AS


SPACERS

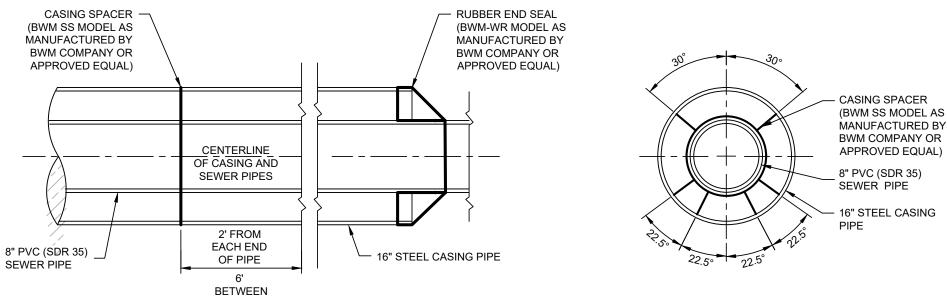

CONDUCT LEAKAGE TEST PRIOR TO RUBBER END SEAL INSTALLATION

SEWER INSTALLATION IN STEEL CASING PIPE DETAIL


NOT TO SCALE

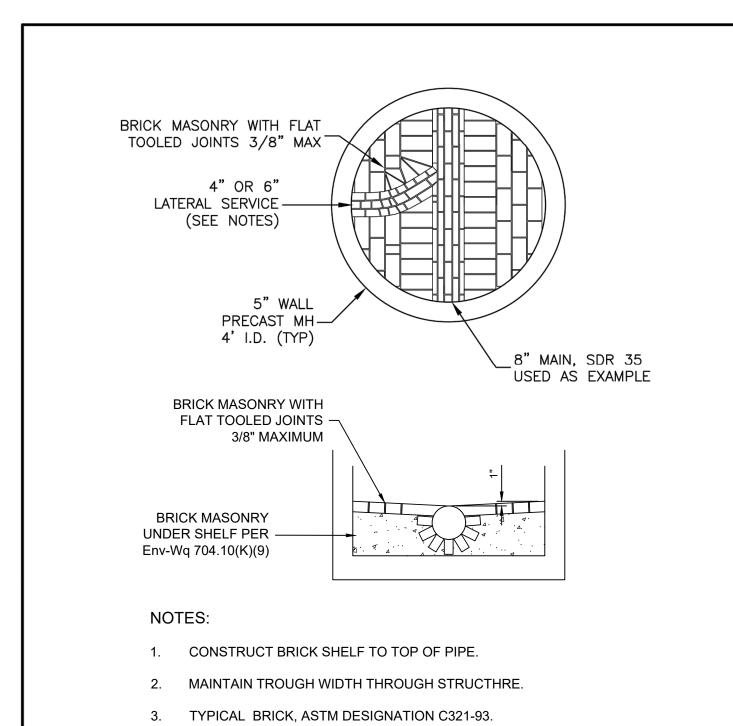


MAIN/SERVICE TRENCH


DATE: 08/13 PAGE:

SM2_SEWR-Manhole_3.dwg

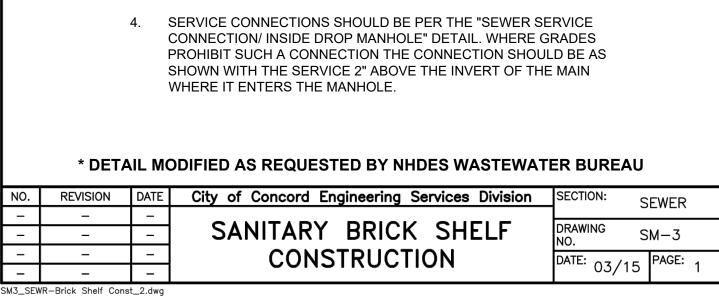


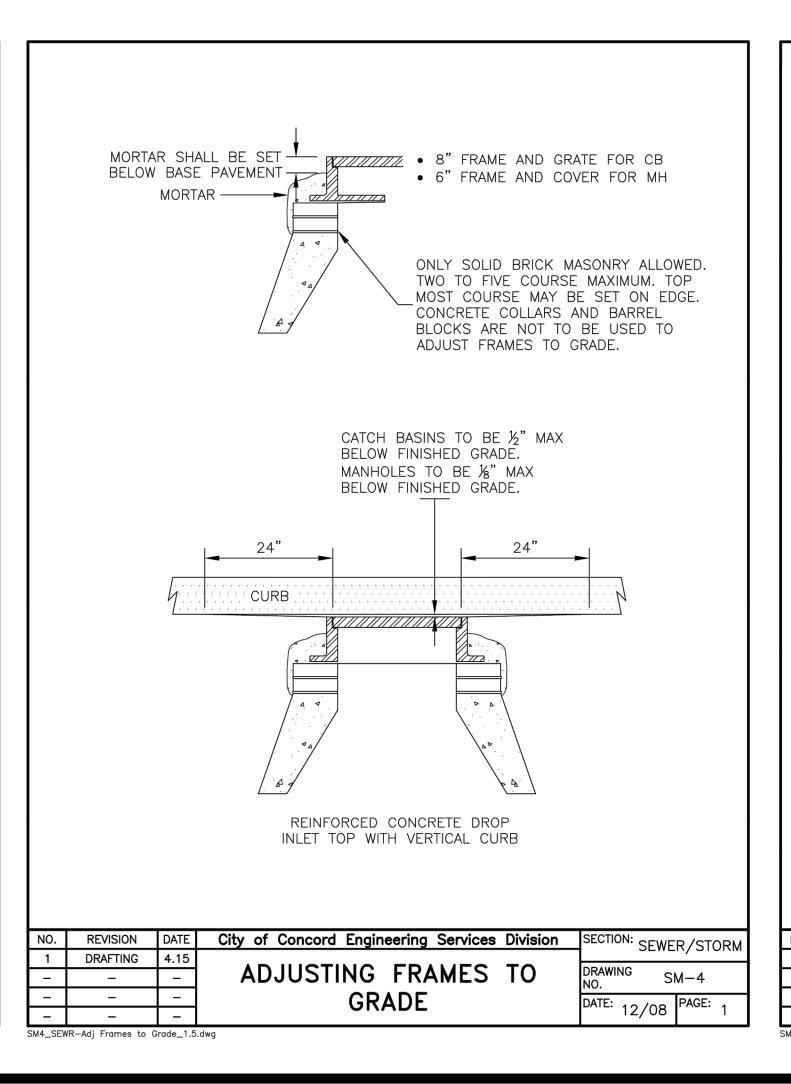


DATE: 12/08 PAGE:

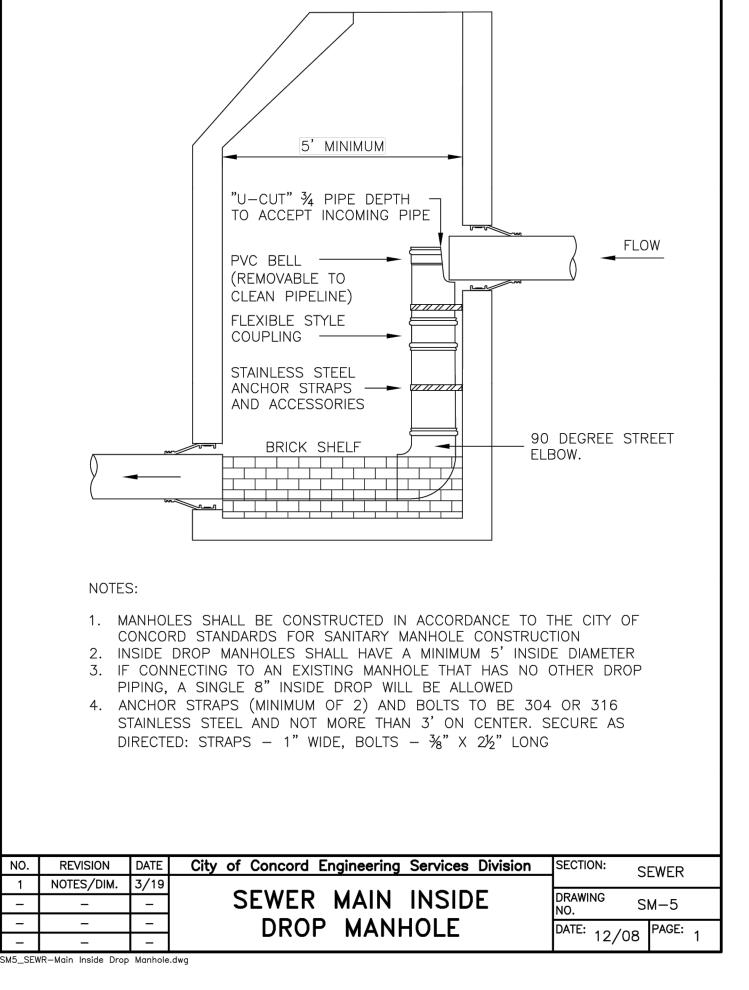



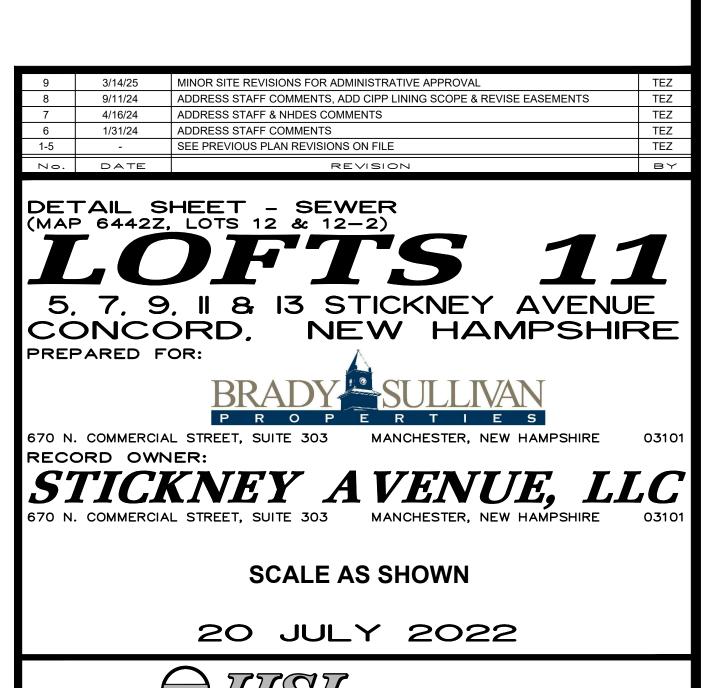

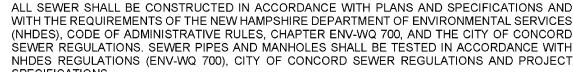

SANITARY SEWER NOTES:

WITH THE REQUIREMENTS OF THE NEW HAMPSHIRE DEPARTMENT OF ENVIRONMENTAL SERVICES (NHDES), CODE OF ADMINISTRATIVE RULES, CHAPTER ENV-WQ 700, AND THE CITY OF CONCORD SEWER REGULATIONS. SEWER PIPES AND MANHOLES SHALL BE TESTED IN ACCORDANCE WITH NHDES REGULATIONS (ENV-WQ 700), CITY OF CONCORD SEWER REGULATIONS AND PROJECT

SPECIFICATIONS. SEWERS SHALL BE LOCATED AT LEAST 10 FEET HORIZONTALLY AND 18 INCHES VERTICALLY FROM WATER LINES.

WHENEVER SEWERS MUST CROSS WATER MAINS, SEWER SHALL BE CONSTRUCTED AS FOLLOWS: [A] SEWER PIPE SHALL BE CLASS 52 DUCTILE IRON FOR A MINIMUM DISTANCE OF 9 FEET EACH SIDE OF THE CROSSING.

SEWER PIPE SHALL BE SOLID WALL-PVC UNLESS OTHERWISE REQUIRED BY THESE


[B] JOINTS SHALL BE MECHANICAL TYPE WATER PRESSURE RATED WITH ZERO LEAKAGE WHEN TESTED AT 25 POUNDS PER SQUARE INCH FOR GRAVITY SEWERS AND 1-1/2 TIMES WORKING PRESSURE FOR FORCE MAINS. JOINTS SHALL NOT BE LOCATED

WITHIN 9 FEET OF THE CROSSING. [C] VERTICAL SEPARATION OF THE SEWER AND WATER MAIN SHALL NOT BE LESS THAN

THE SEWER CONNECTIONS SHALL BE INSPECTED BY AUTHORIZED CITY OF CONCORD PUBLIC WORKS AND ENGINEERING DEPARTMENT PERSONNEL BEFORE ANY BACKFILLING. INSPECTION HOURS ARE BETWEEN 9:00 AM AND 4:30 PM, MONDAY - FRIDAY, WITH AT LEAST 2 DAYS OF ADVANCE NOTICE.

NO FOUNDATION DRAINS OR ROOF DRAINS OR OTHER "NON-SANITARY DRAINS" SHALL BE CONNECTED TO THE MUNICIPAL SEWER.

A MANDATORY PRE-CONSTRUCTION MEETING SHALL BE HELD WITH THE CITY, CONTRACTOR, OWNER AND ALL UTILITY REPRESENTATIVES PRIOR TO ANY CONSTRUCTION. NO WORK SHALL BEGIN UNTIL APPROVAL BY THE DEPARTMENT OF PUBLIC WORKS HAS BEEN OBTAINED.

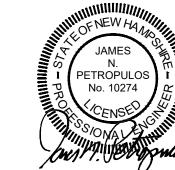

© Hayner/Swanson, Inc.

SM1_SEWR-Trench_3.dwg

DRAWING NAME: 5800-SITE DET1 DRAWING LOC: J: \5000\5800\DWG\5800 SITE

www.havner-swanson.com

3 Congress Street

Nashua, NH 03062

(603) 883-2057

FIELD BOOK: 1262


Havner/Swanson. Inc.


131 Middlesex Turnpike


Burlington, MA 01803


(781) 203-1501

21 OF 24

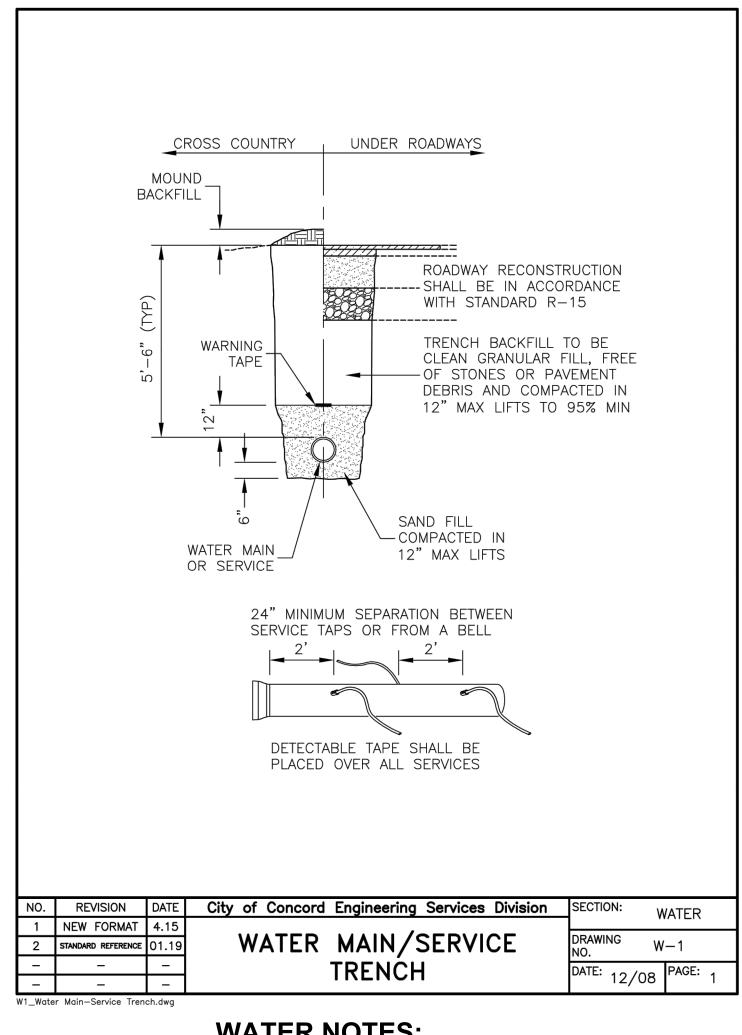

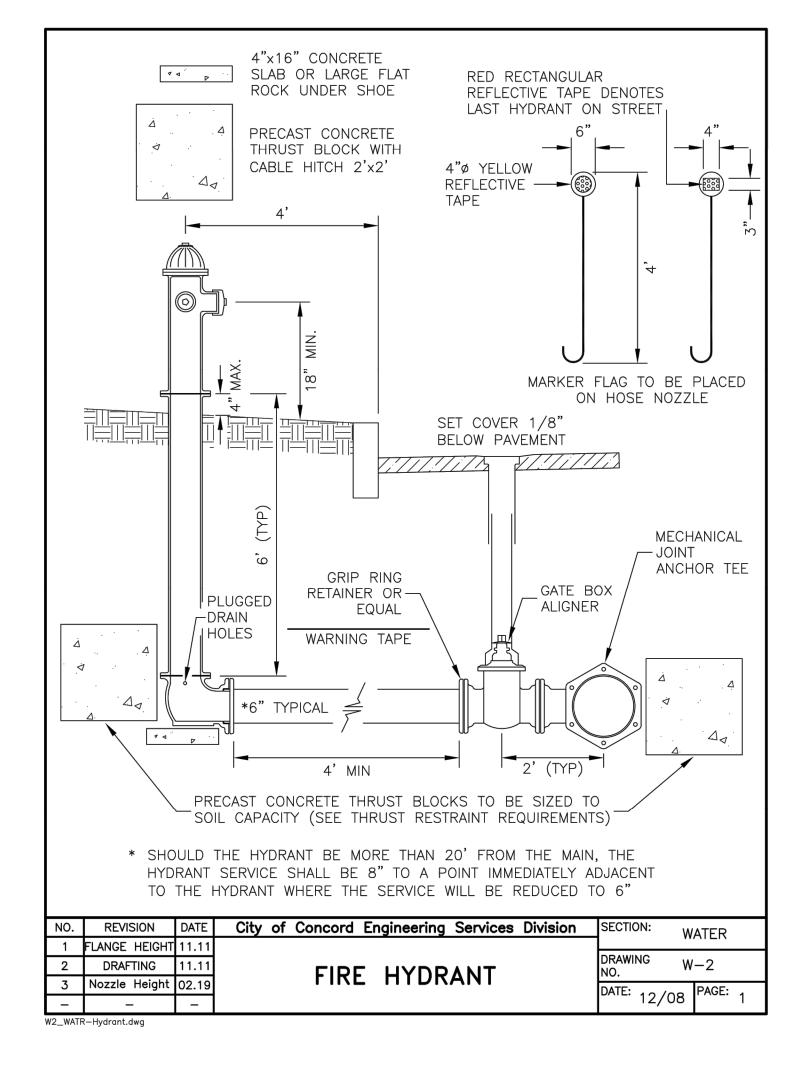

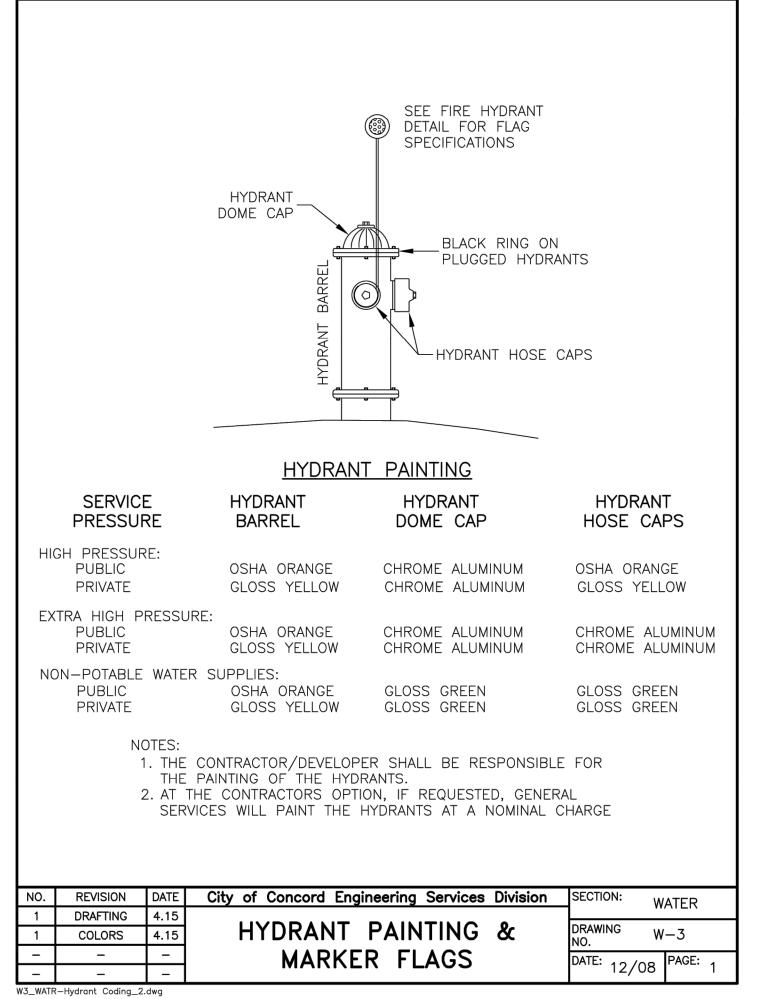

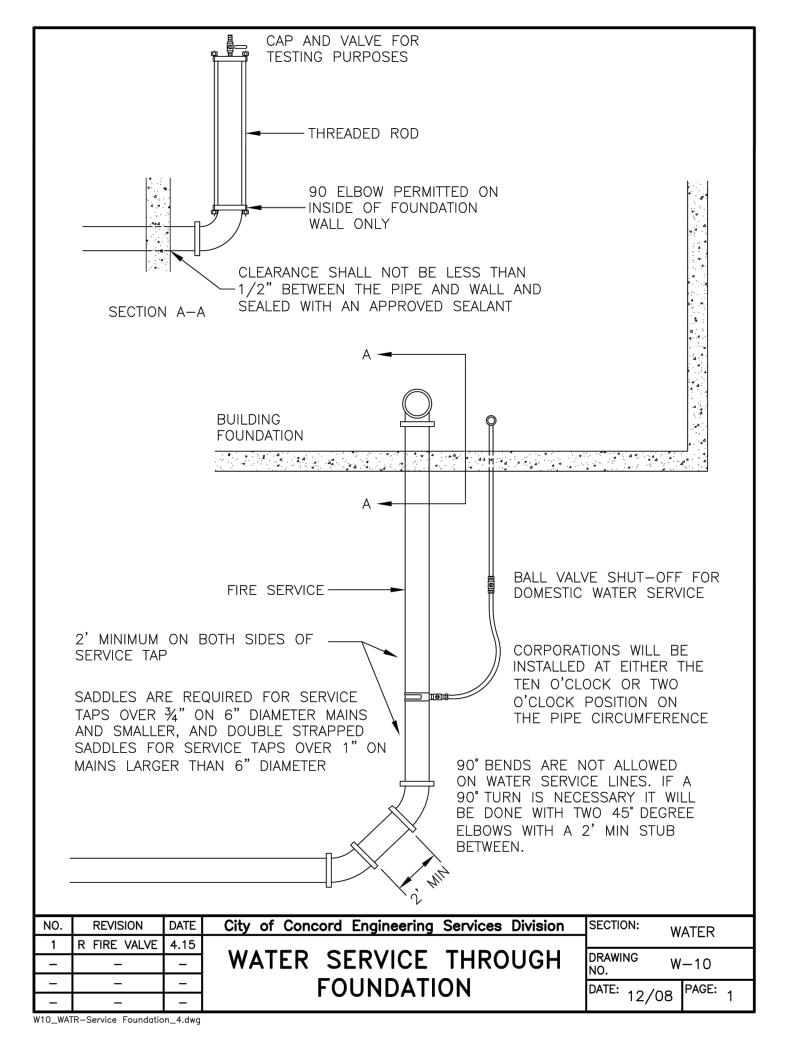


WATER NOTES:

- REFERENCE CITY OF CONCORD CONSTRUCTION STANDARDS AND DETAILS FOR INSTALLATION OF ALL WATER LINES.
- ALL SPRINKLER AND DOMESTIC LEADS TO BUILDING SHALL END 5'-0" OUTSIDE THE FACE OF BUILDING WALL, UNLESS NOTED, AND SHALL BE PROVIDED WITH A TEMPORARY PLUG AT END (FOR OTHERS TO REMOVE AND EXTEND AS NECESSARY).
- THRUST BLOCKS AND MEGALUG RESTRAINTS SHALL BE PROVIDED AT ALL HORIZONTAL BENDS, TEES, AND FIRE HYDRANTS. SEE DETAIL.
- MINIMUM COVER ON ALL WATER LINES IS 5'-6". 5. CONTRACTOR SHALL MAINTAIN A 5'-0" HORIZONTAL (UNLESS OTHERWISE NOTED) AND 12" VERTICAL SEPARATION BETWEEN WATER SERVICE AND UTILITIES OTHER THAN SANITARY SEWER.
- INSPECTIONS ON WATER SERVICE INSTALLATION DURING CONSTRUCTION IS THE RESPONSIBILITY OF THE SITE CONTRACTOR AND SHALL BE COORDINATED WITH CITY OF CONCORD GENERAL SERVICES, AND ALL
- CONTRACTOR SHALL HAVE BACTERIOLOGICAL AND PRESSURE TESTING PERFORMED. CONTRACTOR SHALL GIVE CITY OF CONCORD GENERAL SERVICES A COPY OF RESULTS. MANCHESTER WATER WORKS SHALL BE
- 8. ALL PIPE, VALVES, MISCELLANEOUS MATERIALS AND INSTALLATION SHALL CONFORM WITH CITY OF CONCORD CONSTRUCTION STANDARDS AND DETAILS. ALL DUCTILE IRON PIPE SHALL BE WRAPPED IN 8 MIL POLYETHYLENE PER AWWA SPECIFICATIONS.
- 9. ALL FIRE HYDRANTS, VALVES, FITTINGS, PIPES, ETC. SHALL BE IN ACCORDANCE WITH CITY OF CONCORD CONSTRUCTION STANDARDS AND DETAILS
- 10. METALLIC TAPE OR DETECTOR WIRE SHALL BE INSTALLED IN THE SAME TRENCH WITH ALL NONMETALLIC PIPE SUCH THAT THE PIPE MAY BE LOCATED WITH ELECTRONIC LOCATING EQUIPMENT. DETECTOR WIRE OR METALLIC TAPE SHALL BE INSTALLED APPROXIMATELY 12" TO 18" BELOW GRADE DIRECTLY ABOVE THE TOP OF THE PIPE. DETECTOR WIRE SHALL BE 14 - GAUGE SOLID COPPER, SIMPLEX BW3001, OR EQUAL. METALLIC TAPE SHALL BE 2" MINIMUM METALIZED TAPE, GRIFFOLYN COMPANY, INC. TERRATAPE OR EQUAL.
- 11. CONTRACTOR SHALL ENSURE ALL WATER VALVES ARE IN A FULLY-OPEN POSITION UPON COMPLETION OF PROJECT.

INSPECTION FEES SHALL BE PAID BY THE CONTRACTOR.


12. CONTRACTOR SHALL COORDINATE ALL WATER INTERRUPTIONS WITH THE CITY OF CONCORD GENERAL SERVICES AND AFFECTED PROPERTY OWNERS

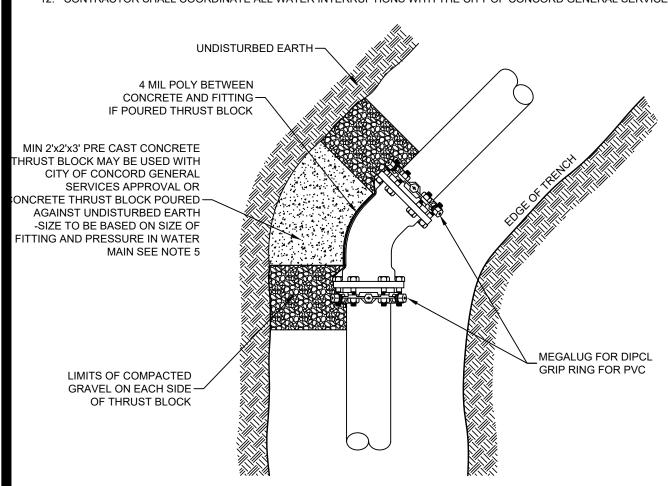

- 1. ALL MATERIAL AND INSTALLATION PROCEDURES WILL CONFORM TO CITY OF CONCORD CONSTRUCTION STANDARDS AND DETAILS.
- 2. ALL PIPE SHOULD HAVE A MINIMUM DEPTH 5'-6" FROM TOP OF PIPE TO FINISH GRADE. 3. 3/4"Ø S.S. RODS SHALL BE USED IN CONJUNCTION WITH REQUIRED S.S. NUTS. RODS ARE TO BE
- ATTACHED TO FITTINGS WITH EITHER STAR BOLTS OR DUC LUGS. 10" FITTING OR SMALLER = (2) 3/4"Ø S.S. RODS & ASSOC. HARDWARE
- 12" FITTING OR LARGER = (4) 3/4"Ø S.S. RODS & ASSOC. HARDWARE 4. MIN 2'x2'x3' PRE CAST CONCRETE THRUST BLOCK MAY BE USED WITH CITY OF CONCORD
- GENERAL SERVICES APPROVAL OR CONCRETE THRUST BLOCK POURED AGAINST UNDISTURBED EARTH - SIZE TO BE BASED ON SIZE OF FITTING AND PRESSURE IN WATER MAIN.
- 5. VOID BETWEEN PRECAST THRUST BLOCK AND VIRGIN SOIL TO BE FILLED AND CHINKED WITH

TYPICAL THRUST BLOCK BEHIND FITTINGS INSTALLATION

NOT TO SCALE

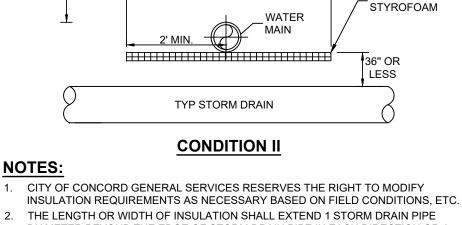

*`*Y\Y\Y\Y\Y\Y\Y\Y\Y\Y\Y\Y\Y\Y\Y\

TYP STORM DRAIN

CONDITION I

WATER MAIN-

FINISH GRADE

2" BLUE DOW

STYROFOAM

FINISH GRADE


DIAMETER BEYOND THE EDGE OF STORM DRAIN PIPE IN EACH DIRECTION OR A

3. ALL BUTT JOINT SEAMS TO BE OVERLAPPED WITH A 1'-0" PIECE OF INSULATION

MINIMUM OF 2' BEYOND THE CENTERLINE OF THE STORM DRAIN PIPE, WHICHEVER

STORM DRAIN / WATER MAIN **INTERSECTION RUNS - ELEV. VIEW**

NOT TO SCALE

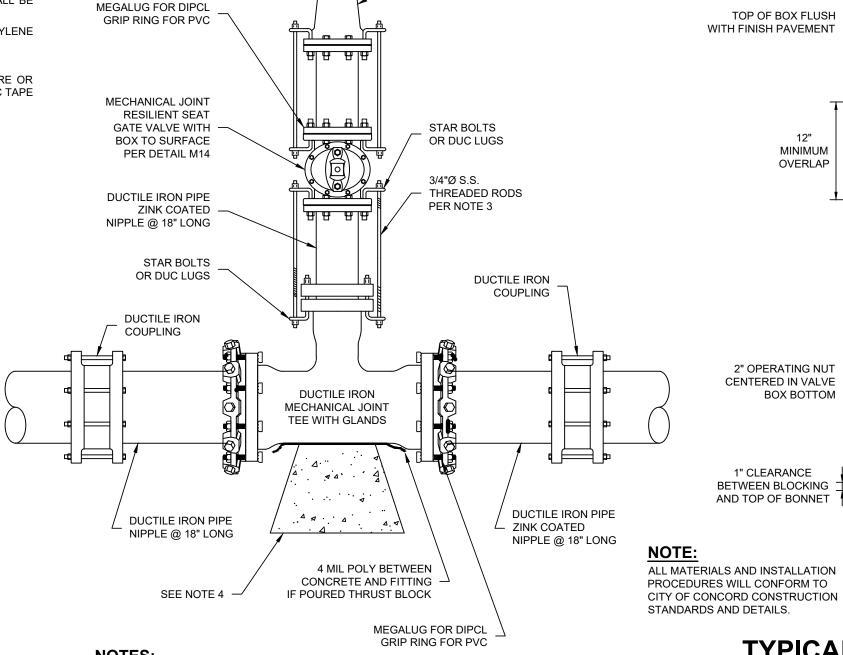

MECHANICAL JOINT

- REDUCER RODDED


TO GATE VALVE

ALL MATERIAL AND INSTALLATION PROCEDURES WILL CONFORM TO CITY OF CONCORD CONSTRUCTION STANDARDS AND DETAILS.

- ALL PIPE SHOULD HAVE A MINIMUM DEPTH OF 5'-6" FROM TOP OF PIPE TO FINISH GRADE. 3/4"Ø S.S. RODS SHALL BE USED IN CONJUNCTION WITH REQUIRED S.S. NUTS. RODS ARE
- TO BE ATTACHED TO FITTINGS WITH EITHER STAR BOLTS OR DUC LUGS. 10" FITTING OR SMALLER = (2) 3/4"Ø S.S. RODS & ASSOC. HARDWARE. 12" FITTING OR LARGER = (4) 3/4"Ø S.S. RODS & ASSOC. HARDWARE. MIN 2'x2'x3' PRE CAST CONCRETE


THRUST BLOCK MAY BE USED WITH P.W.W. APPROVAL OR CONCRETE THRUST BLOCK POURED AGAINST UNDISTURBED EARTH - SIZE TO BE BASED ON SIZE OF FITTING AND PRESSURE IN WATER MAIN. SEE DETAIL M10. TYPICAL TEE INSTALLATION


ON EXISTING MAIN

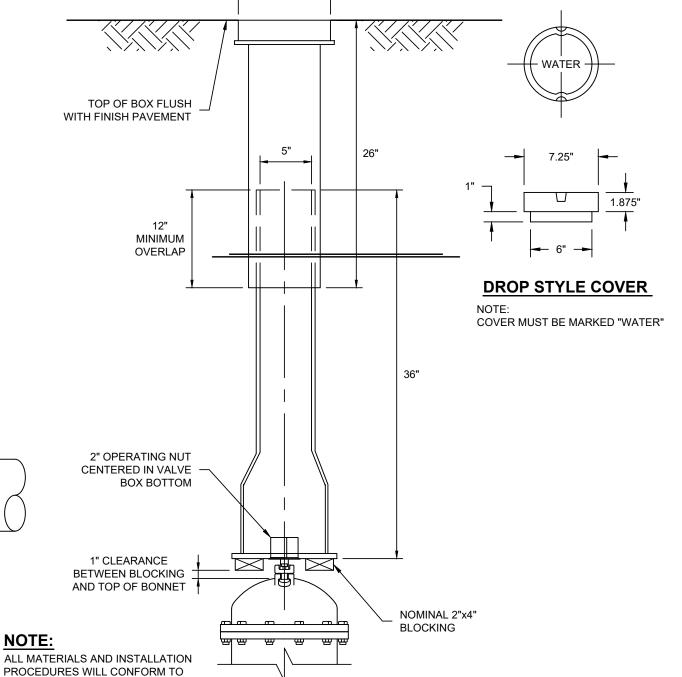

TYPICAL VALVE BOX DETAIL

BOTTOM DETAIL

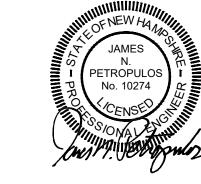

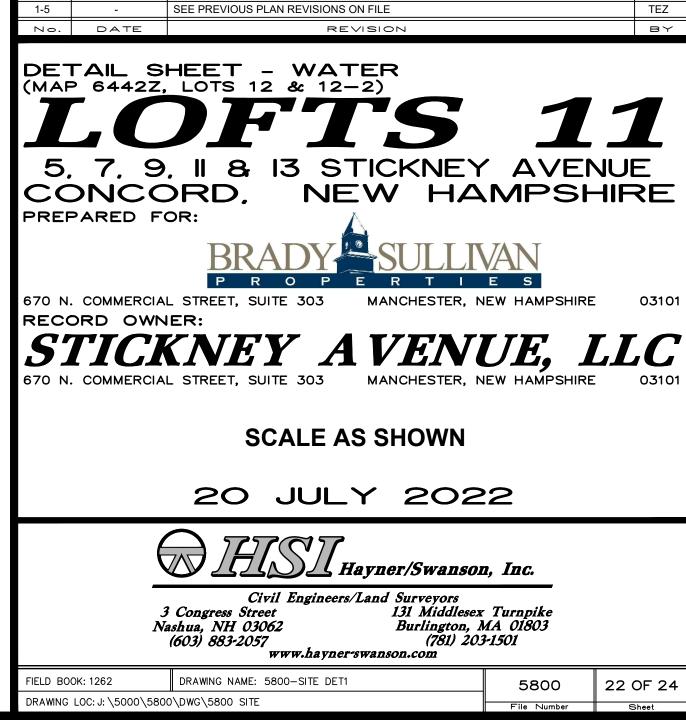

MINOR SITE REVISIONS FOR ADMINISTRATIVE APPROVA

ADDRESS STAFF & NHDES COMMENTS

ADDRESS STAFF COMMENTS

4/16/24

ADDRESS STAFF COMMENTS, ADD CIPP LINING SCOPE & REVISE EASEMENTS

© Hayner/Swanson, Inc.

